

NTS

General Notes

1. It is the responsibility of the Contractor to coordinate the work of all trades, (including those trades that may be under separate contract), scheduling, and overall cleanup. 2. The Construction Documents are supplied to illustrate the design and

general type of construction desired and are intended to imply the finest quality of construction, materials and workmanship throughout. 3. The Contractor, upon acceptance of the Construction Documents, assumes full responsibility for the construction, materials, and workmanship of the work described therein; and shall execute the work of the contract to comply with the spirit as well as the letter in which it was written. In order to discover and resolve any lack of definition or conflicts which might create construction problems, the Contractor shall thoroughly examine the Construction Documents and the existing conditions of the job site and submit a written report to the Architect within 15 days after receipt

of the documents. Beginning of work indicates acceptance of the documents. 4. The Contractor shall maintain a current and complete set of construction documents during all phases for use by all trades, and will remove

superseded documents from the job site. 5. The Contractor is responsible to provide, as required to do the work, all temporary utilities, temporary enclosures to protect the work, tree and plant protection, barricades, security, and special protection such as dust control and noise control.

6. Upon completion, all work shall be cleaned by the Contractor and will include removal of all spots, stains, and paint drippings, etc.

7. No extras will be permitted unless submitted in writing by the Contractor and approved in writing by the Owner and the Architect. 8. The General Contractor shall be responsible for complying with all building codes, ordinances and regulation governing the work of this

9. The General Contractor and all Sub-contractors hereby indemnify and agree to defend and hold the Owner and Architect harmless from and against any and all suits, claims, actions, loss, cost or expense arising out

of the contract work. 10. All Contractors shall be held responsible to have verified all dimensions and existing conditions before proceeding with the work. Any errors, omissions, discrepancies, or questionable items in the contract documents shall be immediately brought to the attention of the Architect either before

or during construction. 11. In no instance shall working dimensions be scaled from drawings. Figures on drawings govern, and larger scale drawings govern smaller scale drawings. In case of discrepancies between drawings and

Specifications, the Specifications shall govern. 12. The A.I.A General Conditions, latest edition (Document A201) shall be

binding on this contract as if it were reproducd here in full. 13. The General Contractor shall provide sanitary facilities for workers use. No access will be permitted to the existing residence by the General Contractor, his Sub-Contractors and their forces beyond that which is required by the work of this contract. Access to the premises required by the work will be coordinated with the Owner and given with the Owner's

14. The General Contractor shall be responsible for protecting, patching, and repairing all existing areas and work adjacent to his work or damaged as a result of his work at his own expense and at no additional cost to the Owner.

15. All material shall be new and delivered to the site in its original

16. The Architect shall have access to the job site at all times, and to the factory or shop of any of the Sub-contractors. Any inferior material or workmanship shall be removed upon demand and work shall be reconstructed as approved by the Architect at the Contractor's sole

General Notes

17. The Contractor shall perform all demolition and removal and related work described in the Contract Documents, and reasonably inferred as necessary to complete the work. 18. The General Contractor shall maintain existing utilities in operation during the performance of his work.

19. The Contractor shall provide centrally located benchmarks for use by all trades. 20. Drawing dimension are to finished walls, joint centerlines, or

structural centerlines unless specifically noted otherwise. 21. The General Contractor shall be responsible for obtaining soil bearing testing performed by a licensed engineer; and shall report the findings to the Architect prior to foundation work.

Abbreviations

OC

PL LAM

R/RAD

R&S

RO

REQ'D

SIM T.O.P

T.O.S.

TYP VIF WD

AFF B.O. CAB CT ABOVE FINISHED FLOOR **BOTTOM OF** CABINET **CERAMIC TILE** CL/CLOS CLG CLOSET **CEILING** CMU CONCRETE MASONRY UNIT CONC CONCRETE CONT CONTINUOUS DIM DWG EL/ELEV DIMENSION DRAWING **ELEVATION** EQ EQUAL **EQUIP EQUIPMENT EXTG EXISTING** FIN **FINISHED** FLR FLOOR GC GWB GENERAL CONTRACTOR GYPSUM WALL BOARD INSUL INT INSULATION INTERIOR LAV LAVATORY MEDICINE CABINET MIN MINIMUM MTD MTL NIC MOUNTED METAL NOT IN CONTRACT

ON CENTER

PAINTED

RADIATOR

REQUIRED

SIMILAR

ROD & SHELF

TOP OF PLATE

VERIFY IN FIELD

TOP OF SLAB

TYPICAL

WOOD

ROUGH OPENING

PLASTIC LAMINATE

Materials / Symbols

Existing Masonry Wall **New Partition** Concrete Masonry Unit Welded Wire Mesh * * * * * * * * Plywood Finish Wood Batt Insulation Rigid Insulation Interior Elevation Door Number

Window Number

Centerline

Project Data

741 Route 32 Project Address: Wallkill, New York Jim & JoAnn Redner 741 Route 32 Walikill, NY Aryeh Siegel, Architect 84 Mason Circle, Beacon, New York 12508 2020 Residential Code of NYS Compliance:

Zone: R1 (Single Family) Tax Map No .: 4-2-39.1

STATE.

NOTES: THE WORK OF THIS PROJECT IS FILED UNDER THE 2020 RESIDENTIAL CODE OF NY

Drawing List

A-301

Cover Sheet Demolition Plan D-101 A-101 First Floor Plan & RCP A-102 Framing Plan & Roof Plan A-201 Elevations A-202 Elevations

Building Sections

Redner Residence

741 Route 32 Wallkill, New York

1	January 20, 2021	Building Permit Application
Number	Date	Revision

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Cover Sheet

Date: December 4, 2020

Drawing Number:

SECTION 024119 - SELECTIVE DEMOLITION

PART 1 - GENERAL

- 1.1 SECTION REQUIREMENTS
- A. ITEMS INDICATED TO BE REMOVED AND SALVAGED REMAIN OWNER'S PROPERTY. CAREFULLY DETACH FROM EXISTING CONSTRUCTION, IN A MANNER TO PREVENT DAMAGE, AND DELIVER TO OWNER[READY FOR REUSE]. INCLUDE FASTENERS OR BRACKETS NEEDED FOR REATTACHMENT ELSEWHERE.
- B. PREDEMOLITION PHOTOGRAPHS: SHOW EXISTING CONDITIONS OF ADJOINING CONSTRUCTION AND SITE IMPROVEMENTS. SUBMIT BEFORE WORK BEGINS.
- C. OWNER WILL OCCUPY PORTIONS OF BUILDING IMMEDIATELY ADJACENT TO SELECTIVE DEMOLITION AREA. CONDUCT SELECTIVE DEMOLITION SO OWNER'S OPERATIONS WILL NOT BE DISRUPTED.
- D. IT IS NOT EXPECTED THAT HAZARDOUS MATERIALS WILL BE ENCOUNTERED IN THE WORK. IF HAZARDOUS MATERIALS ARE ENCOUNTERED, DO NOT DISTURB; IMMEDIATELY NOTIFY ARCHITECT AND OWNER. HAZARDOUS MATERIALS WILL BE REMOVED BY OWNER UNDER A SEPARATE CONTRACT.

PART 2 - PRODUCTS

- 2.1 PEFORMANCE REQUIREMENTS
- A. REGULATORY REQUIREMENTS: COMPLY WITH EPA REGULATIONS AND WITH HAULING AND DISPOSAL REGULATIONS OF AUTHORITIES HAVING JURISDICTION.


PART 3 - EXECUTION

3.1 DEMOLITION

- A. MAINTAIN SERVICES/SYSTEMS INDICATED TO REMAIN AND PROTECT THEM AGAINST DAMAGE DURING SELECTIVE DEMOLITION OPERATIONS. BEFORE PROCEEDING WITH DEMOLITION, PROVIDE TEMPORARY SERVICES/SYSTEMS THAT BYPASS AREA OF SELECTIVE DEMOLITION AND THAT MAINTAIN CONTINUITY OF SERVICES/SYSTEMS TO OTHER PARTS OF THE BUILDING.
- B. LOCATE, IDENTIFY, SHUT OFF, DISCONNECT, AND SEAL OR CAP OFF INDICATED UTILITY SERVICES AND MECHANICAL/ELECTRICAL SYSTEMS SERVING AREAS TO BE SELECTIVELY DEMOLISHED.
- C. PROVIDE TEMPORARY BARRICADES AND OTHER PROTECTION REQUIRED TO PREVENT INJURY TO PEOPLE AND DAMAGE TO ADJACENT BUILDINGS AND FACILITIES TO REMAIN.
- D. PROVIDE AND MAINTAIN SHORING, BRACING, AND STRUCTURAL SUPPORTS AS REQUIRED TO PRESERVE STABILITY AND PREVENT MOVEMENT, SETTLEMENT, OR COLLAPSE OF CONSTRUCTION AND FINISHES TO REMAIN, AND TO PREVENT UNEXPECTED OR UNCONTROLLED MOVEMENT OR COLLAPSE OF CONSTRUCTION BEING DEMOLISHED.
- E. PROVIDE TEMPORARY WEATHER PROTECTION TO PREVENT WATER LEAKAGE AND DAMAGE TO STRUCTURE AND INTERIOR AREAS.
- F. REQUIREMENTS FOR BUILDING REUSE:
- MAINTAIN EXISTING BUILDING STRUCTURE (INCLUDING STRUCTURAL FLOOR AND ROOF DECKING) AND ENVELOPE (EXTERIOR SKIN AND FRAMING, EXCLUDING WINDOW ASSEMBLIES AND NONSTRUCTURAL ROOFING MATERIAL) NOT INDICATED TO BE DEMOLISHED; DO NOT DEMOLISH SUCH EXISTING CONSTRUCTION BEYOND INDICATED LIMITS.
- 2. MAINTAIN EXISTING INTERIOR NONSTRUCTURAL ELEMENTS (INTERIOR WALLS, DOORS, FLOOR COVERINGS, AND CEILING SYSTEMS) NOT INDICATED TO BE DEMOLISHED; DO NOT DEMOLISH SUCH EXISTING CONSTRUCTION BEYOND INDICATED LIMITS.
- I. NEATLY CUT OPENINGS AND HOLES PLUMB, SQUARE, AND TRUE TO DIMENSIONS REQUIRED. USE CUTTING METHODS LEAST LIKELY TO DAMAGE CONSTRUCTION TO REMAIN OR ADJOINING CONSTRUCTION.
- J. REMOVE DEMOLITION WASTE MATERIALS FROM PROJECT SITE[AND LEGALLY DISPOSE OF THEM IN AN EPA-APPROVED LANDFILL]. DO NOT BURN DEMOLISHED MATERIALS.
- K. CLEAN ADJACENT STRUCTURES AND IMPROVEMENTS OF DUST, DIRT, AND DEBRIS CAUSED BY SELECTIVE DEMOLITION OPERATIONS.
 RETURN ADJACENT AREAS TO CONDITION EXISTING BEFORE SELECTIVE DEMOLITION OPERATIONS BEGAN.

DEMOLITION NOTE

- IT IS NOT EXPECTED THAT HAZARDOUS MATERIALS WILL BE ENCOUNTERED IN THE WORK. IF MATERIALS SUSPECTED OF CONTAINING HAZARDOUS MATERIALS ARE ENCOUNTERED, DO NOT DISTURB; IMMEDIATELY NOTIFY ARCHITECT AND OWNER. OWNER WILL REMOVE HAZARDOUS MATERIALS UNDER A SEPARATE CONTRACT.
- 2. MAINTAIN SERVICES/SYSTEMS TO REMAIN AND PROTECT THEM AGAINST DAMAGE DURING SELECTIVE DEMOLITION OPERATIONS. BEFORE PROCEEDING WITH DEMOLITION, PROVIDE TEMPORARY SERVICES/SYSTEMS THAT BYPASS AREA OF SELECTIVE DEMOLITION AND THAT MAINTAIN CONTINUITY OF SERVICES/SYSTEMS TO OTHER PARTS OF THE BUILDING.
- 3. THE CONTRACTOR SHALL PERFORM ALL REMOVALS AND RELATED WORK AS SHOWN ON THE DRAWINGS DESCRIBED IN THESE NOTES AND REASONABLY INFERRED AS NECESSARY TO ENSURE A COMPLETE AND CLEAN OPEN SPACE, FREE OF ANY FOREIGN MATTER.
- LOCATE, IDENTIFY, SHUT OFF, DISCONNECT, AND CAP OFF PLUMBING AND UTILITY SERVICES AND MECHANICAL/ELECTRICAL SYSTEMS SERVING AREAS TO BE SELECTIVELY DEMOLISHED.
- 5. PROVIDE TEMPORARY BARRICADES AND OTHER PROTECTION REQUIRED TO PREVENT INJURY TO PEOPLE AND DAMAGE TO ADJACENT BUILDINGS AND FACILITIES TO REMAIN.
- 7. PRIOR TO REMOVAL THE CONTRACTOR IS TO IDENTIFY ALL BUILDING SYSTEMS MATERIALS, INCLUDING PIPES, WIRING, CONDUIT, ETC. QUESTIONS REGARDING IDENTIFICATION SHALL BE ADDRESSED TO THE ARCHITECT AND ENGINEER.
- 8. THE CONTRACTOR SHALL MAINTAIN CLEAR EGRESS TO ALL FIRE STAIRS DURING AND AFTER DEMOLITION.
- CONTRACTOR SHALL CAREFULLY INSPECT ALL EXISTING CONDITIONS TO DETERMINE THE LOCATIONS AND CONDITIONS OF STRUCTURAL MEMBERS, BEARING LINES, ETC. IF CONDITIONS ARE ENCOUNTERED REQUIRING STRUCTURAL ENGINEERING, INFORM THE ARCHITECT AND OWNER IMMEDIATELY, AND THE OWNER WILL RETAIN THE SERVICES OF A N.Y.S. LICENSED STRUCTURAL ENGINEER TO PROVIDE SPECIFICATIONS.
- 10. PROVIDE AND MAINTAIN SHORING, BRACING, AND STRUCTURAL SUPPORTS AS REQUIRED TO PRESERVE STABILITY AND PREVENT MOVEMENT, SETTLEMENT, OR COLLAPSE OF CONSTRUCTION AND FINISHES TO REMAIN OR CONSTRUCTION BEING DEMOLISHED. IT IS THE SOLE RESPONSIBILITY OF THE DEMOLITION CONTRACTOR TO MAINTAIN SAFETY AND STRUCTURAL STABILITY.
- 11. CONTRACTOR SHALL CAREFULLY EXAMINE WALLS SHOWN TO REMAIN TO DETERMINE IF THEY ARE BEARING WALLS CAPABLE OF SUPPORTING THE EXISTING STRUCTURE. IF ADDITIONAL BEARING IS REQUIRED, PROVIDE TEMPORARY FRAMING WITH TOP AND BOTTOM PLATES IN A CONTINUOUS LINE FROM THE BOTTOM TO THE TOP OF THE BUILDING.
- 12. PROVIDE TEMPORARY WEATHER PROTECTION TO PREVENT WATER LEAKAGE AND DAMAGE TO STRUCTURE AND INTERIOR AREAS.
- 13. PROTECT WALLS, CEILINGS, FLOORS, AND OTHER EXISTING FINISH WORK THAT ARE TO REMAIN. ERECT AND MAINTAIN DUSTPROOF PARTITIONS. COVER AND PROTECT FURNITURE, FURNISHINGS, AND EQUIPMENT THAT HAVE NOT BEEN REMOVED.
- 14. NEATLY CUT OPENINGS AND HOLES PLUMB, SQUARE, AND TRUE TO DIMENSIONS REQUIRED. USE CUTTING METHODS LEAST LIKELY TO DAMAGE CONSTRUCTION TO REMAIN OR ADJOINING CONSTRUCTION.
- 15. PROMPTLY REMOVE DEMOLISHED MATERIALS FROM OWNER'S PROPERTY AND LEGALLY DISPOSE OF THEM. DO NOT BURN DEMOLISHED MATERIALS.
- 16. CONTRACTOR SHALL PROVIDE DUST PROTECTION AT POINTS OF DEMOLITION, AND EXISTING AREAS TO REMAIN.
- 17. THE CONTRACTOR SHALL LEGALLY DISPOSE OF REMOVED MATERIAL AND DEBRIS DAILY.
- 18. UPON COMPLETION OF THE DEMOLITION WORK, THE CONTRACTOR SHALL INSURE THAT ALL AREAS BE LEFT BROOM CLEAN.
- 19. PRIOR TO THE COMMENCEMENT OF THE WORK, THE CONTRACTOR SHALL SECURE ALL REQUIRED PERMITS, APPROVALS, ETC. FROM ALL RESPECTIVE DEPARTMENTS, AGENCIES, COMMISSIONS, ETC. HAVING JURISDICTION AND SHALL SUBMIT ONE (1) COPY OF SUCH TO BOTH THE OWNER, THE ARCHITECT AND THE CONSTRUCTION MANAGER EACH.
- 20. ALL WORK SHALL BE PERFORMED IN ACCORDANCE WITH THE BUILDING CODE AND THE RULES AND REGULATIONS OF ALL AGENCIES, DEPARTMENTS, AND COMMISSIONS HAVING JURISDICTION.
- 21. THE CONTRACTOR SHALL EMPLOY MEANS AND METHODS, THAT MINIMIZE VIBRATION NOISE, DUST, POLLUTANTS AND OTHER DISTURBANCES TO OPERATIONS OF EXISTING ADJACENT TENANCIES.
- 22. THE CONTRACTOR SHALL VERIFY ALL EXISTING CONSTRUCTION, CONDITIONS AND DIMENSIONS PRIOR TO COMMENCEMENT OF ANY DEMOLITION OPERATIONS. NO WORK IS TO TAKE PLACE WHICH ALTERS THE BUILDING STRUCTURE OR STRUCTURAL FIRE PROOFING SYSTEMS. THE CONTRACTOR SHALL REPORT ANY DISCREPANCIES TO THE CONSTRUCTION MANAGER PRIOR TO THE START OF THE WORK. COMMENCEMENT OF THE WORK SHALL IMPLY ACCEPTANCE OF ALL EXISTING CONDITION.
- 23. THE CONTRACTOR SHALL PROTECT AND BE RESPONSIBLE FOR SPACES AND ASSEMBLIES ADJACENT TO THE AREA OF OPERATION UNDER THIS CONTRACT. ANY DAMAGE OR DISTURBANCE RESULTING FROM WORK DONE UNDER THIS CONTRACT SHALL BE PROMPTLY RESTORED, REPLACE, OR REPAIRED AT NO EXTRA COST OF THE OWNER.
- 24. ALL EXITS SHALL BE KEPT READILY ACCESSIBLE AND UNOBSTRUCTED AT ALL TIMES.
- 25. SEAL ALL OPENING S UNCOVERED DURING DEMOLITION OF FURRED WALL, RELOCATION OF DUCT SHAFTS OR PIPE CHASES OR REMOVAL OF PARTITIONS OR FIXTURES.

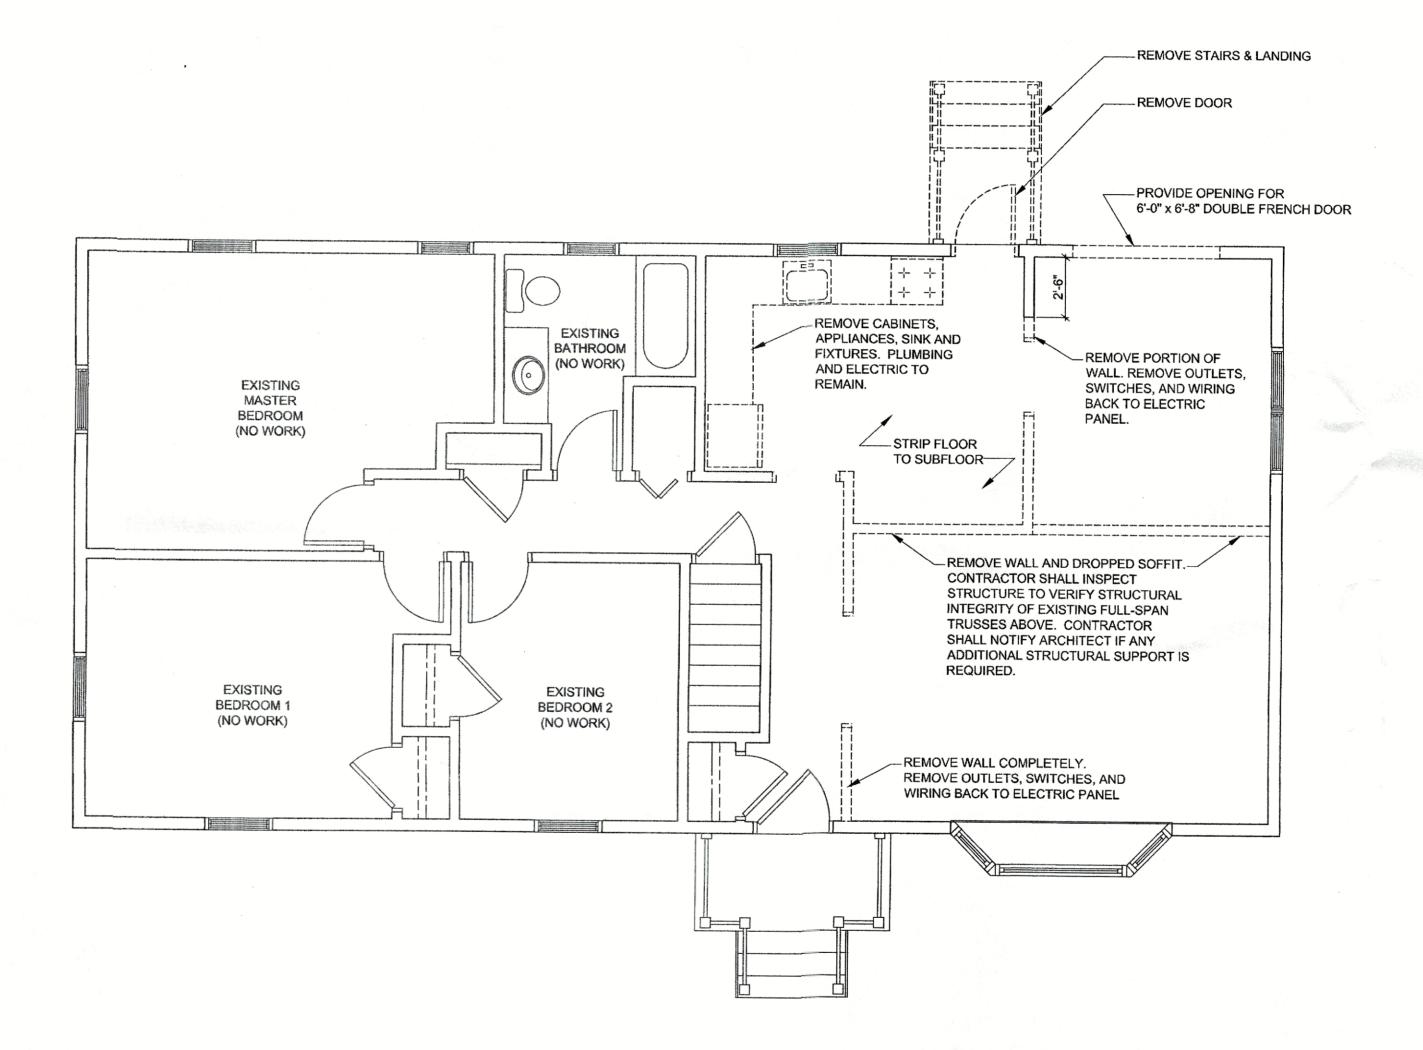

1st Floor Demo Plan

Redner Residence

741 Route 32 Wallkill, New York

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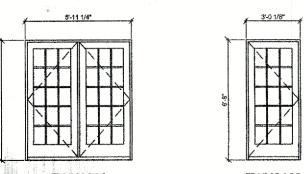
Demo Plan

Date: December 4, 2020

cale: 1/4" = 1'-0" Drawing Number:

	, .		DOOF	RAND	FRAME	SCHEDU			
MARK	WIDTH	HEIGHT	MATERIAL	FRAME	HARDWARE	FIRERATING	MANUFACTURER	MODEL	NOTES
01	3'-0"	6'-8"	WD	WD	-	-	ANDERSON	FWH3168	PROVIDE WEATHER-STRIPPING
02	PR 6'-0"	6'-8"	WD	WD	•	•	ANDERSON	FWH6068	AND WEATHER PROOF SADDLE

DOOR TYPES:





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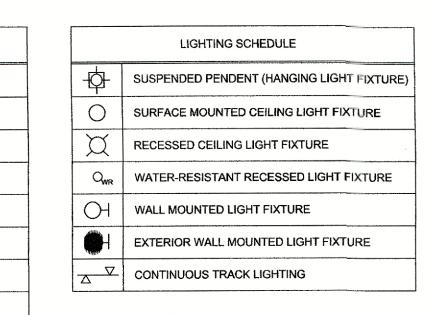
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WINDOW SCHEDULE							
MARK	S	IZE HEIGHT	TYPE	MATERIAL	MANUFACTURER	MODEL	NOTES
100	3'-0"	4'-0"	DOUBLE HUNG	VINYL CLAD	ANDERSEN	TW210310	
101	3'-0"	4'-0"	DOUBLE HUNG	VINYL CLAD	ANDERSEN	TW210310	
102	3'-0"	4'-0"	DOUBLE HUNG	VINYL CLAD	ANDERSEN	TW210310	- Land
103	3'-0"	4'-0"	DOUBLE HUNG	VINYL CLAD	ANDERSEN	TW210310	
104	6'-0"	1'-10"	ARCHED	VINYL CLAD	ANDERSEN	AFFW601	
105	3'-0"	4'-0"	DOUBLE HUNG	VINYL CLAD	ANDERSEN	TW210310	Appear Collection
106	3'-0"	4'-0"	DOUBLE HUNG	VINYL CLAD	ANDERSEN	TW210310	
107	3'-0"	4'-0"	DOUBLE HUNG	VINYL CLAD	ANDERSEN	TW210310	
108	3'-0"	4'-0"	DOUBLE HUNG	VINYL CLAD	ANDERSEN	TW210310	


WINDOW TYPES:





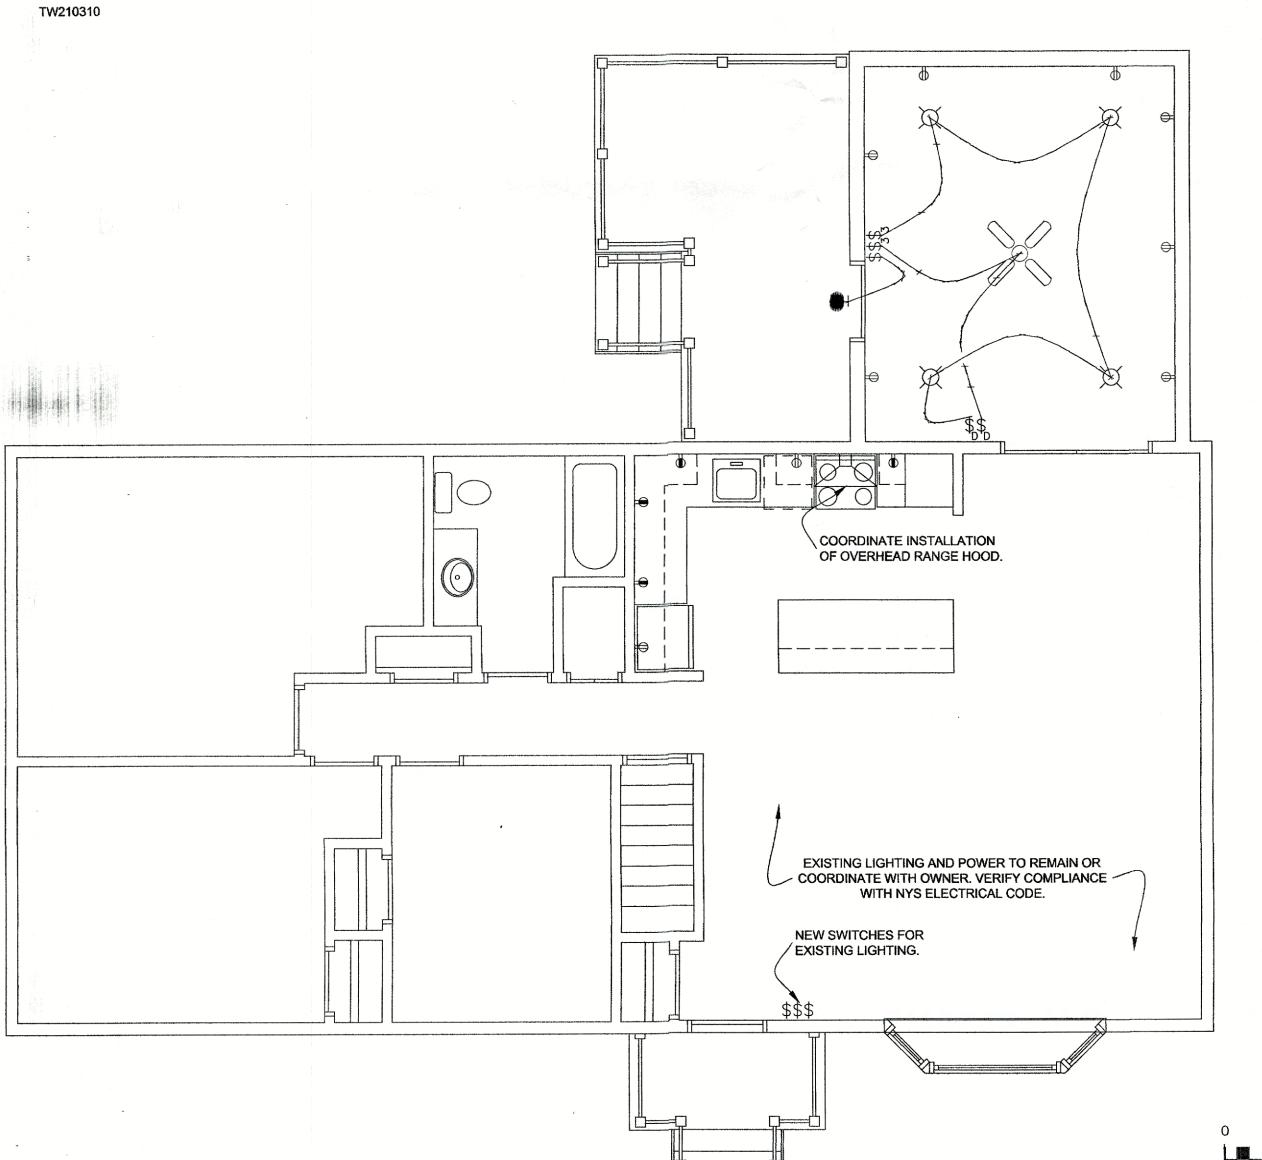

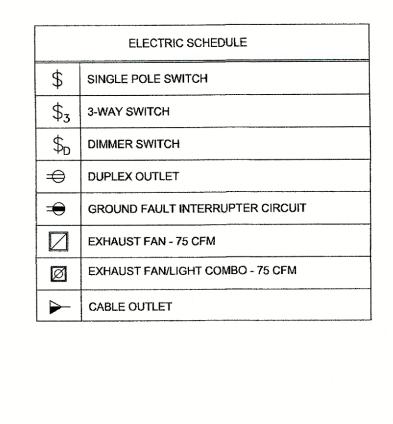FIRE P	FIRE PROTECTION / EMERGENCY EQUIPMENT SCHEDULE				
SD	SMOKE DETECTOR - HARD WIRED WITH BATTERY BACK-UP				
(00)	CARBON MONOXIDE DETECTOR - HARD WIRED WITH BATTERY BACK-UP				
A	EMERGENCY WALL PACK LIGHT				
•	EMERGENCY EXIT SIGN				
→	CODE COMPLIANT PORTABLE FIRE EXTINGUISHER				
	:				

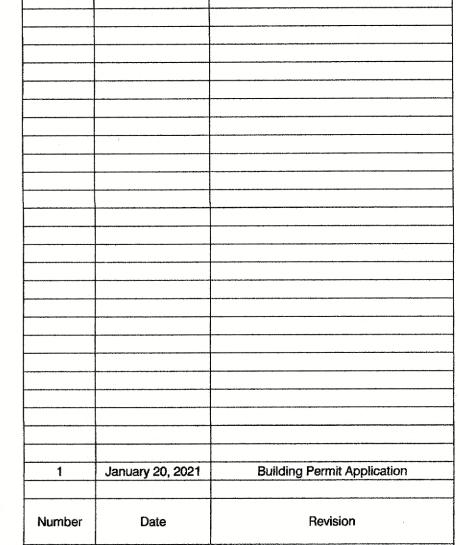

Redner Residence

741 Route 32

Wallkill, New York


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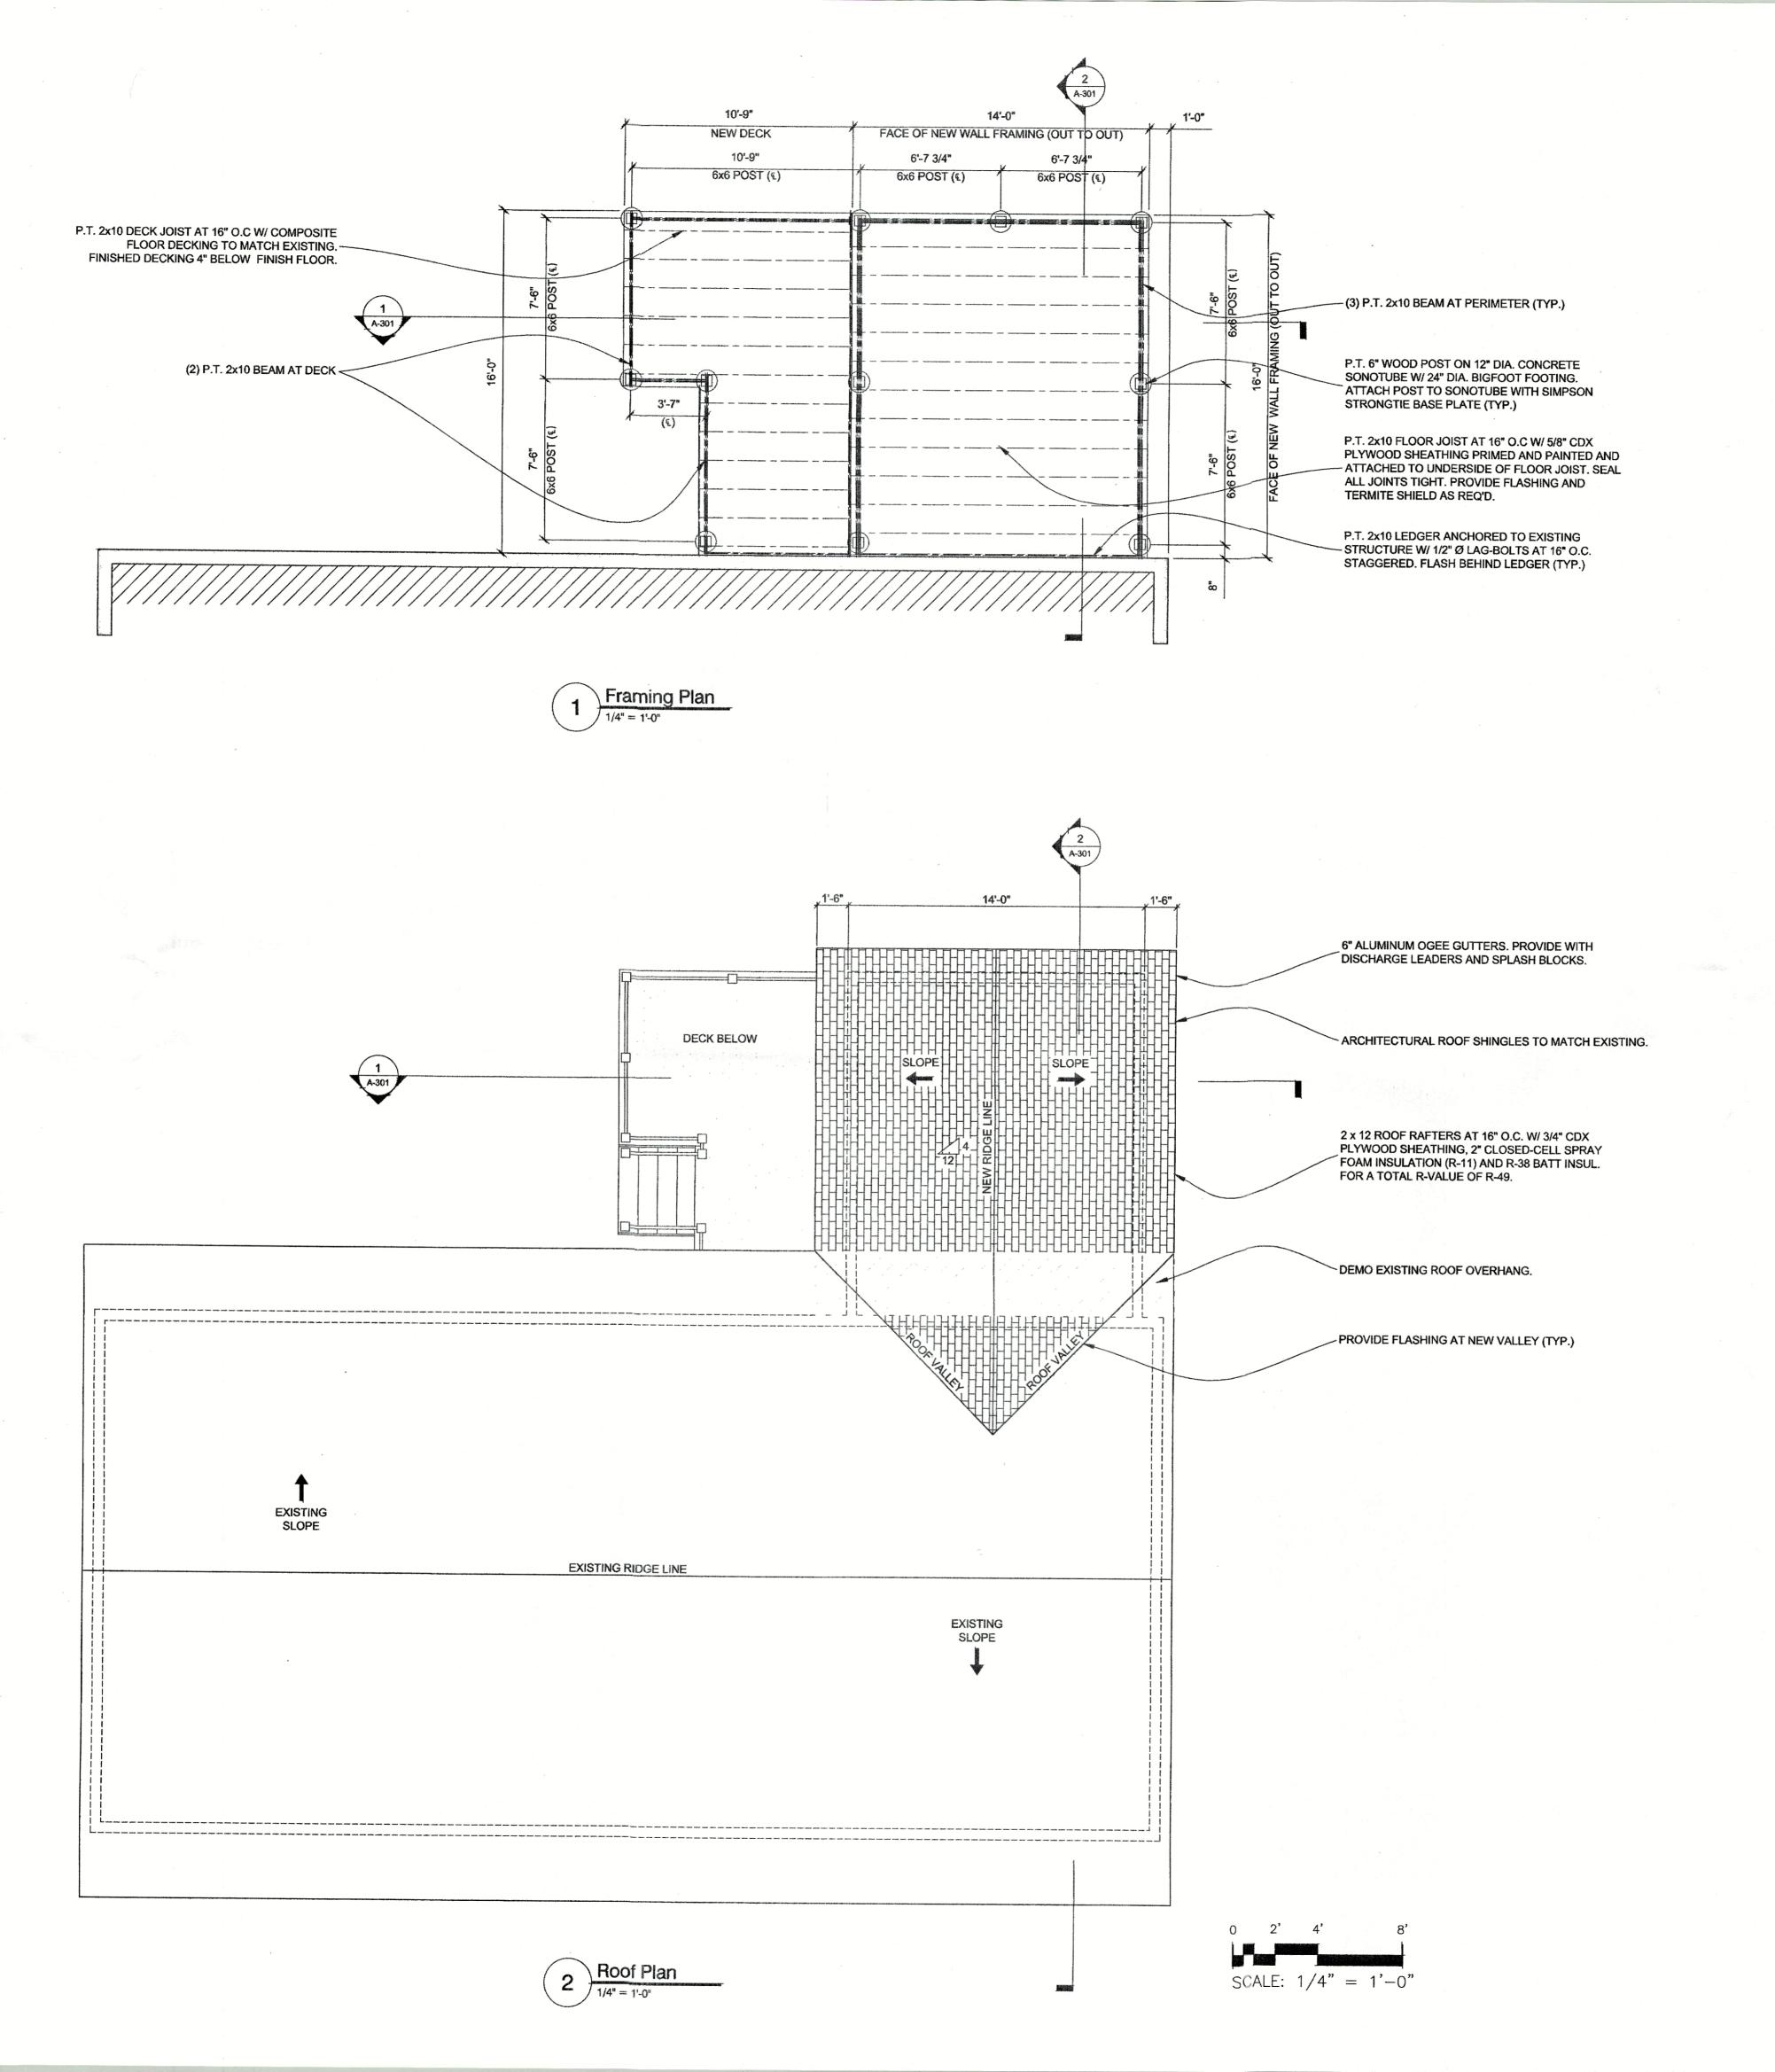
1st Floor Plan Reflected Ceiling Plan

Drawing Number: A-101





SCALE: 1/4" = 1'-0"

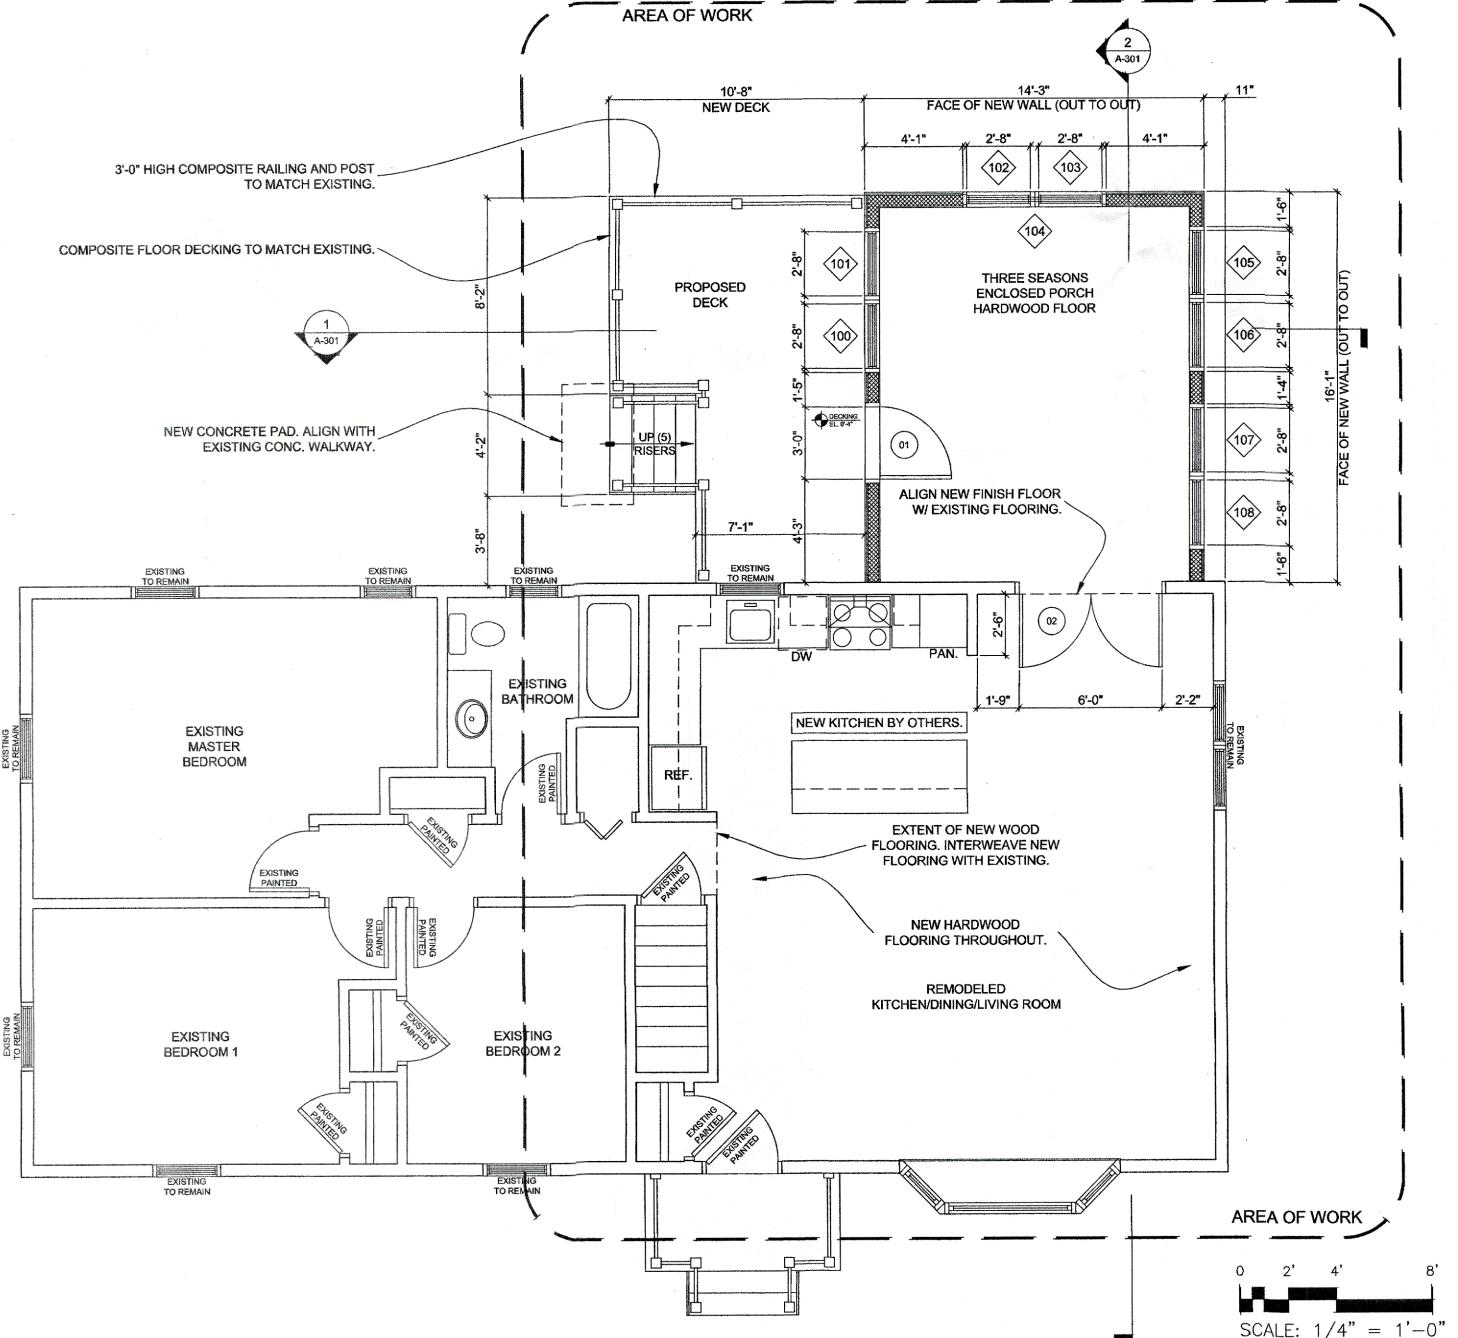

Redner Residence

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Framing Plan Roof Plan


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1 Front Elevation (No Work)

1/4" = 1'-0"



2 Right Side Elevation

Redner Residence
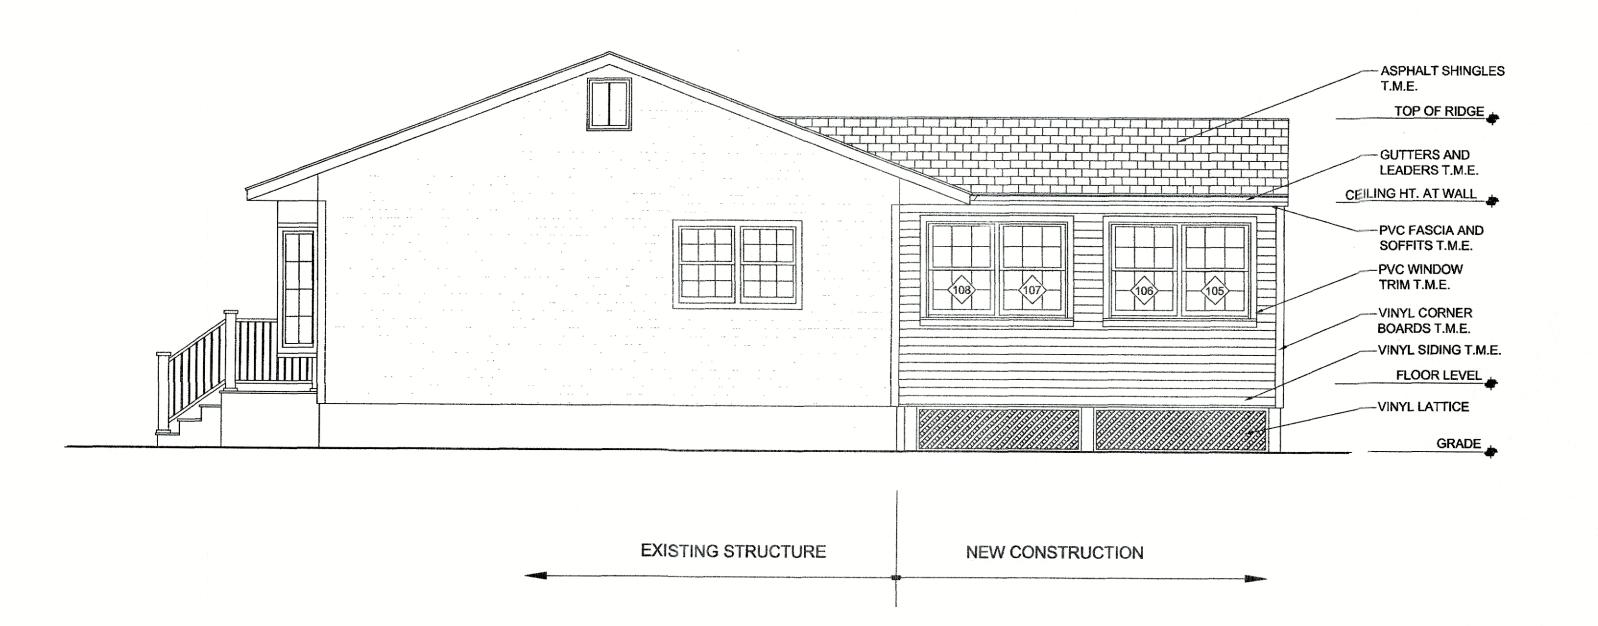
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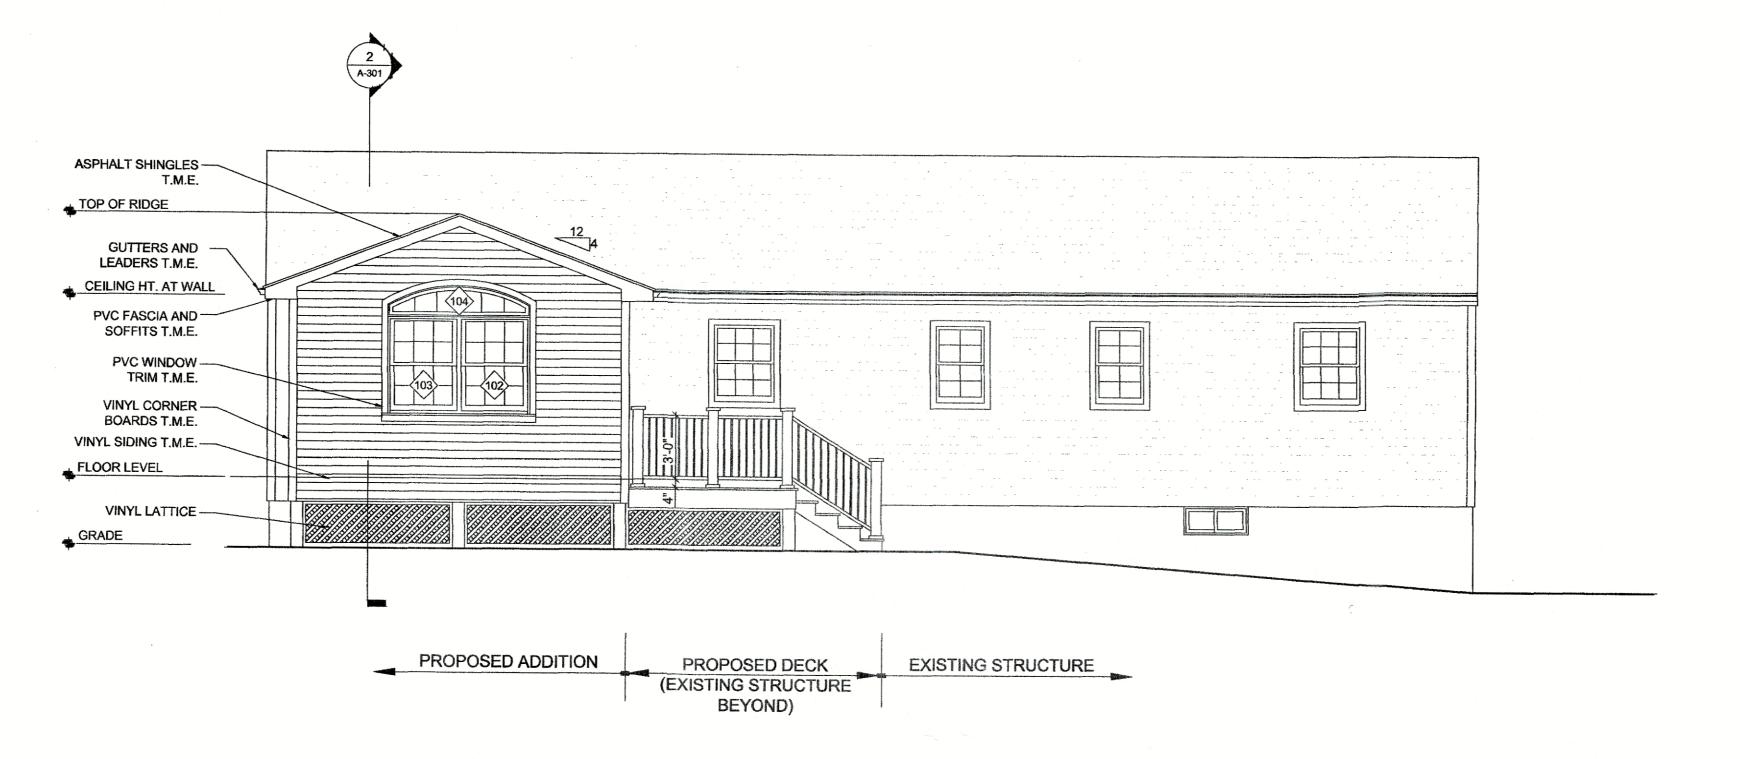
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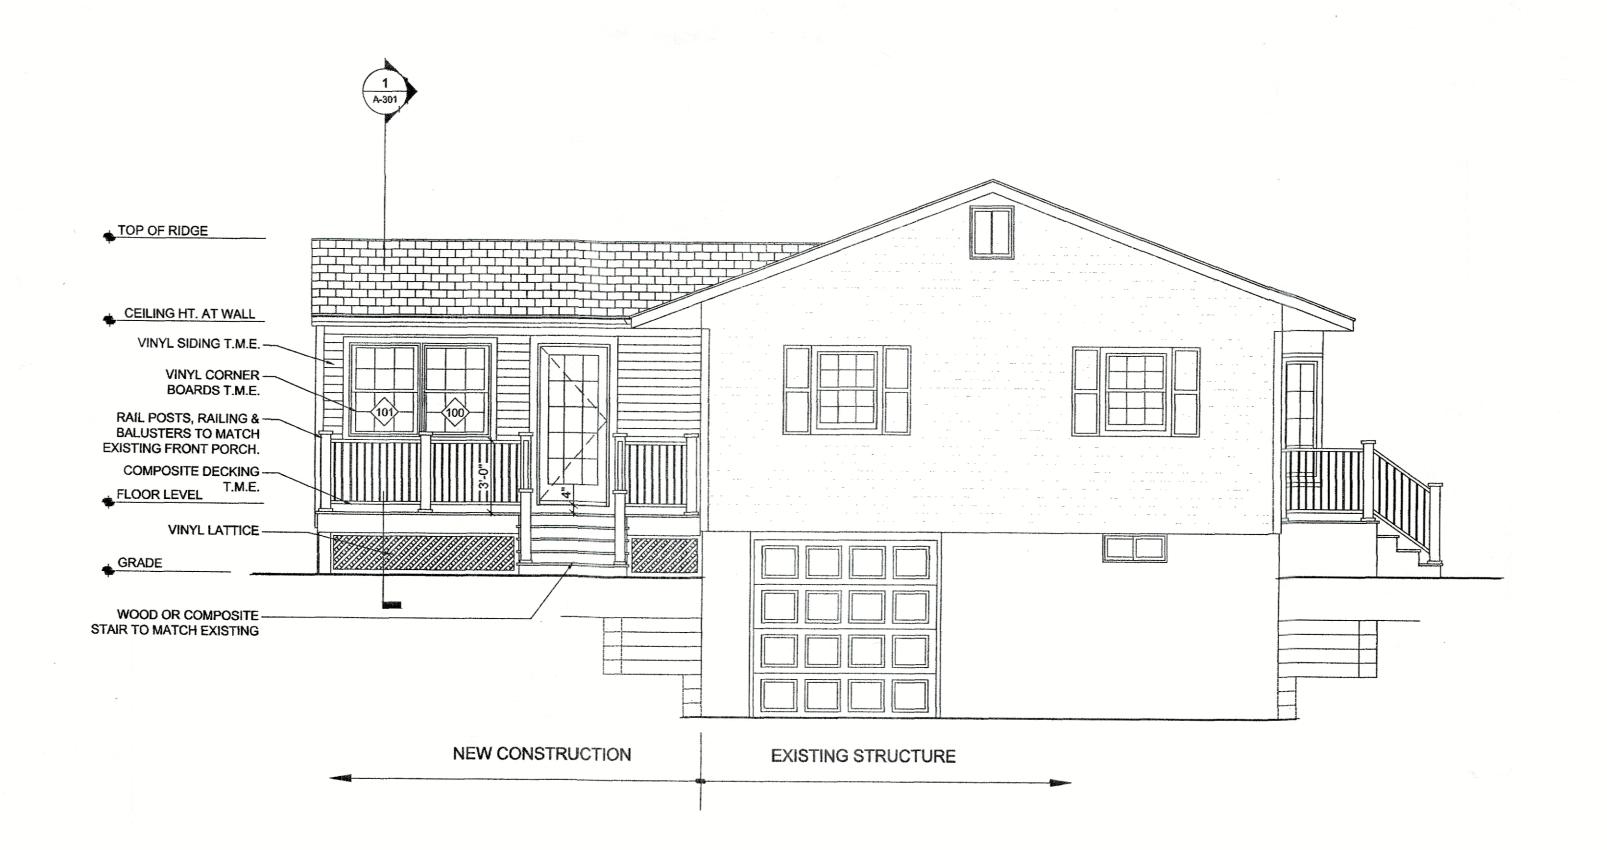
Building Elevations

Date: December 4, 2020

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1 Rear Elevation



2 Left Side Elevation

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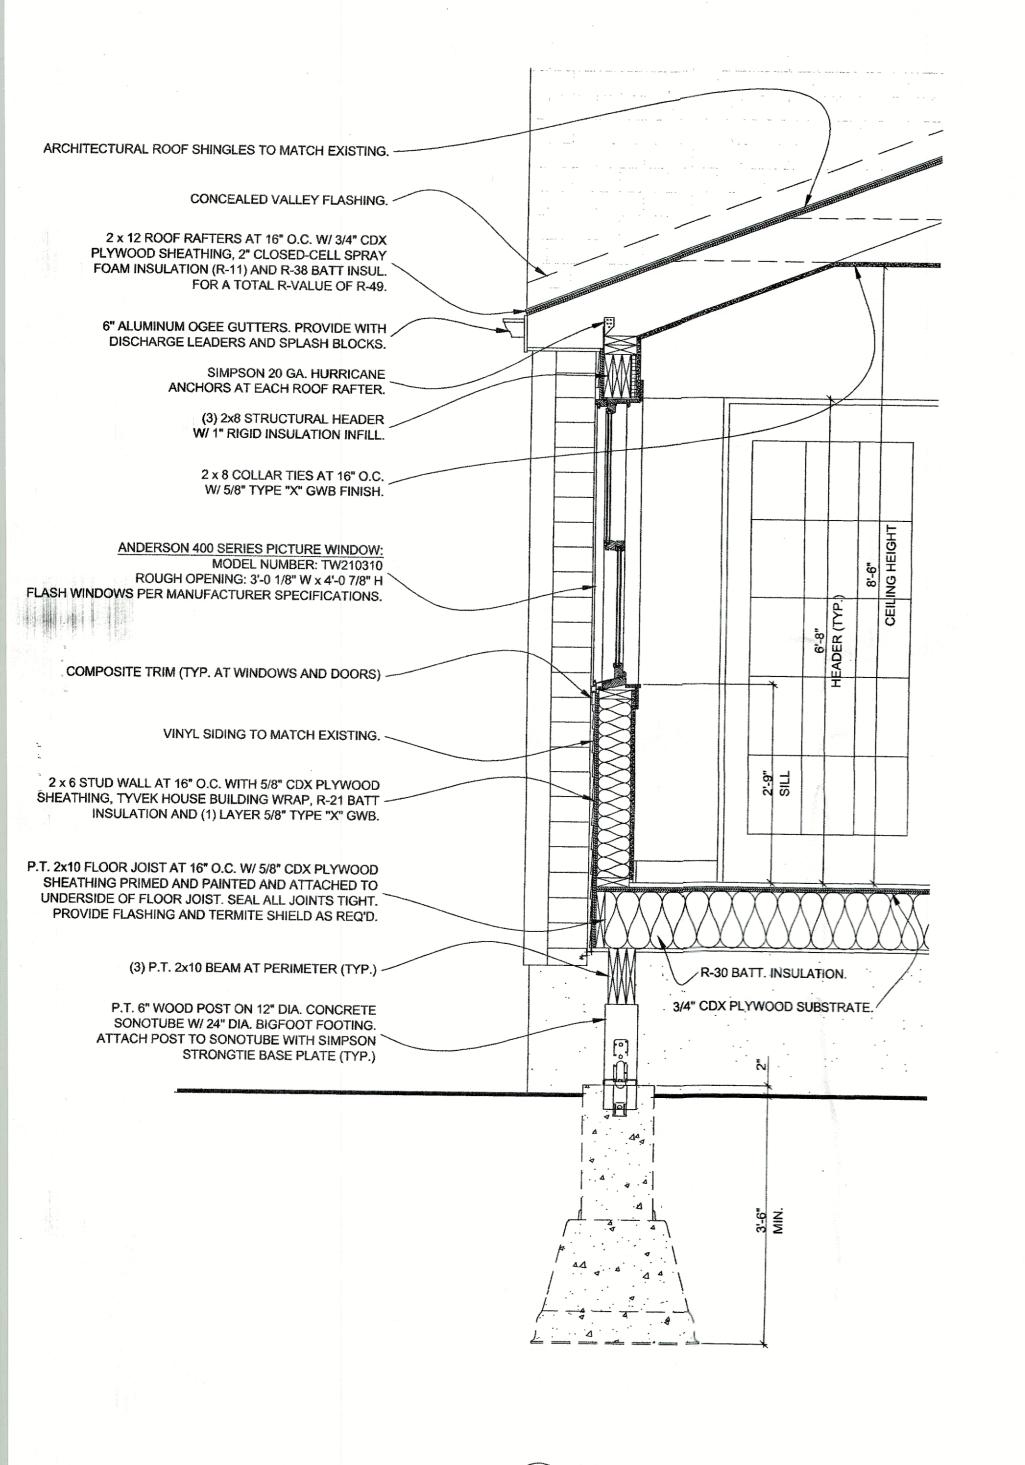
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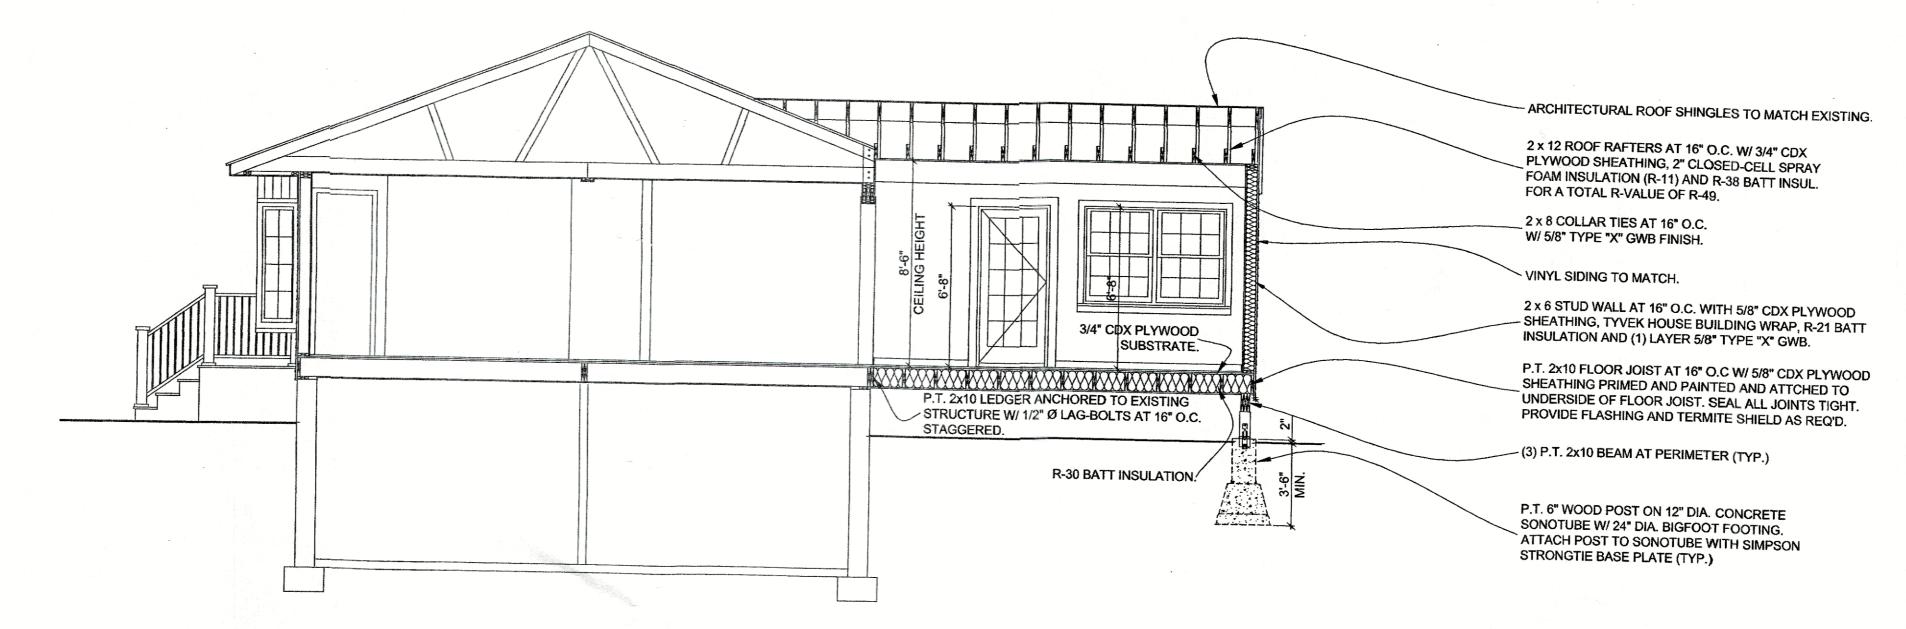
Building Elevations

Date: December 4, 2020




Redner Residence

741 Route 32 Wallkill, New York



2 Building Section

1/4" = 1'-0"

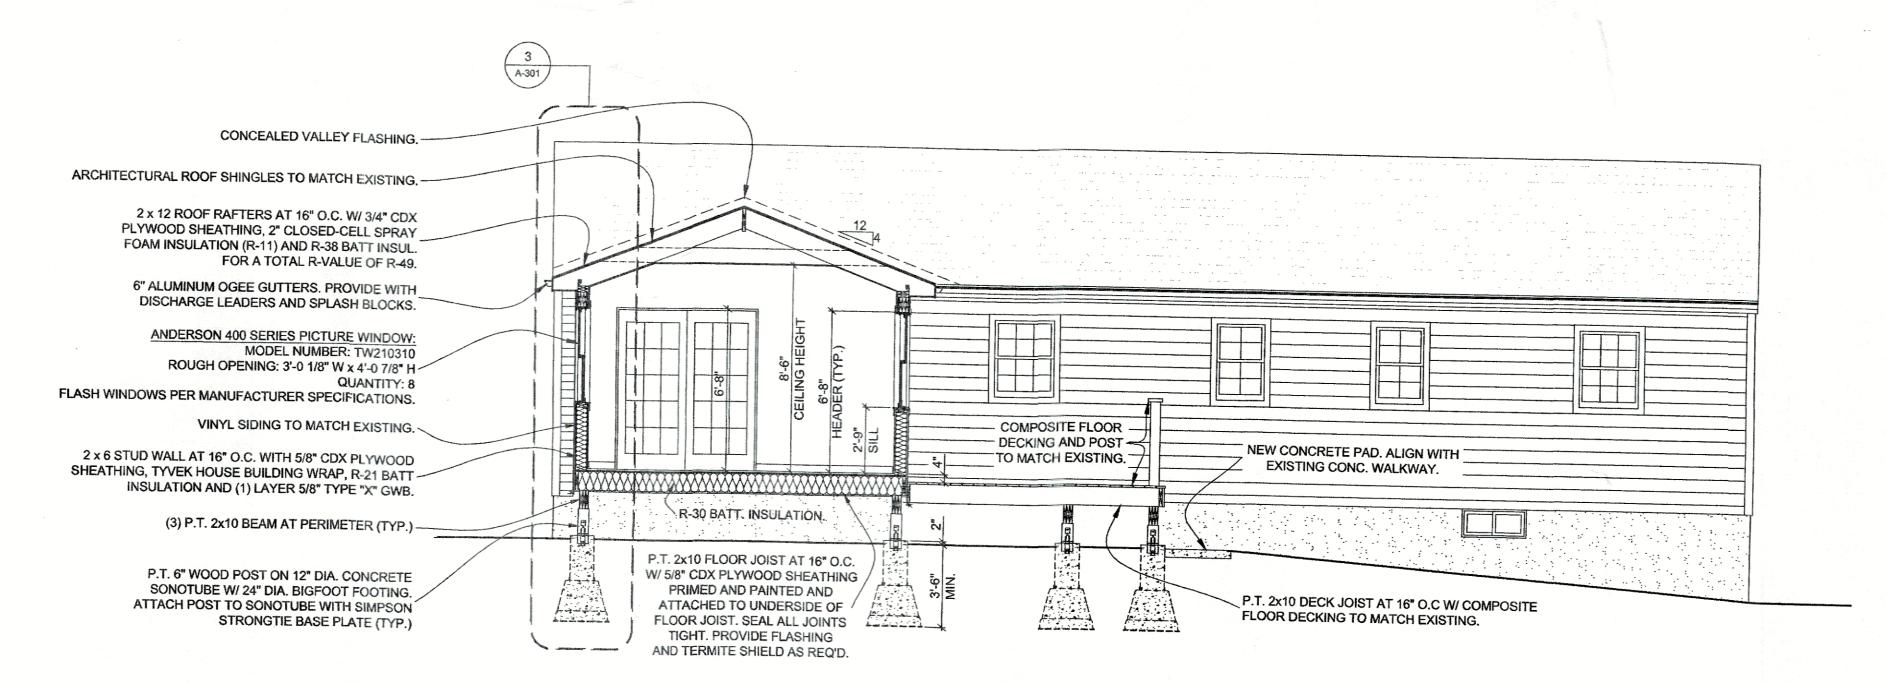

1 Building Section

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Building Permit Application

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Building Sections

Date: December 4, 2020

1/4" = 1'.0" Drawing Number: $\Delta - 30$