

JIFFY LUBE - 154 NEWBURGH MULTICARE SERVICES

1231 STATE ROUTE 300 NEWBURGH, NY 12550 ORANGE COUNTY

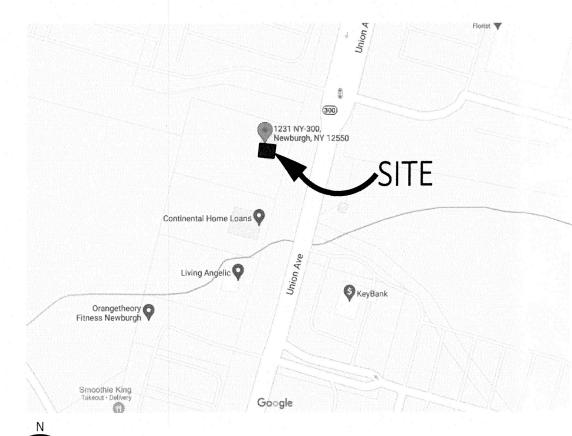

LOCATION MAP

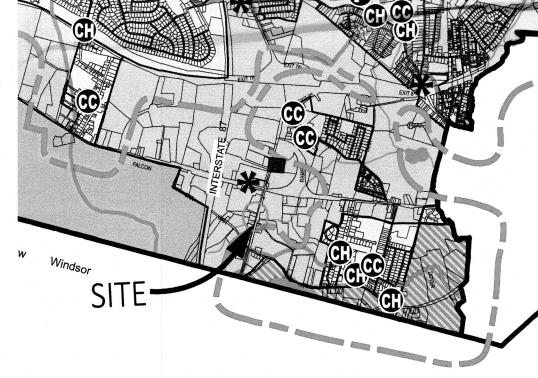



			100				
PROJE	CT DESCRIPTION						
	RUCTION OF A RETAIL AUTOMO	DTIVE OIL CHANGE FACILITY AND ASSOCIATED SI	TE				
SITE N	OTES						
1.	THE BOUNDARY LINES AND TOPOGRAPHY FOR THIS PROJECT ARE BASED ON A FIELD SURVEY COMPLETED BY CONTROL POINT ASSOCIATES INC. PC DATED: 04.15.2021.						
PARCE	L INFORMATION:						
PARCE	L NUMBER:	LOT 3, BLOCK 1					
OWNE	R:	CALALUCA					
ACRES	•	DEVELOPMENT: 0.70 ACRES					

BUILDING CODE REVIEW				
ACCESSIBILITY CODE	2010 ADA STANDARDS ANSI/ICC A117.1 - 2009			
BUILDING CODE	2020 BUILDING CODE OF NEW YORK STATE (IBC 2018 WITH AMENDMENTS BUILDING CODE			
ELECTRICAL CODE	DE 2017 NATIONAL ELECTRICAL CODE OF NEW YORK STATE (ADOPTS NFPA 70 WITHOUT AMENDMENTS) ELECTRICAL CODE			
ENERGY CODE	2020 ENERGY CODE OF NEW YORK STATE (IECC 2018 WITH AMENDMENTS) ENERGY CONSERVATION			
MECHANICAL CODE 2020 MECHANICAL CODE OF NEW YORK STATE (IBC 2018 WITH AMENDMENTS) MECHANICAL CODE				
PLUMBING CODE	2020 PLUMBING CODE OF NEW YORK STATE (IBC 2018 WITH AMENDMENT PLUMBING CODE			
FIRE CODE	2020 FIRE CODE OF NEW YORK STATE FIRE CODE			
ZONING ORDINANCE REV	/IEW			
ZONING ORDINANCE	ZONING ORDINANCE OF TOWN OF NEWBURGH			
ZONING MAP	ZONING MAP OF 2001			
SITE ZONING	IB INTERCHANGE BUSINESS			
PERMITTED USE	YES			

BULK REGULATIONS ITEM		REQUIRED		PROPOSED		TOWN CODE	
LOT REQUIREMENTS:		REQUIRES			0010	, , , , , , , , , , , , , , , , , , , ,	
MIN. LOT AREA		40	,000 SF	30,502 SF	(0.70 AC)		
MIN. LOT DEPTH			150'		98'		
MIN. LOT WIDTH			150'	15	1.6'		
MAX. LOT COVERAGE			85%	59	9%		
BUILDING REQUIREMEN	NTS:						
MAX. BUILDING HEIGI	HT "		35'	21'			
SETBACK REQUIREMEN	TS:			······································		7 2 2 2 2	
FRONT BUILDING SET	BACK		60'	50.3'			
SIDE BUILDING SETBA	CK (N)		50'	10).3'		
SIDE BUILDING SETBA	CK (S)		50'	49	9.0'		
REAR BUILDING SETBA	ACK		60'	10	4.5'		
PARKING SETBACK			20'	2	0'		
PARKING REQUIREMEN	TS:						
MIN. STANDARD SPAC	CE SIZE	9'	' X 18'	9' X 18'			
PARKING CALCULATION	N:						
TOTAL SPACES		10		13			
ADA SPACES	PACES 1 1		ANSI/ICC A117.2				
MIN. LOADING ZONE SIZE			N/A		/A		
SIGNS: ZONING IB - IN	NTERCHAN	GE BUSINE	SS				
PYLON SIGN: ALLOW	D; YES						
	MAXIMUI	M:	PROVIDED:		CODE:	VARIANCE	
AREA:	60 S.F.		37 S.F.				
HEIGHT:	35.0'		25.0'		185 14 N 2	NO	
SETBACK:	FRONT: W 15.0' OF F PROPERT	RONT	15.0'	185.14.N.2			
NUMBER OF SIGNS	1		1			NO	
ELECTRONIC MESSAG	E DISPLAY:	ALLOWED	WITH SPECIAL	USE APP	ROVAL		
AREA:	LESS THA	N ⅓ AREA = 11 S.F.	9 S.F.	.F. 1		NO	
BUILDING SIGNS: ALL	OWED: YES	- SECTION	I 185.14.N	-			
ELEVATION	SIGN		ALLOWED:		PROVIDED:	VARIANCE	
FRONT ELEVATION	SIGN - A		PER TOTAL		28 S.F. 7 S.F.	NO	
SIDE ELEVATION	SIGN - B	· · · · · · · · · · · · · · · · · · ·	PER TOTAL		38.0'	NO	
SIDE ELEVATION (NORTH)	SIGN - C	-	PER TOTAL		30 S.F.	NO	
SIDE ELEVATION (SOUTH)	SIGN - F	ne en e	PER TOTAL	9 S.F.		NO	
REAR ELEVATION	SIGN - B		PER TOTAL		38 S.F.	NO	
TOTAL ALLOWED			1	: I		8.	
TOTAL ALLOWED ON BUILDING:		· · · · · · · · · · · · · · · · · · ·	92 S.F.	ONAL	150 S.F.	YES	
	SIGN - H		92 S.F. 4 S.F. DIRECTION SIGN AREA	ONAL	150 S.F. 5.32 S.F.	YES	

1.	LOT AREA VARIANCE - THE EXISTING SITE IS 30,502 SQUARE FEET AND THE MINIMUM ALLOWABLE LOT SIZE IS 40,000 SQUARE FEET (S.F.).
2.	FRONT YARD VARIANCE - THE PROPOSED STRUCTURE IS 50.3 FEET FROM THE NYS-300 RIGHT OF WAY AND THE MINIMUM FRONT SETBACK FROM NYS-300 IS 60 FEET.
3.	SIDE YARD VARIANCE - THE MINIMUM SIDE YARD SETBACK IS 50 FEET. THE PROPOSED STRUCTURE IS 10.3 FEET FROM THE NORTH PROPERTY LINE.
4.	SIDE YARD VARIANCE- THE MINIMUM SIDE YARD SETBACK IS 50 FEET. THE PROPOSED STRUCTURE IS 49.0 FEET FROM THE SOUTH PROPERTY LINE.
5.	SIGNAGE VARIANCE: 4 S.F. IS THE MAXIMUM ALLOWABLE SIGN SIZE FOR DIRECTIONAL SIGNS IN THE IB ZONE. SIX OF THE DIRECTIONAL SIGNS ARE 5.32 S.F.
6.	SIGNAGE VARIANCE: THE TOTAL SIGNAGE AREA OF ALL BUILDING SIGNAGE IS 150 S.F. THE CODE ALLOWS 92 S.F. BASED ON THE FRONT WALL BUILDING LENGTH.

	DESCRIPTION	ADDRESS	CONTACT
	DEVELOPER	JIFFY LUBE INTERNATIONAL - SHELL LUBRICANTS BUILDING F, RM F 376 D 150 N. DAIRY ASHFORD RD HOUSTON, TX 77079	CLAIRE GILROY 832.337.9809
SITE	PROJECT MANAGER	SEVAN MULTI-SITE SOLUTIONS 3025 HIGHLAND PARKWAY DOWNERS GROVE, IL 60048	FRANK MALAWSKI 773.370.9239
	SURVEYOR	CONTROL POINT ASSOCIATES INC. PC 26 AVIATION ROAD ALBANY, NY 12205	JODY LOUNSBURY PLS 518.217.5010
IGN PACT	CIVIL ENGINEER	SEVAN ENGINEERING, PC 37704 HILLS TECH DRIVE FARMINGTON HILLS, MI 48331	TIMOTHY KRATZ, PE 219.841.6535
DESIGN	ARCHITECT	CASCO + R5 12 SUNNEN DRIVE, SUITE 100 ST. LOUIS, MO 63143	JIM SCHMITT 314.821.1100x252
2 1	TELEPHONE	NAME ADDRESS ADDRESS	CONTACT XXX.XXX.XXXX
	CABLE	NAME ADDRESS ADDRESS	CONTACT XXX.XXX.XXXX
UTILITY	ELECTRIC	ANGELA 284 SOUTH AVE. POUGHKEEPSIE, NY 12601	CONTACT 845.452.2700
	GAS	ANGELA 284 SOUTH AVE. POUGHKEEPSIE, NY 12601	CONTACT 845.452.2700
	WATER	MARY BUTLER 311 ROUTE 32 NEWBURGH, NY 12550	CONTACT 845.564.7813
	SANITARY SEWER	MARY BUTLER 311 ROUTE 32 NEWBURGH, NY 12550	CONTACT 845.564.7813
	STORM SEWER	TOWN OF NEWBURGH, NY 21 HUDSON VALLEY PROFESSIONAL PLAZA, NEWBURGH, NY 12550	CONTACT 845.564.7801
K	PLANNING DEPARTMENT (TOWNSHIP)	JOHN EWASUTYN 21 HUDSON VALLEY PROFESSIONAL PLAZA NEWBURGH, NY 12550	CONTACT 845.564.7804
GOVERNMENT	ENGINEER	JAMES W OSBORNE, P.E. 308 GARDNERTOWN ROAD NEWBURGH, NY 12550	CONTACT 845. 564.7814
	BUILDING DEPARTMENT	GERALD CANFIELD 21 HUDSON VALLEY PROFESSIONAL PLAZA NEWBURGH, NY 12550	CONTACT 845.564.7801

SHEET INDE	X			4					36	
		SITE PLAN REVIEW 06.21.2021	ZONING BOARD OF APPEALS 09.07.2021							
GENERAL		0	1	2	3	4	5	6	7	
G0.01	COVER SHEET	•						vi y		
G0.02	GENERAL NOTES									I
SURVEY										
1 OF 1	ALTA/NSPS LAND TITLE SURVEY	•	•							
CIVIL										
C1.02	COMPOSITE SITE PLAN									
C1.10	DEMOLITION SITE PLAN									
C1.11	SOIL EROSION AND SEDIMENTATION CONTROL PLAN									
C1.20	DIMENSION CONTROL SITE PLAN	•	•							
C1.30	GRADING PLAN	•	•		2				â	
C1.31	STORM WATER MANAGEMENT PLAN									
C1.32	STORM WATER PROFILES & DETAILS									
C1.40	UTILITY PLAN	•	•		4 2		10 M			
C5.00	EROSION CONTROL DETAILS									
C5.01	SITE DETAILS					1				
C5.02	UTILITY DETAILS									
C5.03	ADDITIONAL DETAILS AS NEED FOR SITE SPECIFIC ELEMENTS									
L1.20	LANDSCAPE PLAN, NOTES AND SCHEDULE		• ,		4		8 N 4	7 × 10		
SITE LIGHTIN										
PM-1	SITE PHOTOMETRICS								4	
SIGNAGE							2			
AG1.01	SITE PLAN SIGNS	•	•							
AG2.01	SIGN ELEVATIONS	•	•							
AG5.01	SIGN DETAILS		•							T

SEVAN

Regional Office:
37704 Hills Tech Drive Farmington Hills, MI 48331

Corporate Office: 3025 Highland Parkway, Suite 850 Downers Grove, IL 60515

REVISIONS NO. DATE DESCRIPTION 0 06.21.2021 SITE PLAN REVIEW 1 09.07.2021 ZONING BOARD OF APPEALS

CONSULTANT

09/08/2024

CUSTOMER

JIFFY LUBE **MULTI-CARE SERVICES**

PROJECT LOCATION

1231 STATE ROUTE 300 NEWBURGH, NY 12550


(ORANGE COUNTY)

SHEET TITLE


COVER SHEET


SHEET NUMBER

G0.01

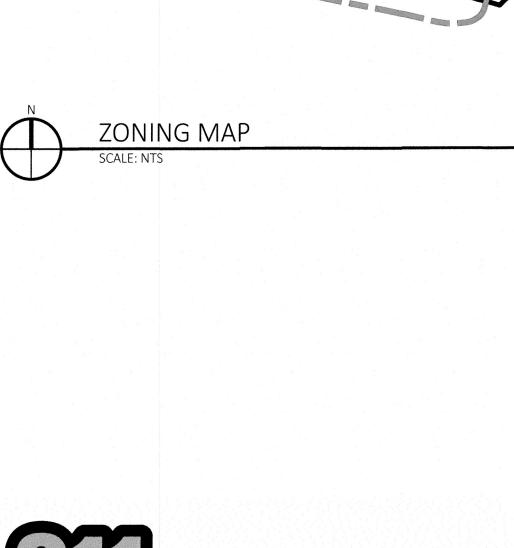

Know what's **below. 811** before you dig.

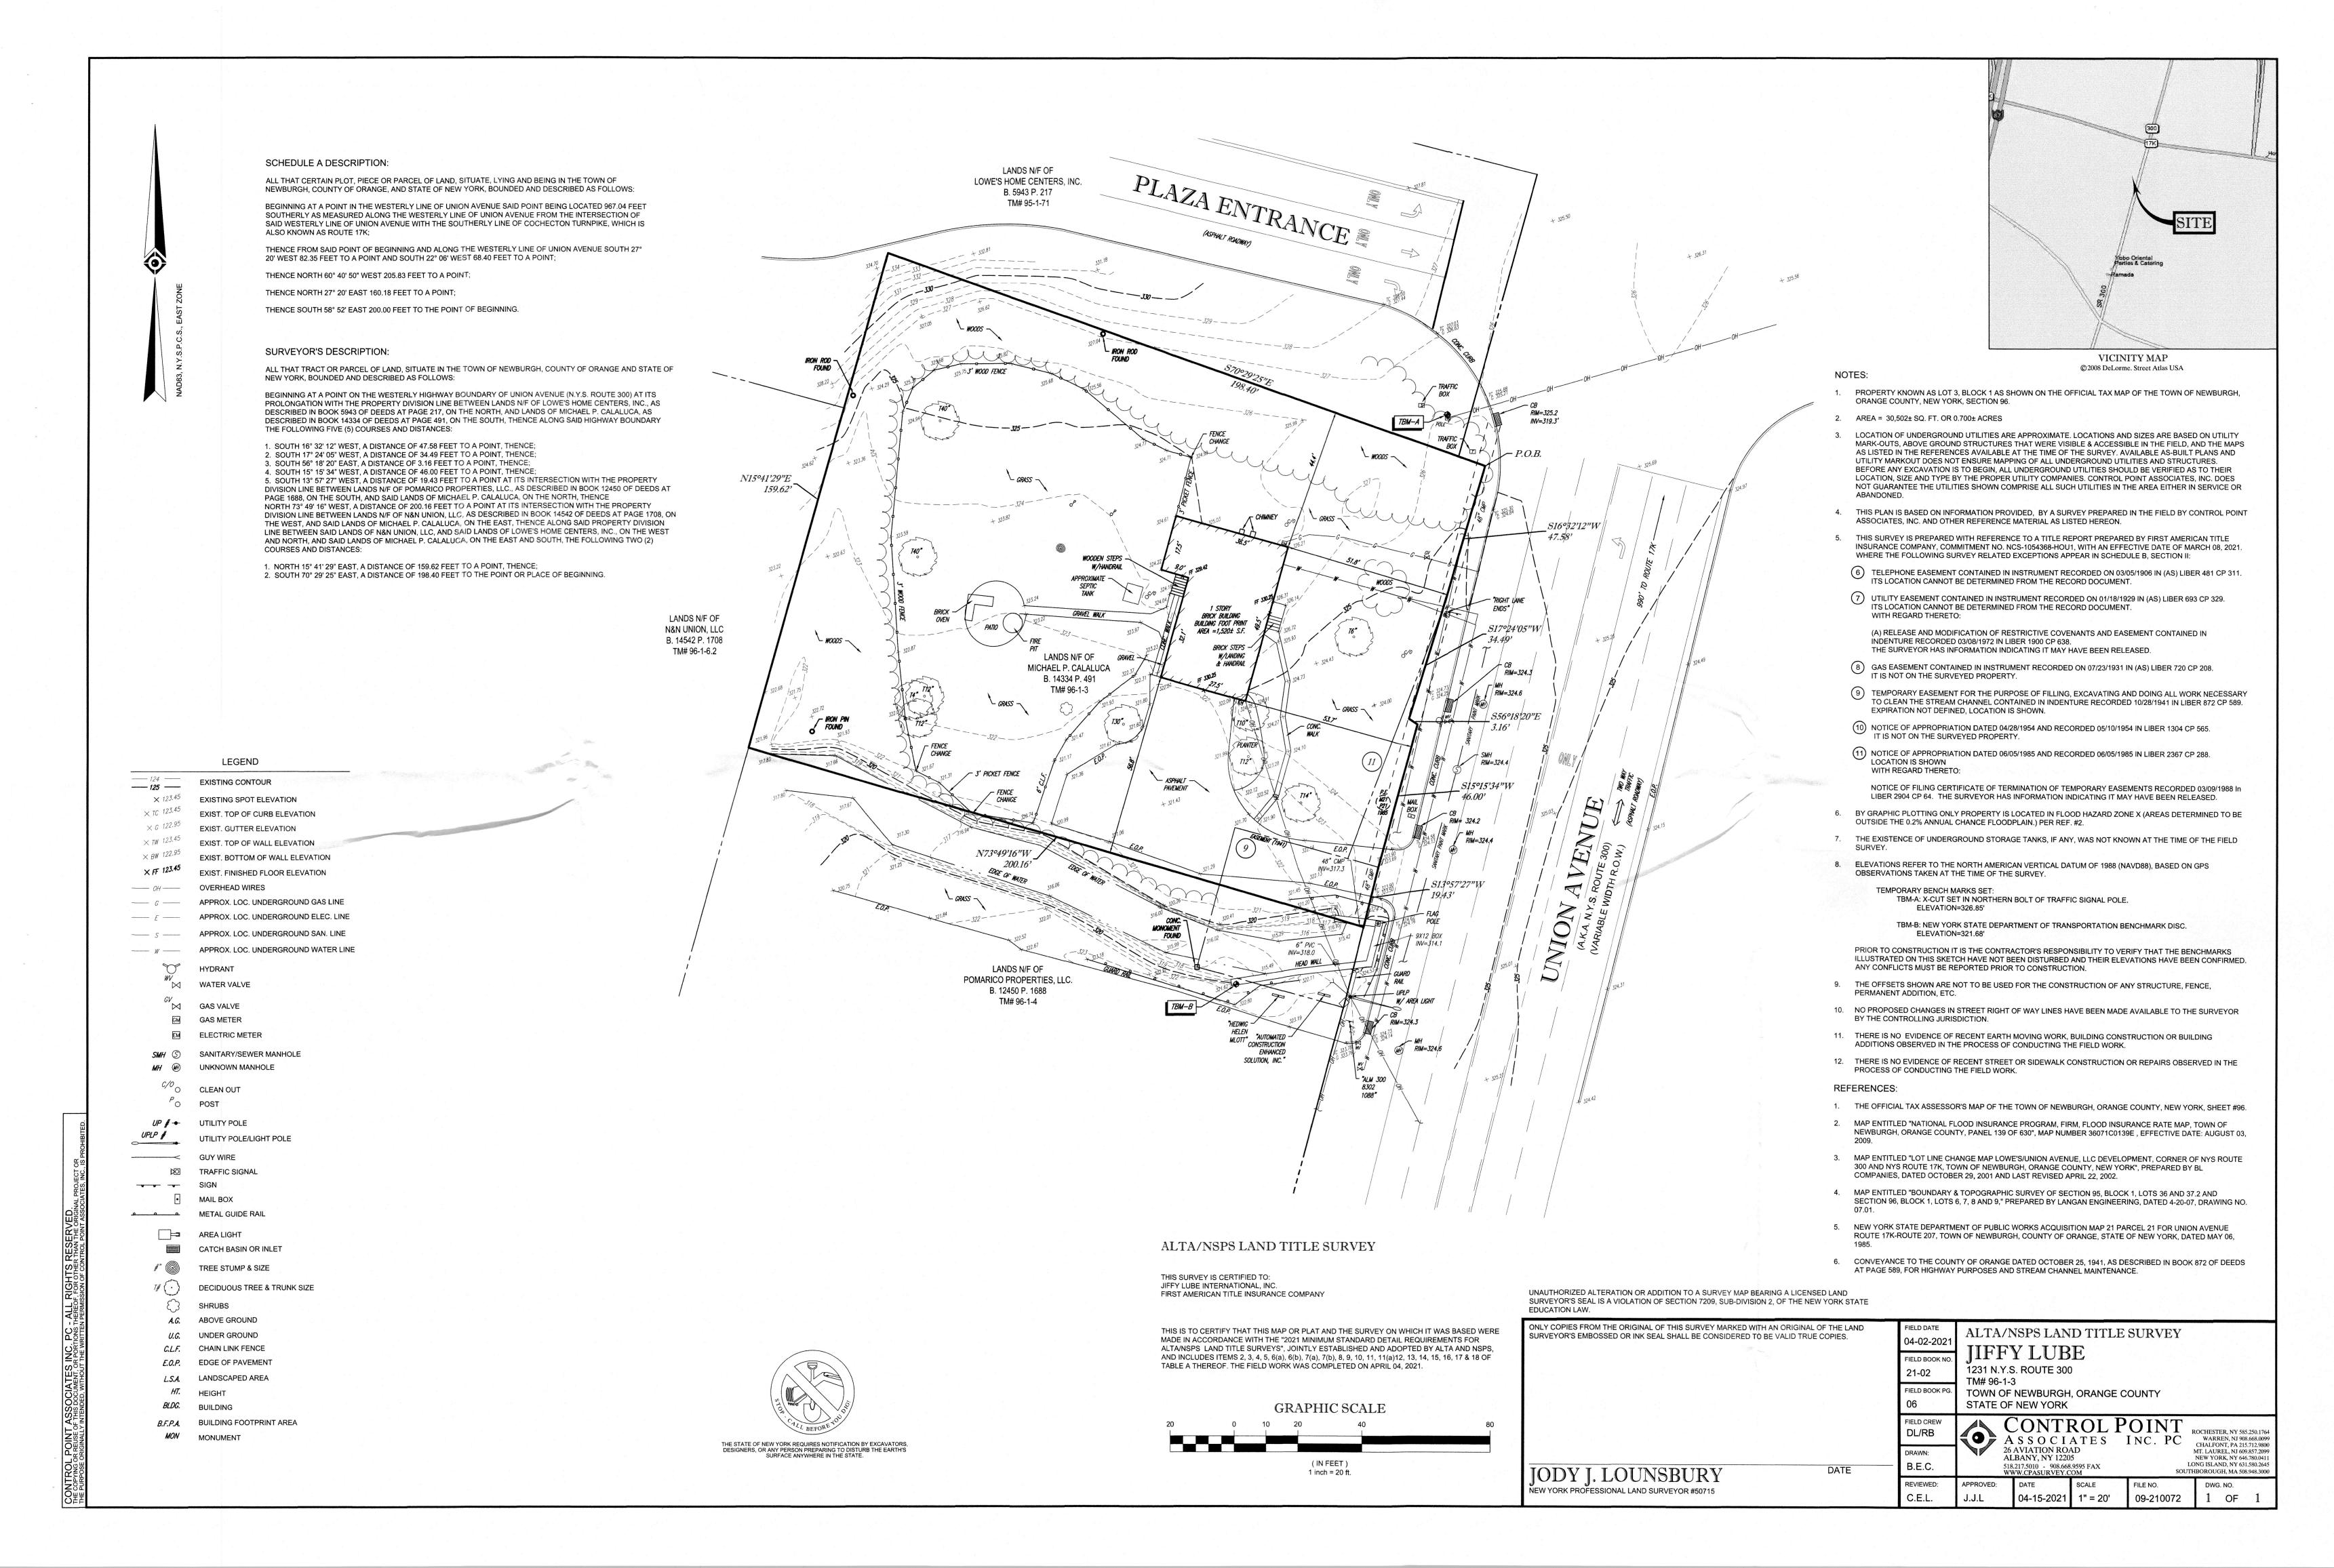

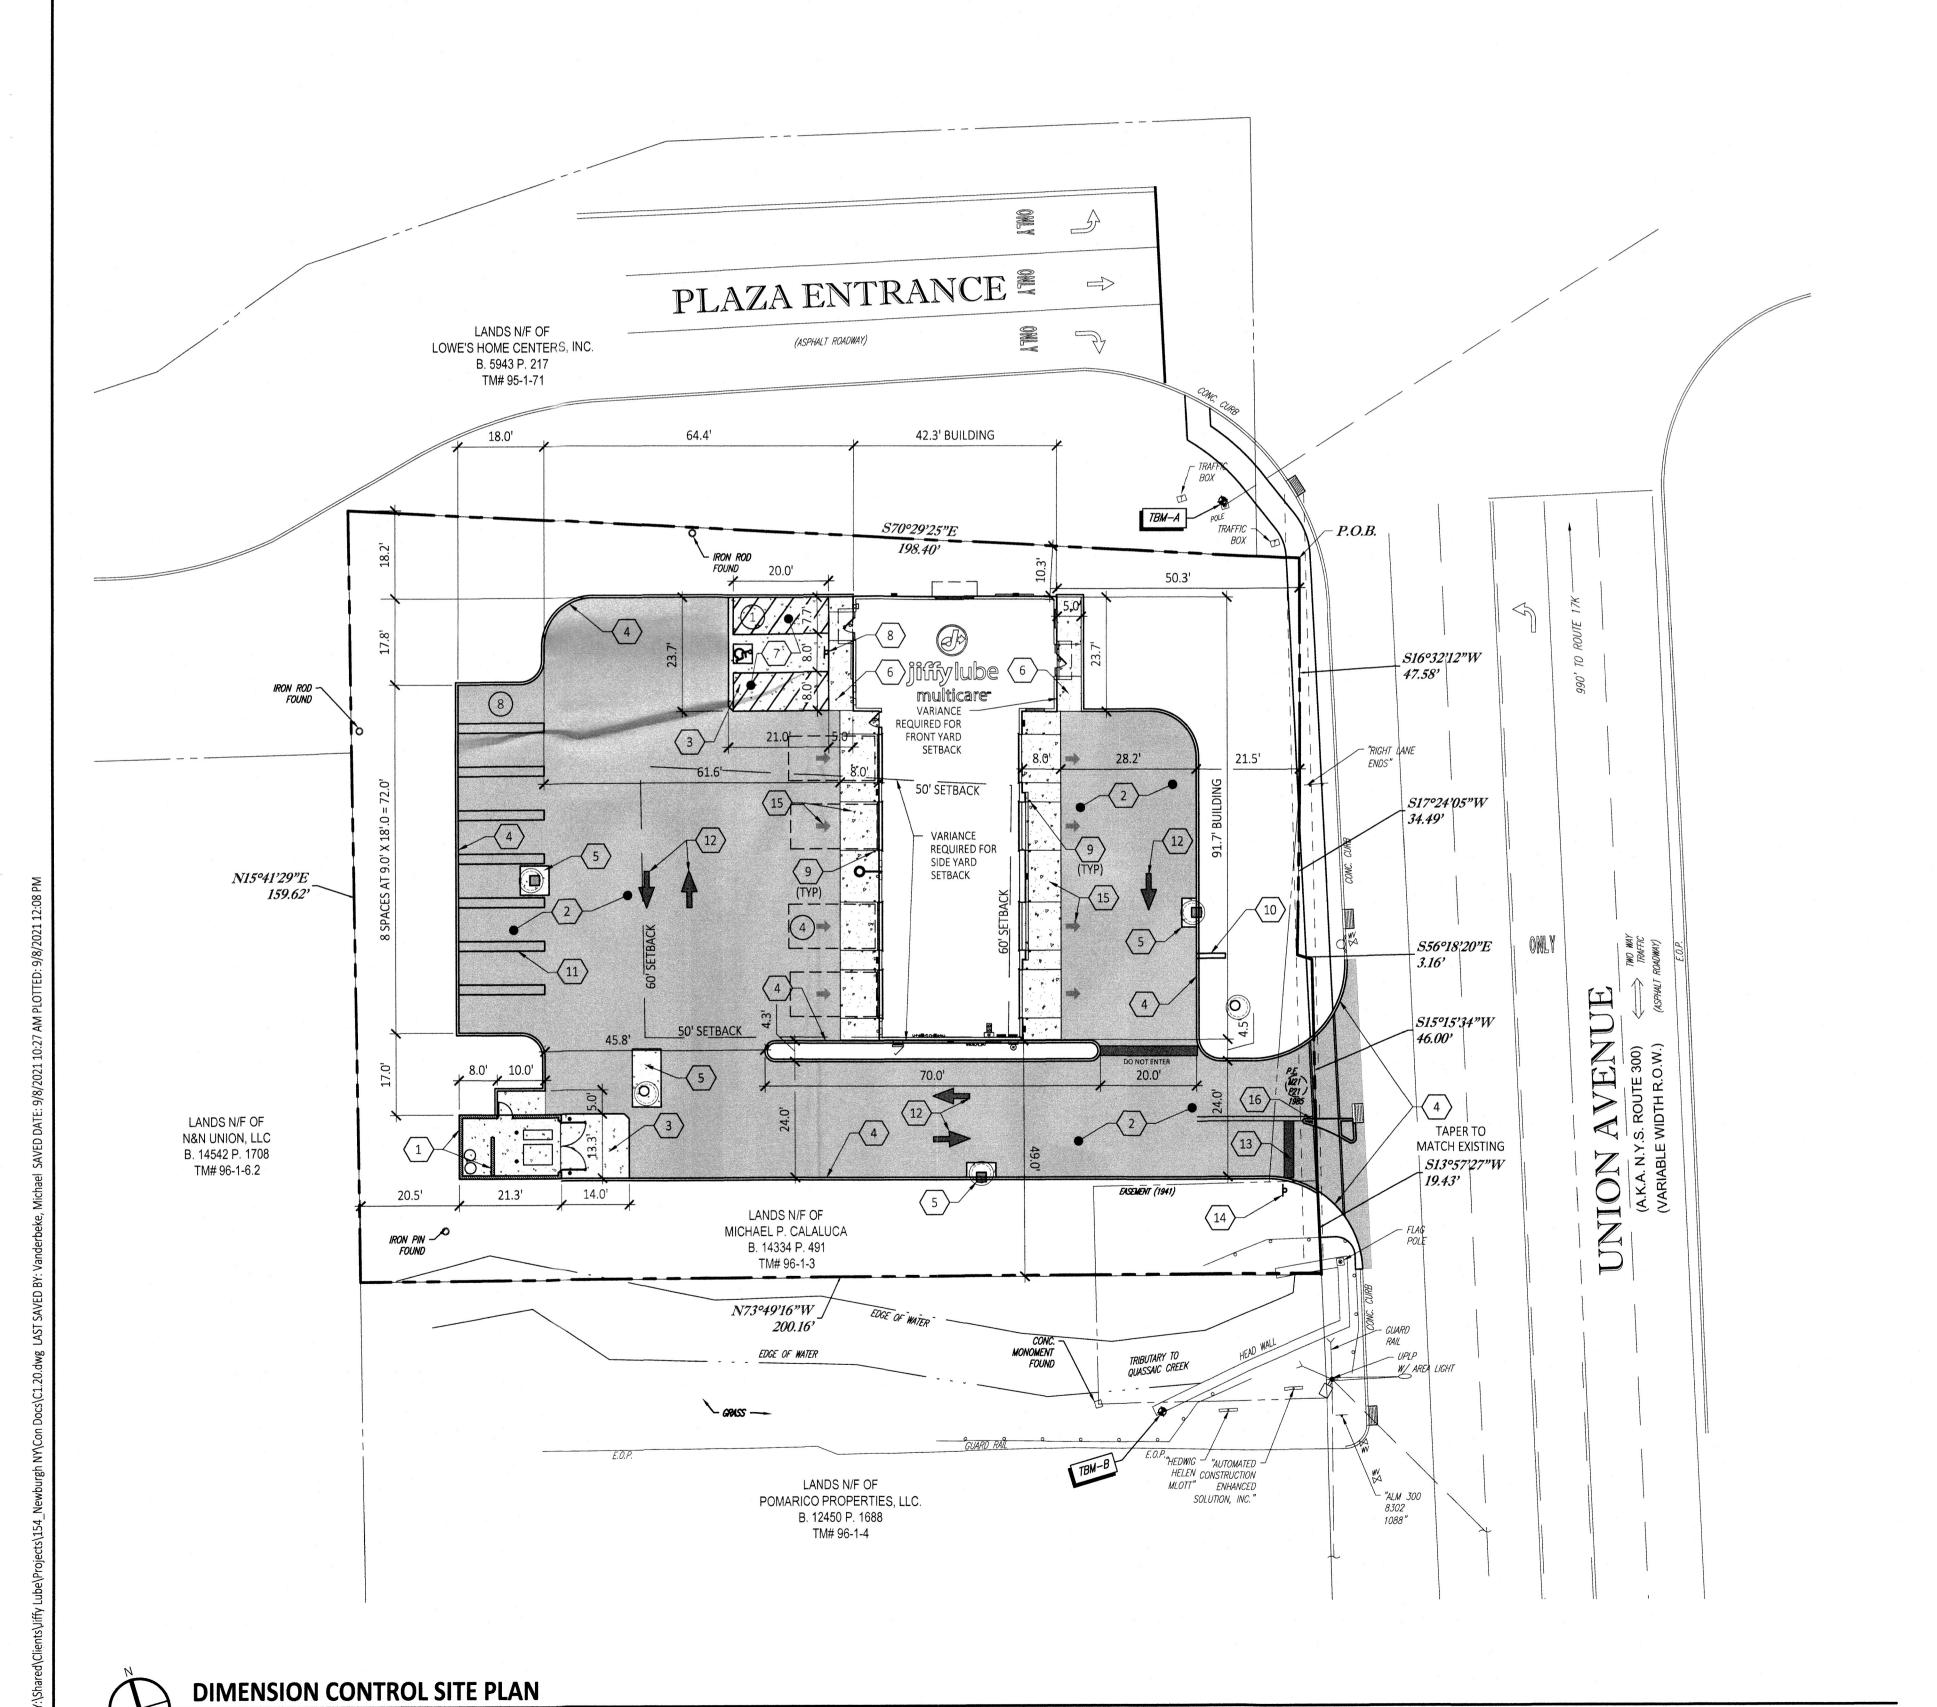

X PROPOSED SITE IMPROVEMENTS

- 1 TRASH ENCLOSURE, CONCRETE PAD AND PROTECTIVE BOLLARDS.
- 2 BITUMINOUS ASPHALT PAVEMENT.
- 3 CONCRETE PAVEMENT. 4 CONCRETE CURB
- 5 POURED CONCRETE STRUCTURE COLLAR. COORDINATE ELEVATION WITH TOP OF STRUCTURE.
- 6 CONCRETE SIDEWALK (WIDTH VARIES SEE PLAN). 7 VAN ACCESSIBLE PARKING SPACE WITH PAINTED ACCESSIBILITY SPACE SYMBOL AS REQUIRED
- BY FEDERAL, STATE OR LOCAL CODE. 8 ACCESSIBLE RESERVED PARKING SIGN AS REQUIRED BY FEDERAL, STATE OR LOCAL CODE.
- 9 PROTECTIVE BOLLARD.
- 10 PYLON SIGN.
- 4" PAINTED PARKING STRIPE. WHITE
- 12 PAINTED DIRECTIONAL DRIVE ARROWS. COLOR TO MATCH PARKING STRIPING.
- 13 PAINTED STOP BAR. COLOR TO MATCH PARKING STRIPE.
- 14 STOP SIGN.
- 16 RIGHT TURN ONLY ON EXIT SIDE OF DRIVE AISLE PER DOT STANDARDS

15 INTEGRAL COLOR CONCRETE APRON AND PAINTED BAY ARROWS.

GENERAL SITE NOTES

- A. ALL DIMENSIONS ARE TO FACE OF CURB UNLESS NOTED OTHERWISE.
- B. NOTIFY OWNER OF ANY DISCREPANCIES.
- SEE SURVEY FOR EXISTING CONDITIONS.
- D. ALL WORK IN PUBLIC RIGHT-OF-WAYS SHALL BE IN ACCORDANCE WITH ALL STATE AND LOCAL REQUIREMENTS AND STANDARDS.
- E. PARKING SPACES AND BUILDING ARE PARALLEL AND PERPENDICULAR TO PROPERTY LINE S16°32'18"W

SEVAL

37704 Hills Tech Drive Farmington Hills, MI 4833

3025 Highland Parkway, Suite Downers Grove, IL 60515

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PROJECT DESCRIPTION

JIFFY LUBE MULTI-CARE SERVI

PROJECT LOCATION

1231 STATE ROUTE NEWBURGH, NY 12!


(ORANGE COUNTY)

SHEET TITLE

DIMENSION CONTI SITE PLAN

SHEET MANAGEMENT PROJECT MANAGER:

C1.20

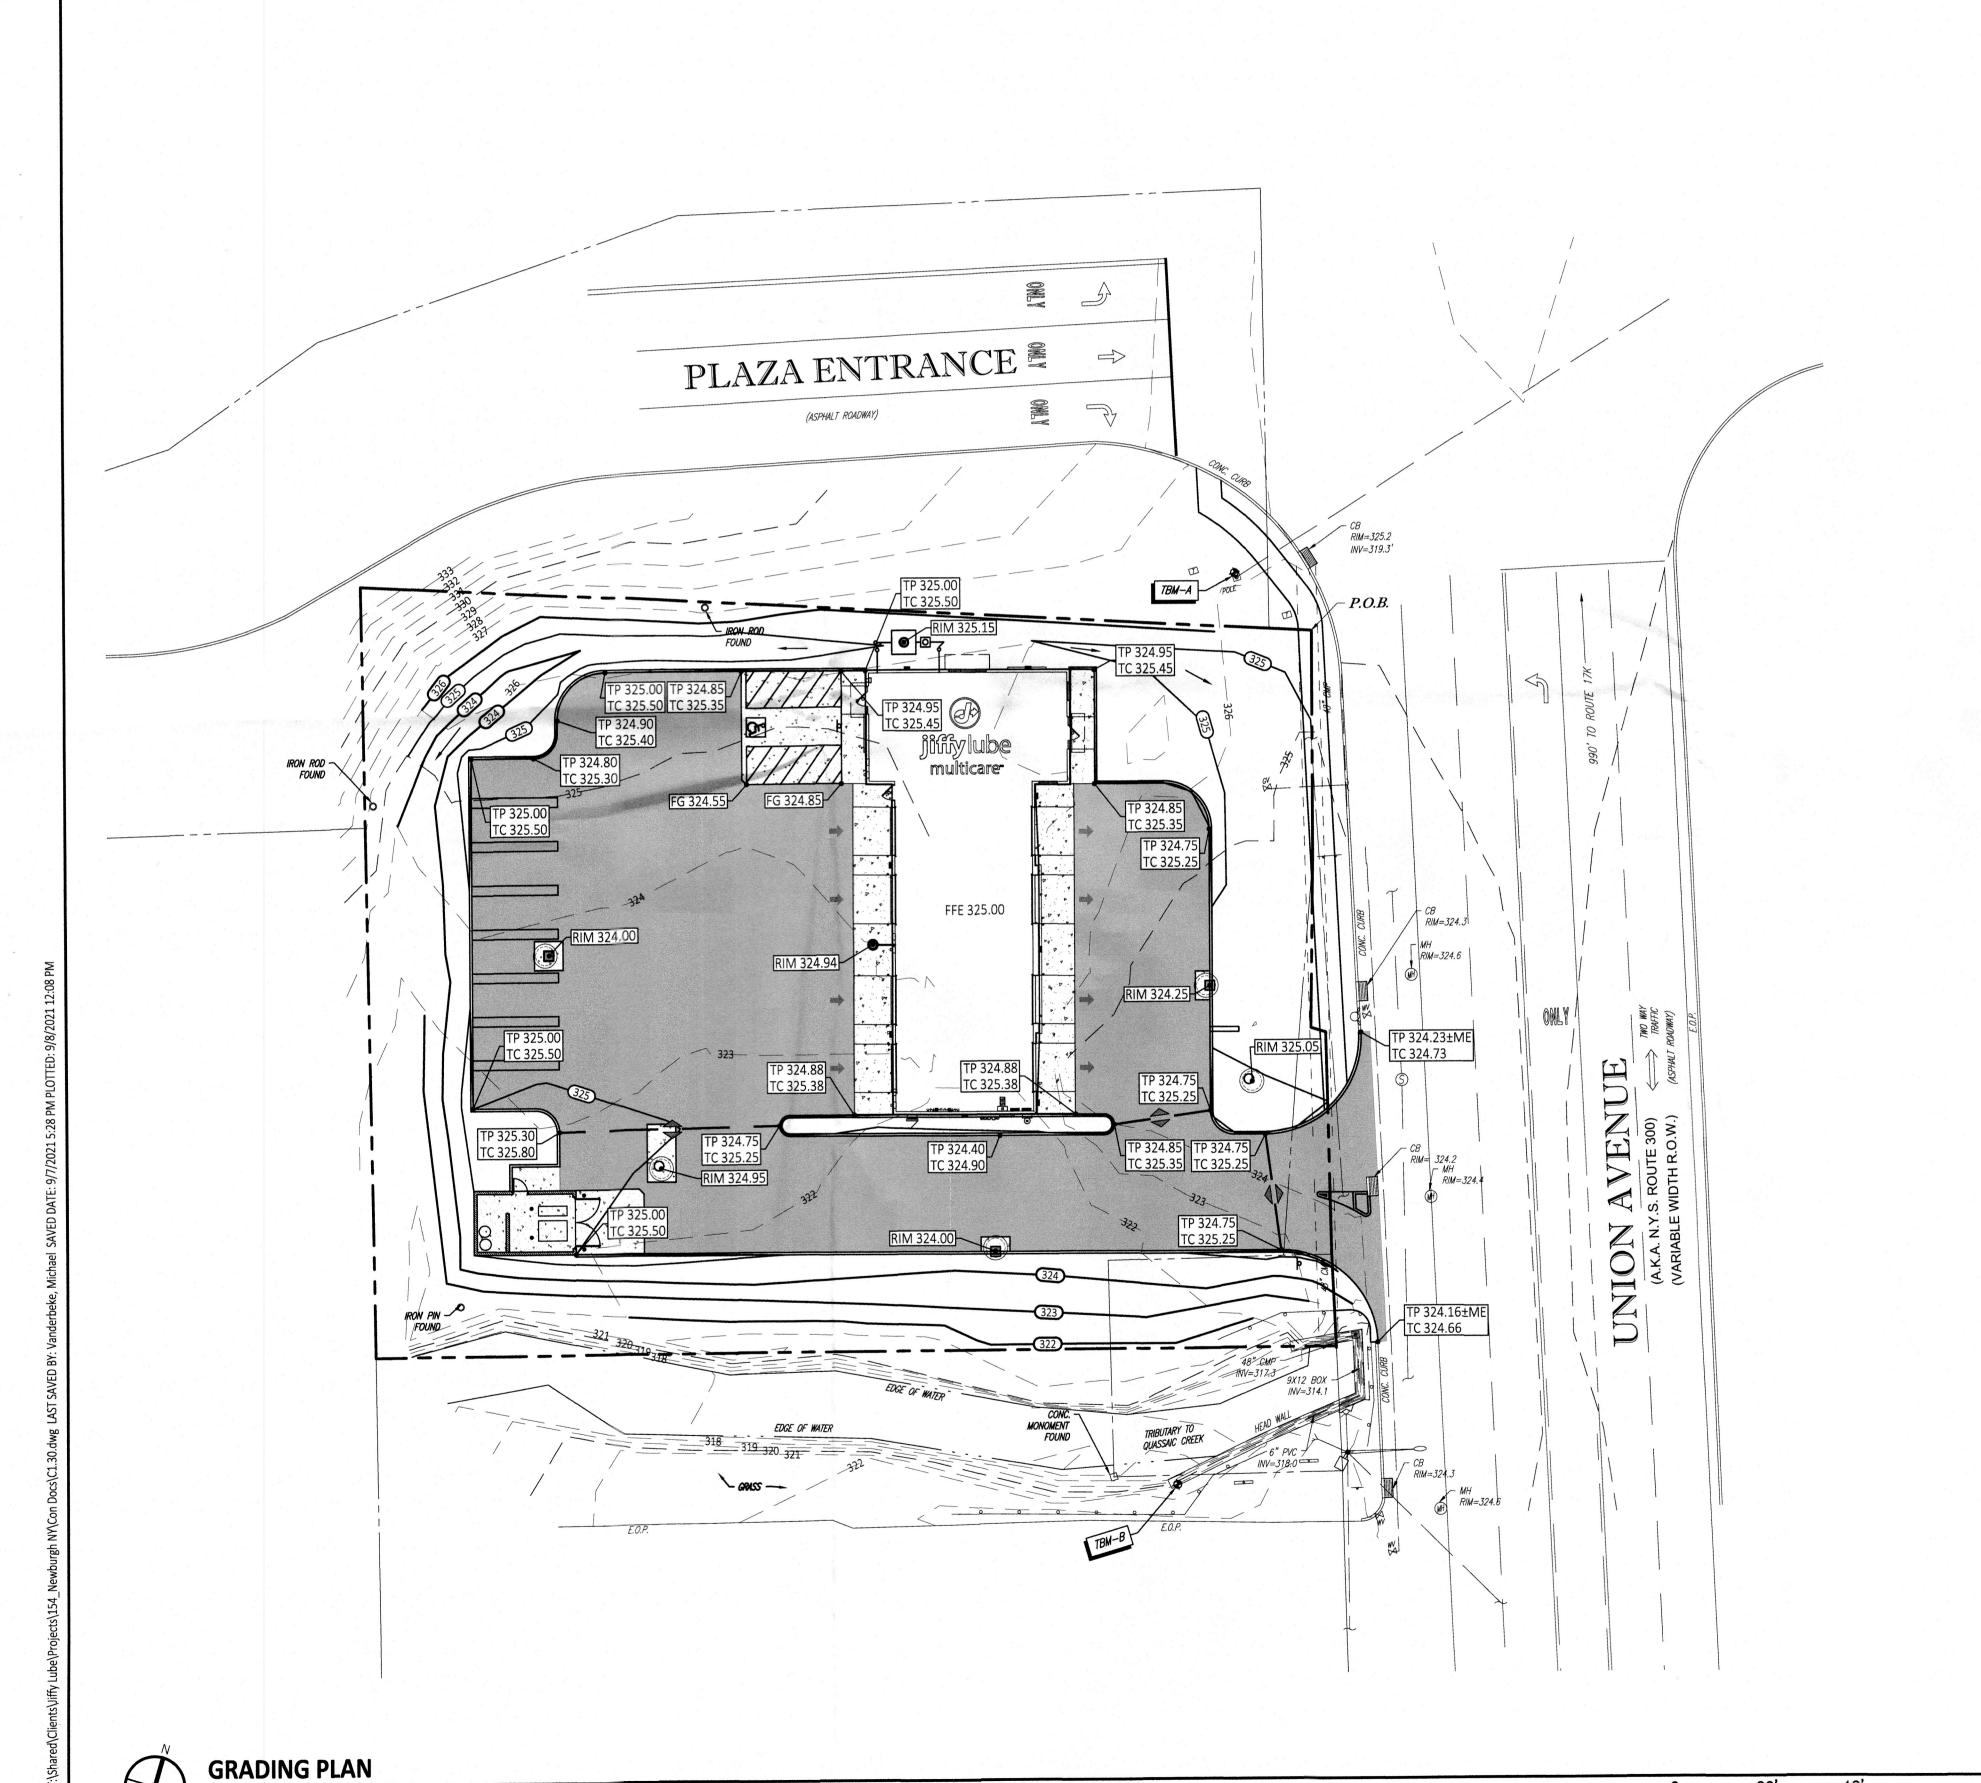

GRADING NOTES:

- 1. VERIFY REQUIRED SPOT ELEVATIONS/GRADING IN THE VICINITY OF THE BUILDING WITH THE ARCHITECTURAL
- 2. ALL MATERIALS AND CONSTRUCTION METHODS SHALL BE IN CONFORMANCE WITH THE DRAWINGS AND PROJECT MANUAL, AND WITH LOCAL JURISDICTIONAL AUTHORITY STANDARDS AND SPECIFICATIONS.
- 3. ALL PROPOSED SPOT ELEVATIONS IN PAVED AREAS ARE TO TOP OF PAVEMENT UNLESS NOTED OTHERWISE.
- 4. THE PROJECT SITE SHALL BE GRADED TO PROVIDE POSITIVE DRAINAGE AT ALL TIMES, ENSURING NO AREAS OF STANDING WATER.
- 5. THE GENERAL CONTRACTOR SHALL, AT HIS OR HER EXPENSE, RESTORE ANY AND ALL STRUCTURES, PIPE, UTILITY, PAVEMENT, CURB, SIDEWALK, LANDSCAPED AREA, ETC. DISTURBED WITHIN THE SITE AND/OR ADJOINING PROPERTIES DURING DEMOLITION OR CONSTRUCTION. SUCH FACILITIES SHALL BE RESTORED TO THEIR ORIGINAL CONDITION OR BETTER, TO THE SATISFACTION OF THE AFFECTED OWNER(S).
- 6. UNDERDRAINS MAY BE ADDED, IF DETERMINED NECESSARY BY THE GENERAL CONTRACTOR AND AUTHORIZED BY THE OWNER'S REPRESENTATIVE, AFTER SUBGRADE IS ROUGH GRADED.
- 7. UNLESS OTHERWISE EXPRESSLY INDICATED HEREON, FINISHED GRADES ARE TO MATCH ADJACENT EXISTING
- 8. ALL EXCAVATION IS CONSIDERED UNCLASSIFIED AND THE GENERAL CONTRACTOR IS RESPONSIBLE FOR ALL MEANS, METHODS AND MATERIALS OF CONSTRUCTION TO COMPLETE THE CONSTRUCTION PER THE DRAWINGS AND PROJECT MANUAL. ADDITIONALLY, THE GENERAL CONTRACTOR IS RESPONSIBLE FOR THE OFF-SITE DISPOSAL OF EXCESS OR UNSUITABLE MATERIAL, AS WELL AS THE IMPORTATION OF ANY BORROW MATERIAL NECESSARY TO COMPLETE THE PROJECT.

GRADING LEGEND:

- TG GUTTER GRADE
- TC TOP OF CURB
- BW FINISHED GRADE AT WALL
- FG FINISHED GRADE
- FL DITCH FLOW LINE TP TOP OF PAVEMENT
- RIM UNDERGROUND STRUCTURE RIM
- TW TOP OF WALK
- FFE FINISHED FLOOR ELEVATION
- ME MATCH EXISTING
- 2.0% PROPOSED SLOPE
- DIRECTION OF OVERLAND FLOW

SEVAL

Regional Office: 37704 Hills Tech Drive Farmington Hills, MI 48331 734.367.4445 Telephone

3025 Highland Parkway, Suite 850

Downers Grove, IL 60515

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REVISIONS

NO. DATE DESCRIPTION 0 06.21.2021 SITE PLAN REVIEW

1 09.07.2021 ZONING BOARD OF APPEALS

CONSULTANT





PROJECT DESCRIPTION

JIFFY LUBE

PROJECT LOCATION

MULTI-CARE SERVICES

1231 STATE ROUTE 300 NEWBURGH, NY 12550

(ORANGE COUNTY)


SHEET TITLE

GRADING PLAN

SHEET MANAGEMENT

PROJECT MANAGER: (NOT PUBLISHED: ALL RIGHTS RESERVED.)

C1.30

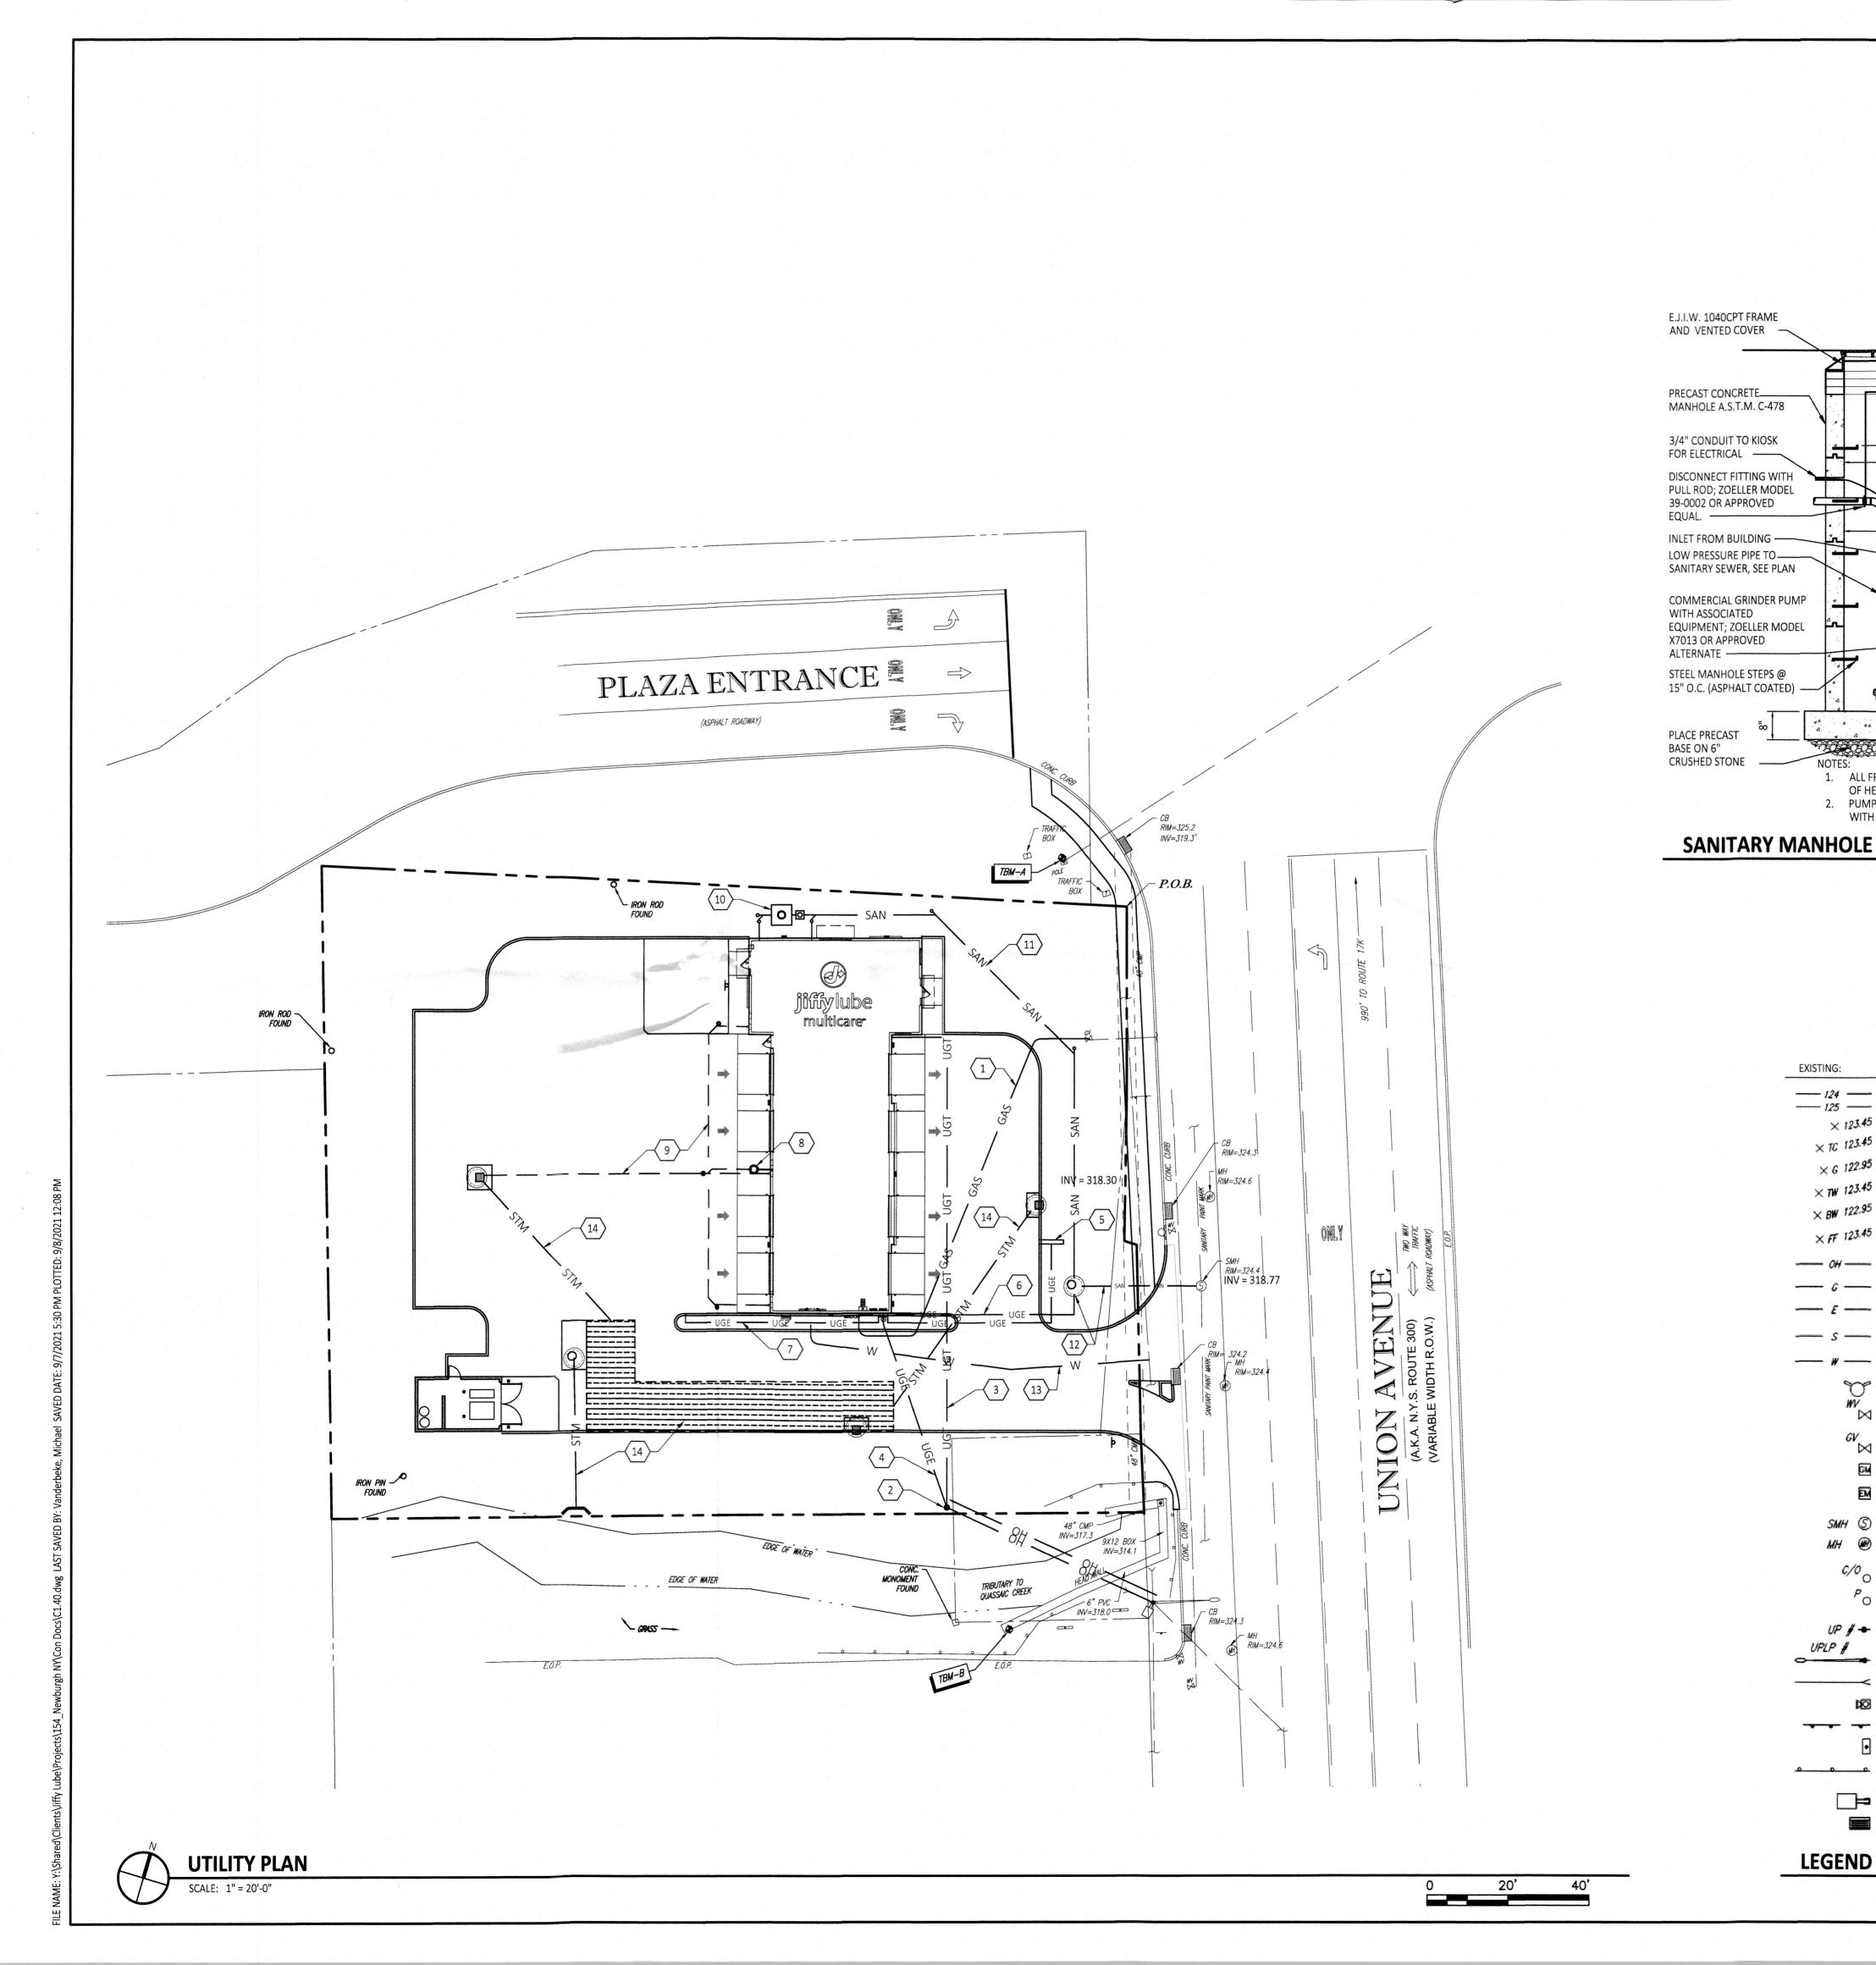



- NATURAL GAS SERVICE. 1-1/4 " INCOMING PIPING. VERIFY EXISTING SERVICE LINE AND VALVE AND REUSE IF FACILITIES ARE APPROPRIATE ALL MATERIALS AND INSTALLATION ARE TO BE IN ACCORDANCE WITH ALL STATE AND LOCAL CODES AND N.F.P.A. STANDARDS. CONTRACTOR SHALL COORDINATE WITH SERVICE PROVIDER TO VERIFY EXACT LOCATION OF SERVICE EXTENDED TO SITE. FINAL DESIGN AND INSTALLATION FEE TO BE DETERMINED BY UTILITY COMPANY ONCE A FORMAL WORK ORDER HAS BEEN SUBMITTED.
- 2 GENERAL CONTRACTOR TO PROVIDE AND INSTALL PRIVATE POWER POLE. TELECOM AND ELECTRIC COMPANIES TO EXTEND PRIMARY SERVICE FROM EXISTING POWER POLE AND PROVIDE POLE MOUNTED TRANSFORMER.
- TELECOMMUNICATION SERVICE. G.C. TO PROVIDE AND INSTALL (2) 2" CONDUIT W/ PULL STRING. VERIFY EXACT ROUTING AND TERMINATION REQUIREMENTS WITH SERVICE COMPANY BEFORE STARTING WORK. GENERAL CONTRACTOR TO COORDINATE WITH OTHER UTILITIES, UTILIZE SHARED TRENCHING IF PERMITTED AND COORDINATE ROUTING AND POINT OF CONNECTION WITH JIFFY LUBE CONSTRUCTION REPRESENTATIVE.
- 4 ELECTRIC SERVICE PROVIDE AND INSTALL (1) 4" SCHEDULE 40 PVC CONDUIT, (WITH TWO (2) PULL STRINGS) FOR ELECTRIC SUPPLY FROM THE TRANSFORMER TO BUILDING CONNECTION POINT. FIELD VERIFY AND COORDINATE EXACT CONDUIT ROUTING WITH THE JIFFY LUBE CONSTRUCTION REPRESENTATIVE PRIOR TO PROCEEDING. CONTRACTOR TO INSTALL SERVICE PER ALL STATE AND LOCAL CODES, POWER COMPANY, N.F.P.A., AND N.E.C. STANDARDS AND COORDINATE WITH THE POWER COMPANY TO VERIFY THE FINAL DESIGN AND INSTALLATION FEE ONCE A FORMAL WORK ORDER HAS BEEN SUBMITTED.
- 5 SITE SIGN. PROVIDE AND INSTALL (2) 1" PVC SCH 40 CONDUITS TO FINAL SIGN LOCATION. SEE ELECTRICAL PLANS.
- 6 SANITARY PUMP POWER. PROVIDE 1-1/2" P.V.C. CONDUIT TO ELECTRIC PANEL. SEE ARCHITECTURAL SHEETS FOR CIRCUITING.
- 7 PROVIDE AND INSTALL (1) 1" PVC SCH 40 CONDUITS FOR DRIVE SIGNAL CHIME BELT. DAYLIGHT THOUGH CURB AT GRADE. VERIFY LOCATION WITH OWNER'S CONSTRUCTION
- 8 SUMP PIT CONNECTED TO ROOF DRAIN CONDUCTORS/STORM.
- 9 ROOF DRAIN CONDUCTORS.

- GRADE OR PAVEMENT

SURFACE

OF HEAVY DUTY CAST IRON

EXISTING:

ALL FRAMES AND COVERS SHALL BE NON-ROCKING AND MADE

2. PUMP TO BE INSTALLED PER MANUFACTURER'S INSTRUCTIONS

WITH STAINLESS STEEL LIFTING BAIL AND CABLE.

EXISTING CONTOUR

METAL GUIDE RAIL

CATCH BASIN OR INLET

AREA LIGHT

LEGEND

- 10 OIL/WATER SEPARATOR AND MONITORING WELL. CONNECTED TO SANITARY SERVICE.
- 11 PROVIDE AND INSTALL 6" PVC SDR-35 SANITARY SERVICE AT MIN. 1% SLOPE WITH CLEAN-OUTS 5.0' OUTSIDE OF FOUNDATION AND AT EVERY HORIZONTAL AND VERTICAL BEND PER CLEAN-OUT DETAIL. COORDINATE LOCATION OF SANITARY SEWER LATERAL THROUGH FOUNDATION WITH STRUCTURAL DRAWINGS. MAINTAIN A MINIMUM OF 10' HORIZONTAL AND 18" VERTICAL SEPARATION FROM WATER. MAKE CONNECTION TO EXISTING SANITARY MAIN PER SERVICE PROVIDER AND OR MUNICIPAL STANDARDS. SEE DETAILS ON SHEET 5.02.
- PROVIDE AND INSTALL SEWER PUMP STRUCTURE AND 2" SCH. 40 PVC LOW PRESSURE SANITARY PIPE (MIN. DEPTH 4.0'); TAP SANITARY SEWER MANHOLE WATERTIGHT PRESSURE RATED GASKET. COORDINATE WITH THE CITY OF NEWBURGH PUBLIC UTILITIES.
- 13 1 1/4" DOMESTIC WATER SERVICE. PIPING TO BE COPPER TYPE K OR OWNER APPROVED EQUIVALENT. MINIMUM BURIAL DEPTH TO BE 5.0'BELOW FINISHED GRADE. PROVIDE 18" CLEARANCE AT ALL UTILITY CROSSINGS. CONTRACTOR TO VERIFY REQUIREMENTS OF LOCAL CODES, UTILITY COMPANIES AND GOVERNING OFFICIALS. INCLUDE IN BASE BID ALL VALVES, PIPING, STRUCTURES, ETC. THAT WILL BE REQUIRED.
- 14 STORM WATER SYSTEM. CONVEYANCE, STORAGE AND WATER QUALITY SYSTEMS PER NYDOT REQUIREMENTS

TILITY EASEMENT NOTE:

REFER TO THE BOUNDARY/TOPOGRAPHIC SURVEY PREPARED BY CONTROL POINT INDUSTRIAL SURVEYING FOR INFORMATION REGARDING EXISTING UTILITIES AND EASEMENTS.

IF BASEMENTS ARE INVOLVED, ALL WATER MAIN SERVICE LEADS SHALL BE PRETAPPED PRIOR TO BASEMENT EXCAVATION.

— STM —

--- GAS ---

--- UGE ---

— UGT —

— OH —

--- STM ---

LIGHT POLE

•--• FUEL VENT

AIR TOWER

SANITARY MANHOLE

SANITARY CLEANOUT

WATER VALVE

TRANSFORMER

EXISTING SPOT ELEVATION EXIST. TOP OF CURB ELEVATION EXIST. GUTTER ELEVATION EXIST. TOP OF WALL ELEVATION EXIST. BOTTOM OF WALL ELEVATION EXIST. FINISHED FLOOR ELEVATION OVERHEAD WIRES APPROX. LOC. UNDERGROUND GAS LINE APPROX. LOC. UNDERGROUND ELEC. LINE APPROX. LOC. UNDERGROUND SAN. LINE APPROX. LOC. UNDERGROUND WATER LINE HYDRANT WATER VALVE PROPOSED: GAS VALVE STORM SEWER GAS METER **ROOF DRAIN** ELECTRIC METER SANITARY SEWER SANITARY/SEWER MANHOLE WATER MAIN/SERVICE UNKNOWN MANHOLE GAS MAIN/SERVICE **CLEAN OUT ELECTRIC SERVICE** Po POST TELEPHONE SERVICE OVERHEAD UTILITIES PROPOSED UTILITIES BY OTHERS UTILITY POLE/LIGHT POLE STORM MANHOLE **GUY WIRE** CATCH BASIN TRAFFIC SIGNAL YARD BASIN MAIL BOX FLARED END SECTION

ENGINEERING 37704 Hills Tech Drive Farmington Hills, MI 48331 734.367.4445 Telephone Corporate Office:

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fo@sevansolutions.com www.sevansolutions.co TEGRITY | RESPECT | TEAMWORK | EXCELLENCE | CHAR

REVISIONS DATE DESCRIPTION 06.21.2021 SITE PLAN REVIEW . |09.07.2021|ZONING BOARD OF APPEALS

CONSULTANT

09/08/2021 **CUSTOMER**

PROJECT DESCRIPTION

JIFFY LUBE MULTI-CARE SERVICES

PROJECT LOCATION

1231 STATE ROUTE 300 NEWBURGH, NY 12550

(ORANGE COUNTY)

SHEET TITLE

UTILITY PLAN

PROJECT NO.: 154-NEWBURGH CRITERIA: V2020.10-1X4

PROJECT MANAGER: THIS DOCUMENT IS AND SHALL REMAIN THE PROPERTY OF SEVAN MULTI-SITE SOLUTIONS, INC. (NOT PUBLISHED: ALL RIGHTS RESERVED.)

SHEET NUMBER


C1.40

PLANTING NOTES

- 1 ALL TREES AND SHRUBS SHALL BE STAKED IN THE FIELD PER PROVIDED DETAILS
- 2 PLANT MATERIAL SHALL CONFORM TO THE PLANT LIST AND KEYS ON THE DRAWINGS AND TO THE QUALITY STANDARDS OF 'AMERICAN STANDARD FOR NURSERY STOCK'. ALL PLANTS SHALL EQUAL OR EXCEED THE MEASUREMENTS AND SIZES SPECIFIED IN THE SCHEDULE.
- 3 PLANT TREES AND SHRUBS GENERALLY NO CLOSER THEN THE FOLLOWING DISTANCES FROM SIDEWALKS, CURBS, AND PARKING STALLS:
 - A. SHADE TREES: 5 FEET

AT PRODUCT SPECIFIED RATE UNLESS OTHERWISE NOTED.

- B. ORNAMENTAL AND EVERGREEN TREES: 10 FEET (CRAB, PINE, SPRUCE, ETC.) C. SHRUBS: 4 FEET 4 ALL SHRUB PLANTINGS WITHIN SITE TRIANGLE AREAS TO BE MAXIMUM HEIGHT OF 30", AND
- FIRST BRANCHING FOR PROPOSED TREES TO BE MINIMUM OF 7' ABOVE PROPOSED GRADES. PLANTINGS SHALL BE FERTILIZED UPON INSTALLATION WITH A SLOW RELEASE GRANULAR COMMERCIAL TREE/SHRUB FERTILIZER. RATE PER MANUFACTURES INSTRUCTIONS. FERTILIZER TO MIXED WITH BACKFILL PREVIOUSLY DESCRIBED. FERTILIZER TABLETS ARE NOT ACCEPTABLE, PLANTING BEDS SHALL BE COVERED WITH PRE-EMERGENT HERBICIDE APPLIED
- THE LANDSCAPE CONTRACTOR SHALL GUARANTEE ALL PLANTS INSTALLED FOR ONE FULL YEAR FROM DATE OF ACCEPTANCE BY THE OWNER. ALL PLANTS SHALL BE ALIVE AND AT A VIGOROUS RATE OF GROWTH AT THE END OF THE GUARANTEE PERIOD. UNACCEPTABLE PLANT MATERIAL THAT IS DETERMINED DEAD, IN AN UNHEALTHY OR UNSIGHTLY CONDITION, LOST ITS SHAPE DUE TO DEAD BRANCHES OR OTHER SYMPTOM OF POOR, NON-VIGOROUS GROWTH SHALL BE REPLACED BY THE LANDSCAPE CONTRACTOR.

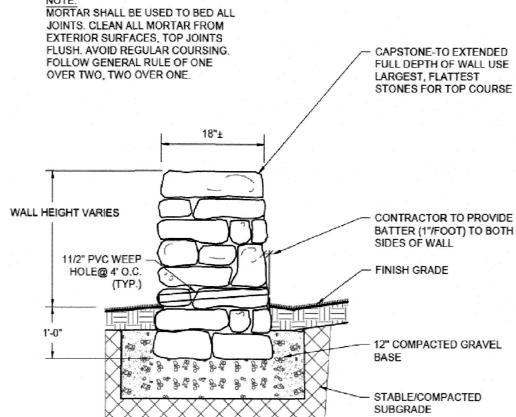

LANDSCAPE CODE


ALL OPEN PARKING AREAS SHALL BE SUITABLY LANDSCAPED. IN PARKING LOTS WITH MORE THAN 20 SPACES, AT LEAST 5% OF THE AREA OF THE PARKING LOT SHALL BE DEVOTED TO LANDSCAPING WITHIN THE INTERIOR OF THE PARKING LOT PROPOSED DEVELOPMENT IS UNDER 20 PARKING SPACES

KEYED NOTES

- 1 EXISTING WOODED AREA TO REMAIN. SEE TREE PROTECTION DETAIL.
- TREE PROTECTION FENCING

P.O.B.

3 STONE WALL 2.5' HIGH. SEE EXAMPLE ON THIS PLAN

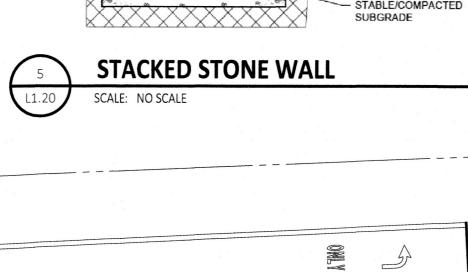

iiiiivlube

multicare -

BARARO CO GOORAGA


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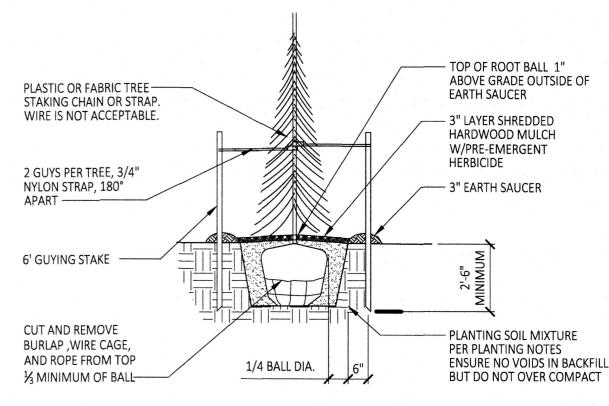
PLAZA ENTRANCE

(ASPHALT ROADWAY)

1/1//

EDGE OF WATER



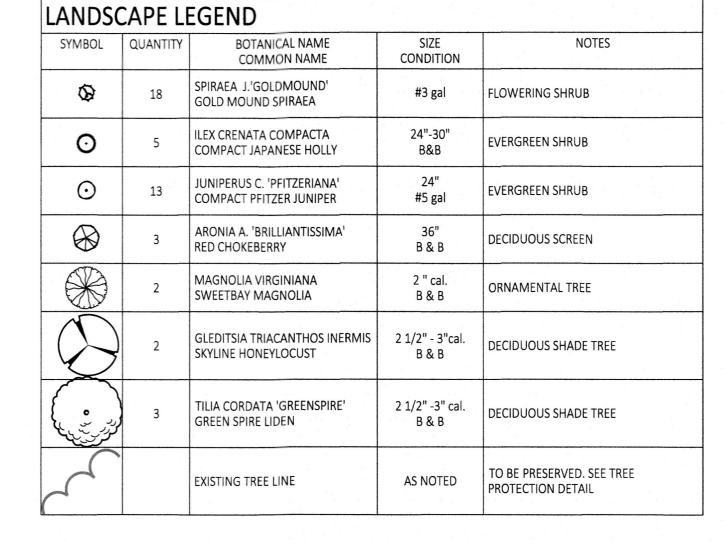

ENGINEERING

37704 Hills Tech Drive

Farmington Hills, MI 48331

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nfo@sevansolutions.com www.sevansolutions.co

NTEGRITY | RESPECT | TEAMWORK | EXCELLENCE | CHARIT

REVISIONS

1 09.07.2021 ZONING BOARD OF APPEALS

CONSULTANT

SEAL

09/08/2021

CUSTOMER

PROJECT DESCRIPTION

JIFFY LUBE

MULTI-CARE SERVICES

PROJECT LOCATION

1231 STATE ROUTE 300

NEWBURGH, NY 12550

(ORANGE COUNTY)

SHEET TITLE

LANDSCAPE PLAN,

NOTES AND SCHEDULE

SHEET MANAGEMENT

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SHEET NUMBER

154-NEWBURGH

V2020.10-1X

PROJECT NO .

RITERIA:

ROJECT MANAGER:

DATE DESCRIPTION





- 1 AT THE TIME OF SITE PREPARATION, CONTRACTOR TEAM (GENERAL, GRADING & LANDSCAPE) TO REVIEW ALL EXISTING VEGETATION, AND TAG MATERIALS TO BE SAVED OR RELOCATED.
- PRIOR TO INSTALLATION, THE LANDSCAPE CONTRACTOR SHALL INSPECT THE SUBGRADE, GENERAL SITE CONDITIONS, VERIFY ELEVATIONS, UTILITY LOCATIONS, IRRIGATION, APPROVE TOPSOIL PROVIDED BY GENERAL CONTRACTOR AND OBSERVE THE SITE CONDITIONS UNDER WHICH THE WORK IS TO BE DONE. NOTIFY GENERAL CONTRACTOR OF ANY UNSATISFACTORY CONDITIONS AND WORK SHALL NOT PROCEED UNTIL SUCH CONDITIONS HAVE BEEN CORRECTED AND ARE ACCEPTABLE TO THE LANDSCAPE CONTRACTOR.
- 3 IF THE LANDSCAPE CONTRACTOR OBSERVES ANY DEFICIENCIES IN THE PLANT SELECTIONS, SOIL CONDITIONS OR ANY OTHER CONDITION WHICH MIGHT NEGATIVELY AFFECT PLANT ESTABLISHMENT, SURVIVAL OR GUARANTEE, HE SHALL NOTIFY THE LANDSCAPE ARCHITECT OR OWNERS REPRESENTATIVE PRIOR TO PROCUREMENT AND/OR INSTALLATION.
- 4 LOCATE ALL UTILITIES PRIOR TO DIGGING, CONTRACTOR SHALL BE RESPONSIBLE FOR ALL DAMAGES.. DO NOT PLANT TREES, EVERGREENS, AND SHRUBS OVER ANY EXISTING OR PROPOSED UTILITY LINES AS SHOWN ON THE OVERALL LANDSCAPE PLAN. ANY ITEM OR AREAS DAMAGED DURING CONSTRUCTION SHALL BE REPAIRED OR REPLACED TO ITS ORIGINAL CONDITION AT THE CONTRACTORS EXPENSE.
- 5 ALL PLANTING BEDS TO RECEIVE 6" MIN. OF PREPARED BACKFILL MIX. ALL INDIVIDUALLY PLANTED TREES AND SHRUBS TO BE BACKFILLED WITH WITH PREPARED BACKFILL MIX. PREPARED BACKFILL MIXTURES SHALL BE MIXED ON SITE, CONSISTING OF ONE PART TOPSOIL, ONE PART SOIL AMENDMENT, ONE PART SOIL FROM EXCAVATION.
- 6 PLANT BEDS TO DRESSED WITH PRE-EMERGENT HERBICIDE AND MULCHED WITH 3" OF SHREDDED HARDWOOD WITH . SEE DETAIL THIS SHEET.
- 7 ALL PLANTING BED EDGES TO BE SMOOTH FLOWING ARCS. BEDS TO BE LAID OUT AND APPROVED BY LANDSCAPE ARCHITECT OR OWNERS REPRESENTATIVE PRIOR TO PLANTING. LAWN TREES TO BE MULCHED WITH 4' DIAMETER BED WITH 3" MULCH RING
- 8 SEED OR SOD ALL AREAS, WITHIN CONTRACT LIMITS, NOT COVERED BY PAVING, BUILDINGS OR PLANTING BEDS UNLESS OTHERWISE NOTED. SODDING SHALL NOT BEGIN UNTIL AREA HAS RECEIVED A FINISHED GRADE. SEE SOD/SEED NOTES.
- 9 SUBSTITUTIONS SHALL BE PERMITTED WITH NOTIFICATION AND WRITTEN APPROVAL FROM LANDSCAPE ARCHITECT OR OWNERS REPRESENTATIVE. SUBSTITUTED MATERIAL SHALL BE THE NEAREST EQUIVALENT SIZE, CONDITION AND GROWTH HABIT HAVING THE SAME ESSENTIAL CHARACTERISTICS WITH AN EQUITABLE ADJUSTMENT IN WHOLESALE PRICE.
- 10 LANDSCAPING TO COMPLY WITH ALL APPLICABLE ZONING REGULATIONS OF THE CITY OF NEWBURGH.

SEEDING NOTES

SITE PREPARATION:


- 1 SITE TO BE FINE GRADED BEFORE PERMANENT SEEDING OR SODDING.
- 2 SOIL SHALL BE LOOSENED TO A DEPTH OF (4) INCHES BY DISCING, RAKING, ROTOTILLING OR OTHER ACCEPTABLE MEANS. AND RAKED SMOOTH AND FREE OF ROOTS AND STONES OVER
- 3 ENSURE PROPER DRAINAGE AND CHANNEL FLOW PROTECTION

SEED INSTALLATION


- 1 APPLY STARTER FERTILIZER AT TIME OF SEEDING AT RATE RECOMMENDED BY MANUFACTURER. CONTRACTOR IS RESPONSIBLE FOR THE INITIAL WATERING.
- 2 SEED WITH COMMERCIAL TURF BLEND FROM APPROVED DOT LIST OF MIXTURES
- 3 MAXIMUM SEEDING DEPTH SHOULD BE 1/4 INCH ON CLAY SOILS AND 1/2 INCH ON SANDY SOILS, WHEN USING OTHER THAN HYDROSEEDER METHOD OF APPLICATION. STRAW MULCH SHALL BE APPLIED IMMEDIATELY AFTER SEEDING (NON HYDROSEEDING). AT A RATE OF 140 LBS.± (2 BALES) PER 1000 SF. MULCH MAY BE APPLIED BY HAND OR WITH A BLOWER.
- 4 MULCH SHALL BE CLEAN, WELL SEASONED STRAW FREE OF SEEDS OR ROOTS OF NOXIOUS
- 5 IF HYDROSEEDING IS USED AND THE SEED, FERTILIZER AND MULCH ARE MIXED, THEY WILL BE MIXED ON SITE AND SEEDING SHALL BE IMMEDIATE WITHOUT INTERRUPTION, MULCH FOR HYDROSEEDING SHALL BE WOOD CELLULOSE FIBER MULCH APPLIED AT A RATE OF 2,000 LBS. / ACRE.

MAINTENANCE


- WATER 1 INCH MIN. WITHIN THE FIRST HOUR OF SOD OR SEED INSTALLATION BEGIN IRRIGATION. SYSTEM DURING THE FOLLOWING 3 DAYS KEEPING THE SODDED OR SEEDED
- 2 CONTINUED MAINTENANCE (MOWING, FERTILIZATION, WEEDING, ECT.) OF THE SODDED OR SEEDED AREA SHOULD BE PROVIDED BY A PROFESSIONAL LANDSCAPE MAINTENANCE CONTRACTOR.

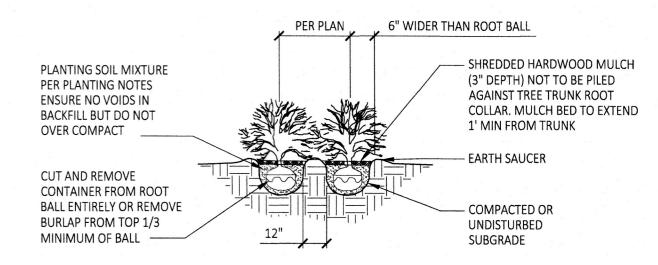




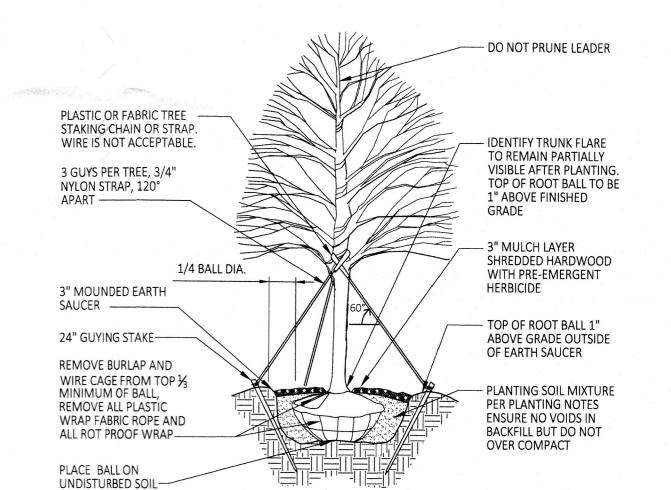



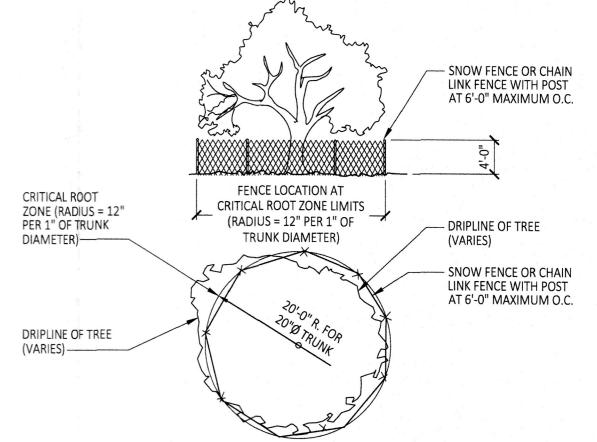



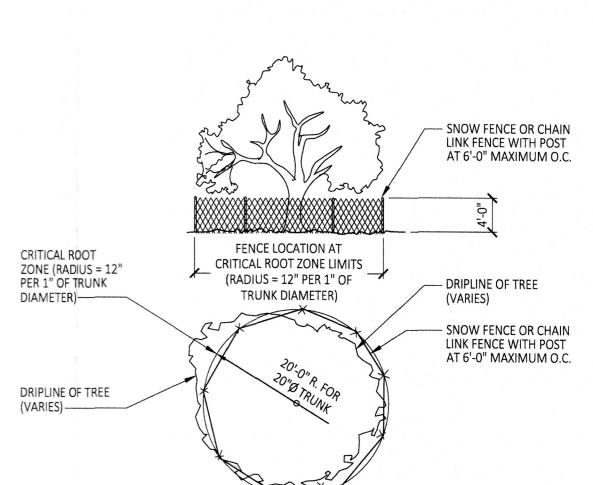


L1.20



LANDSCAPE PLAN

VEN

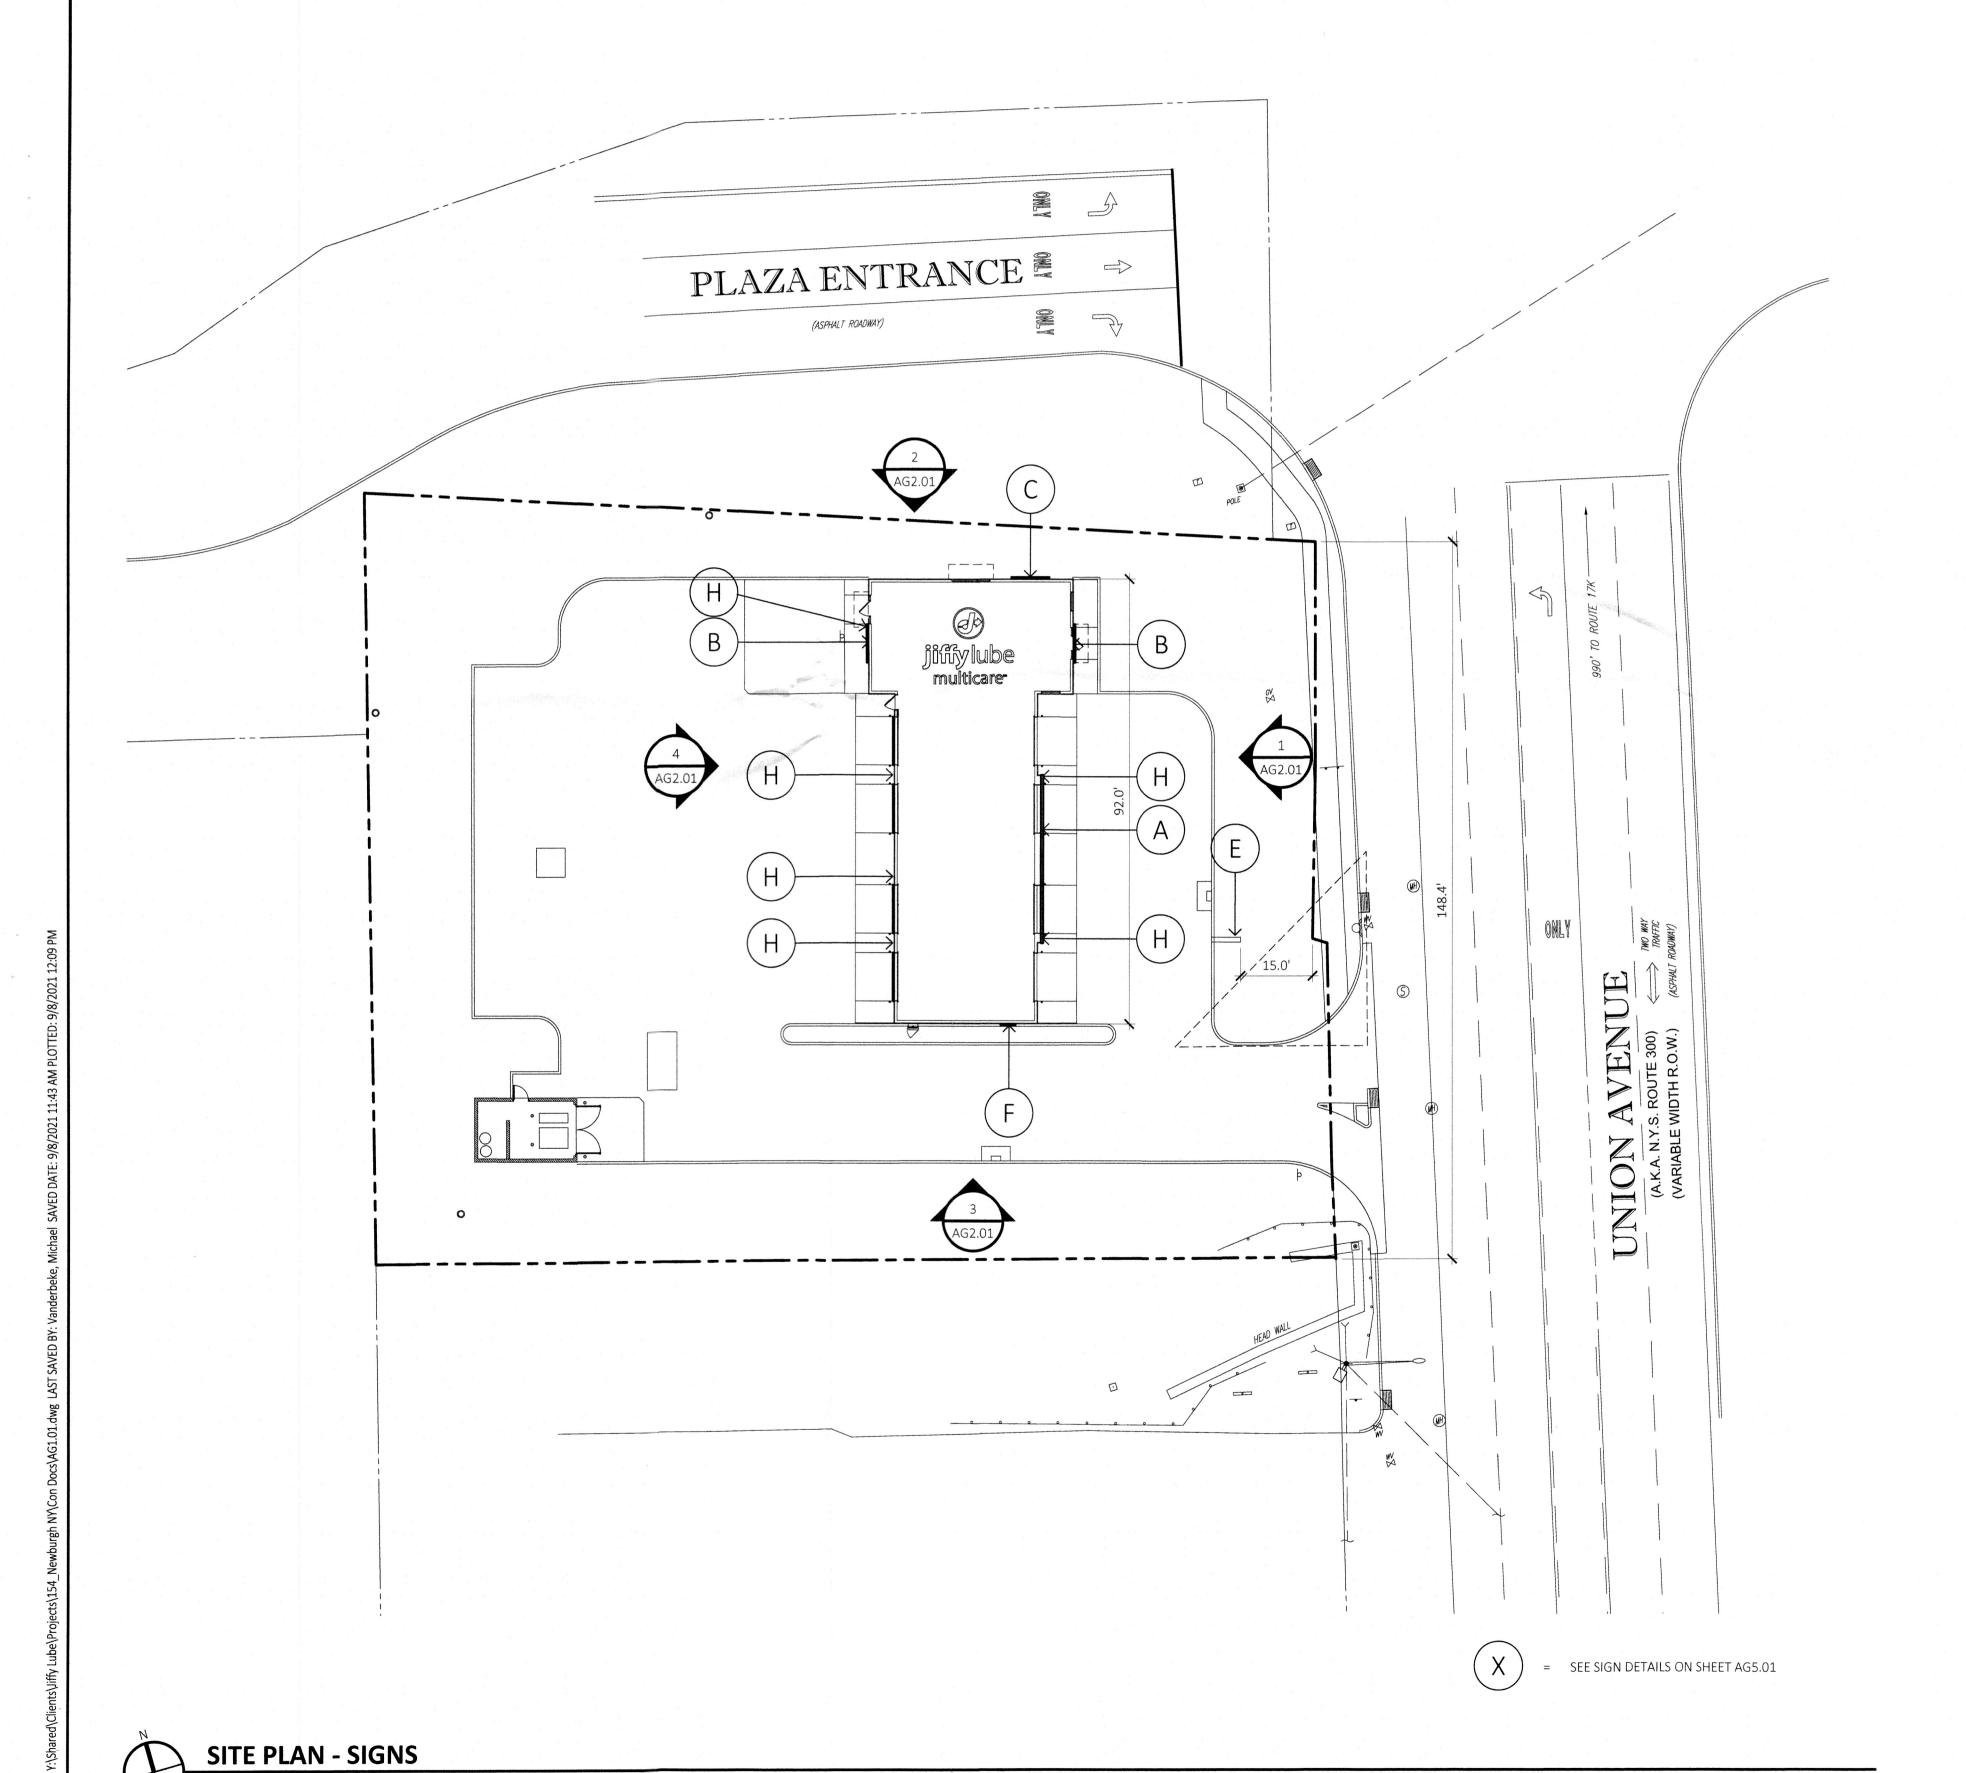

0 20' 40'

PYLON SIGN: ALLOW	ED; YES			
	MAXIMUM:	PROVIDED:	CODE:	VARIAN
AREA:	60 S.F.	37 S.F.		
HEIGHT:	35.0'	25.0'		NO
SETBACK:	FRONT: WITHIN 15.0' OF FRONT PROPERTY LINE	15.0'	185.14.N.2	
NUMBER OF SIGNS	1	1		NO
ELECTRONIC MESSAC	GE DISPLAY: ALLOWED	WITH SPECIAL USE AP	PROVAL	
AREA: LESS THAN ⅓ AREA OF SIGN = 11 S.F. 9 S.F		9 S.F.	185.14.P.2	NO
BUILDING SIGNS: ALL	OWED: YES - SECTION	185.14.N		
ELEVATION	SIGN	ALLOWED:	PROVIDED:	VARIAN
FRONT ELEVATION	SIGN - A	PER TOTAL	28 S.F. 7 S.F.	NO
PROINT ELEVATION	SIGN - B	PER TOTAL	38.0'	NO
SIDE ELEVATION (NORTH)	SIGN - C	PER TOTAL	30 S.F.	NO
SIDE ELEVATION (SOUTH)	SIGN - F	PER TOTAL	9 S.F.	NO
REAR ELEVATION	SIGN - B	PER TOTAL	38 S.F.	NO
TOTAL ALLOWED ON BUILDING:		92 S.F.	150 S.F.	YES
DIRECTIONAL SIGNS	SIGN - H	4 S.F. DIRECTIONAL SIGN AREA	5.32 S.F.	YES

SEVAN

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REVISIONS

NO. DATE DESCRIPTION

0 06.21.2021 SITE PLAN REVIEW

1 09.07.2021 ZONING BOARD OF APPEALS

CONSULTANT

SEAL

SEAL

OF NEW LORA

LICENSTITUTION OF SENONA

096960

09708/2021

jiffy lube

PROJECT DESCRIPTION

JIFFY LUBE
MULTI-CARE SERVICES

PROJECT LOCATION

1231 STATE ROUTE 300 NEWBURGH, NY 12550

(ORANGE COUNTY)

SHEET TITLE

SITE PLAN - SIGNS


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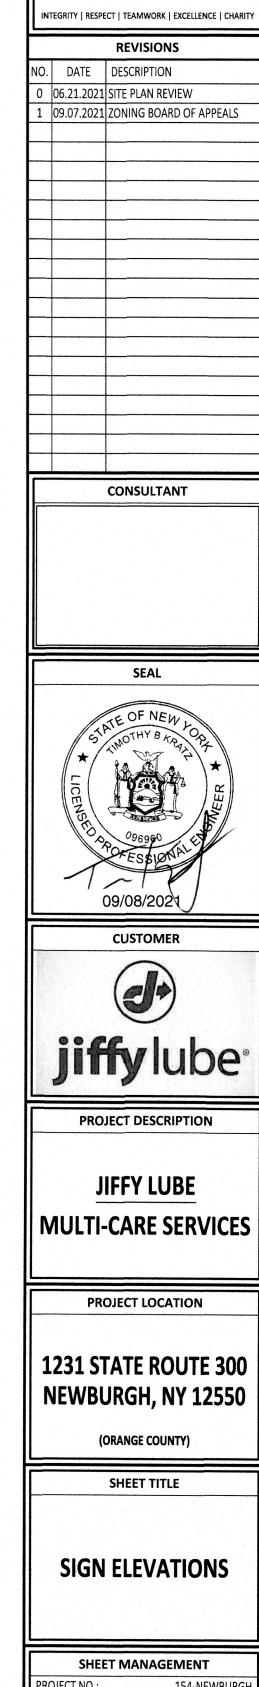
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SHEET NUMBER

AG1.01





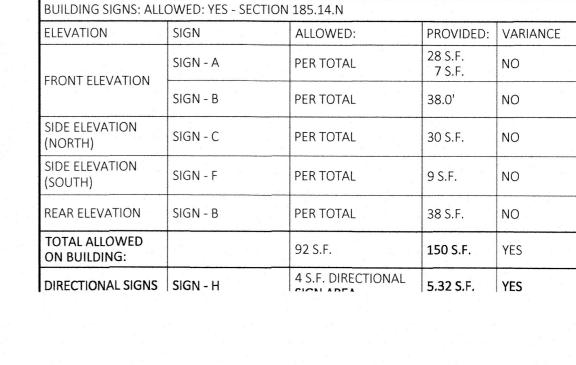

SEVƏN

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SHEET MANA	AGEMENT
PROJECT NO.:	154-NEWBURG
DATE:	
CRITERIA:	V2020.10-1X
PROJECT MANAGER:	M. PISK

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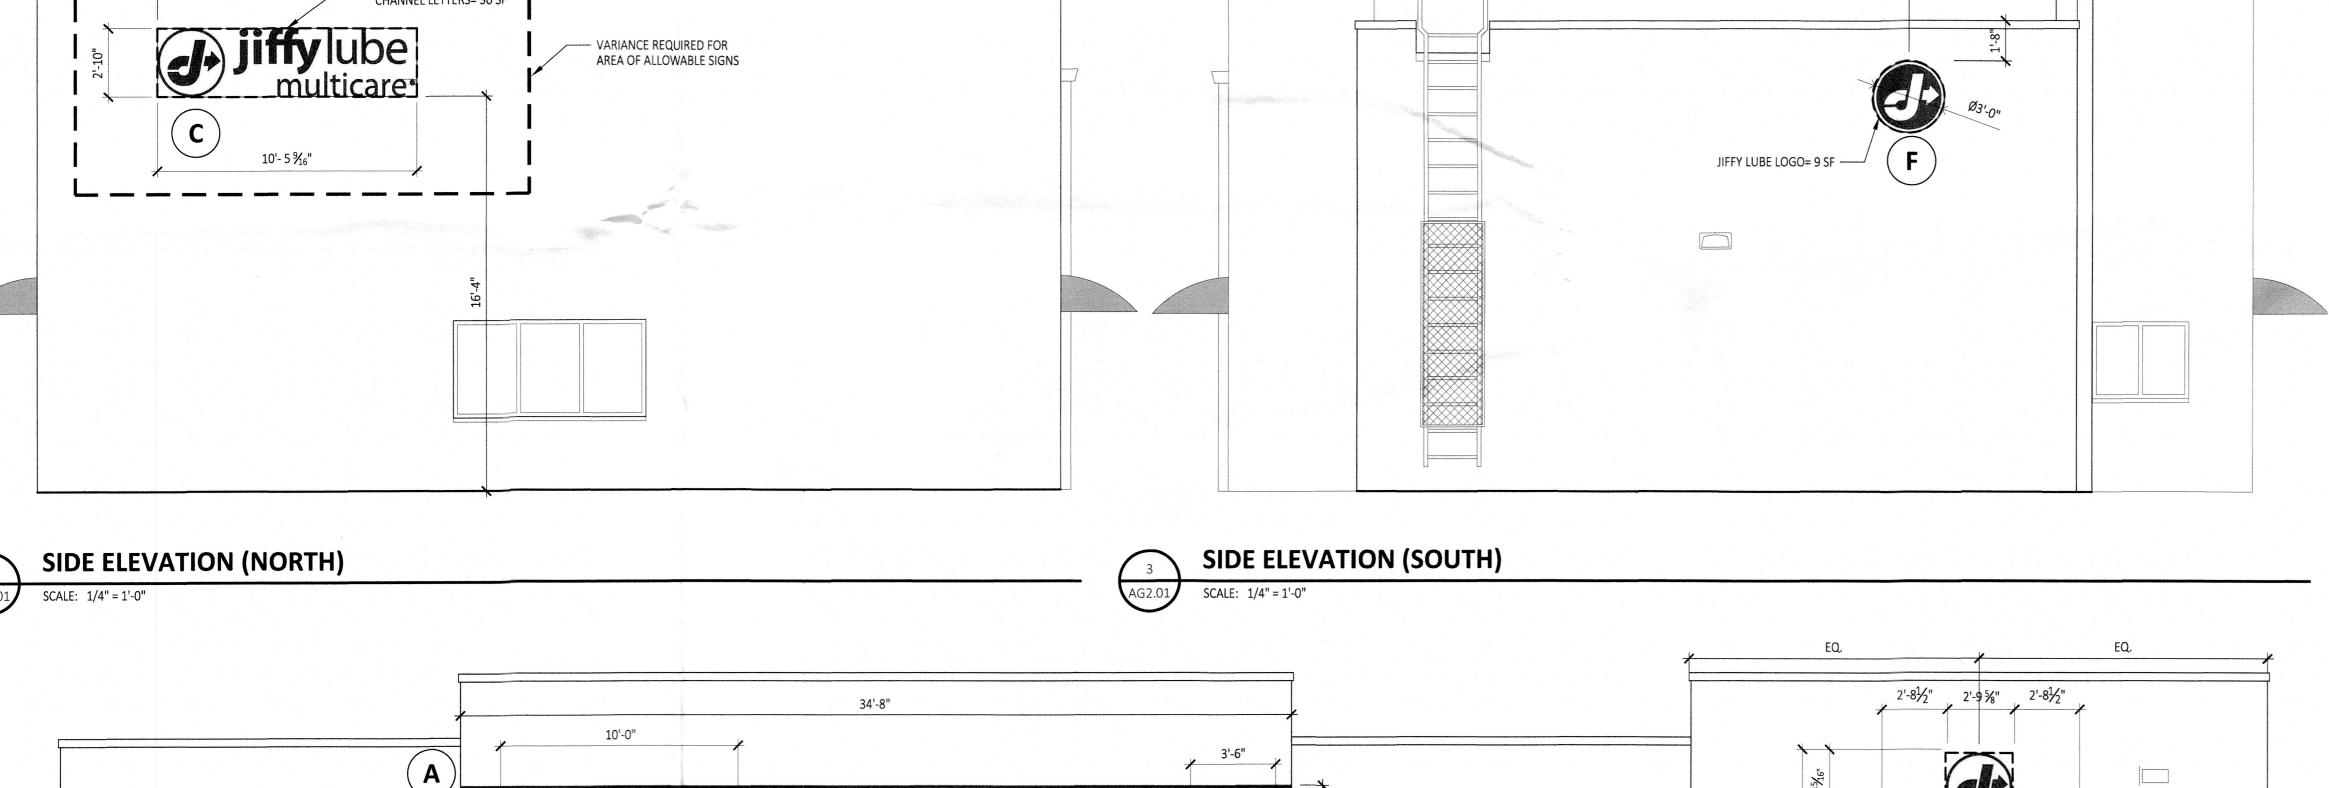
1. FIREWORKS RED SW 6867

2. COLONIAL REVIVAL SW 2827

4. CARMINE RED SW 2905

AG2.01

SHEET NUMBER



JLM WALL SIGN= 7 SF

- ENTRY/EXIT SIGN= 5.32 SF -

_multicare •

(B)


JLM VERTICAL CHANNEL LETTERS= 38 SF -----

VARIANCE REQUIRED FOR MAXIMUM SIGN AREA OF 4 S.F. (TYPICAL FOR 2 SIGNS)

JLM WALL SIGN= 28 SF -

FRONT ELEVATION (EAST)

SCALE: 1/4" = 1'-0"

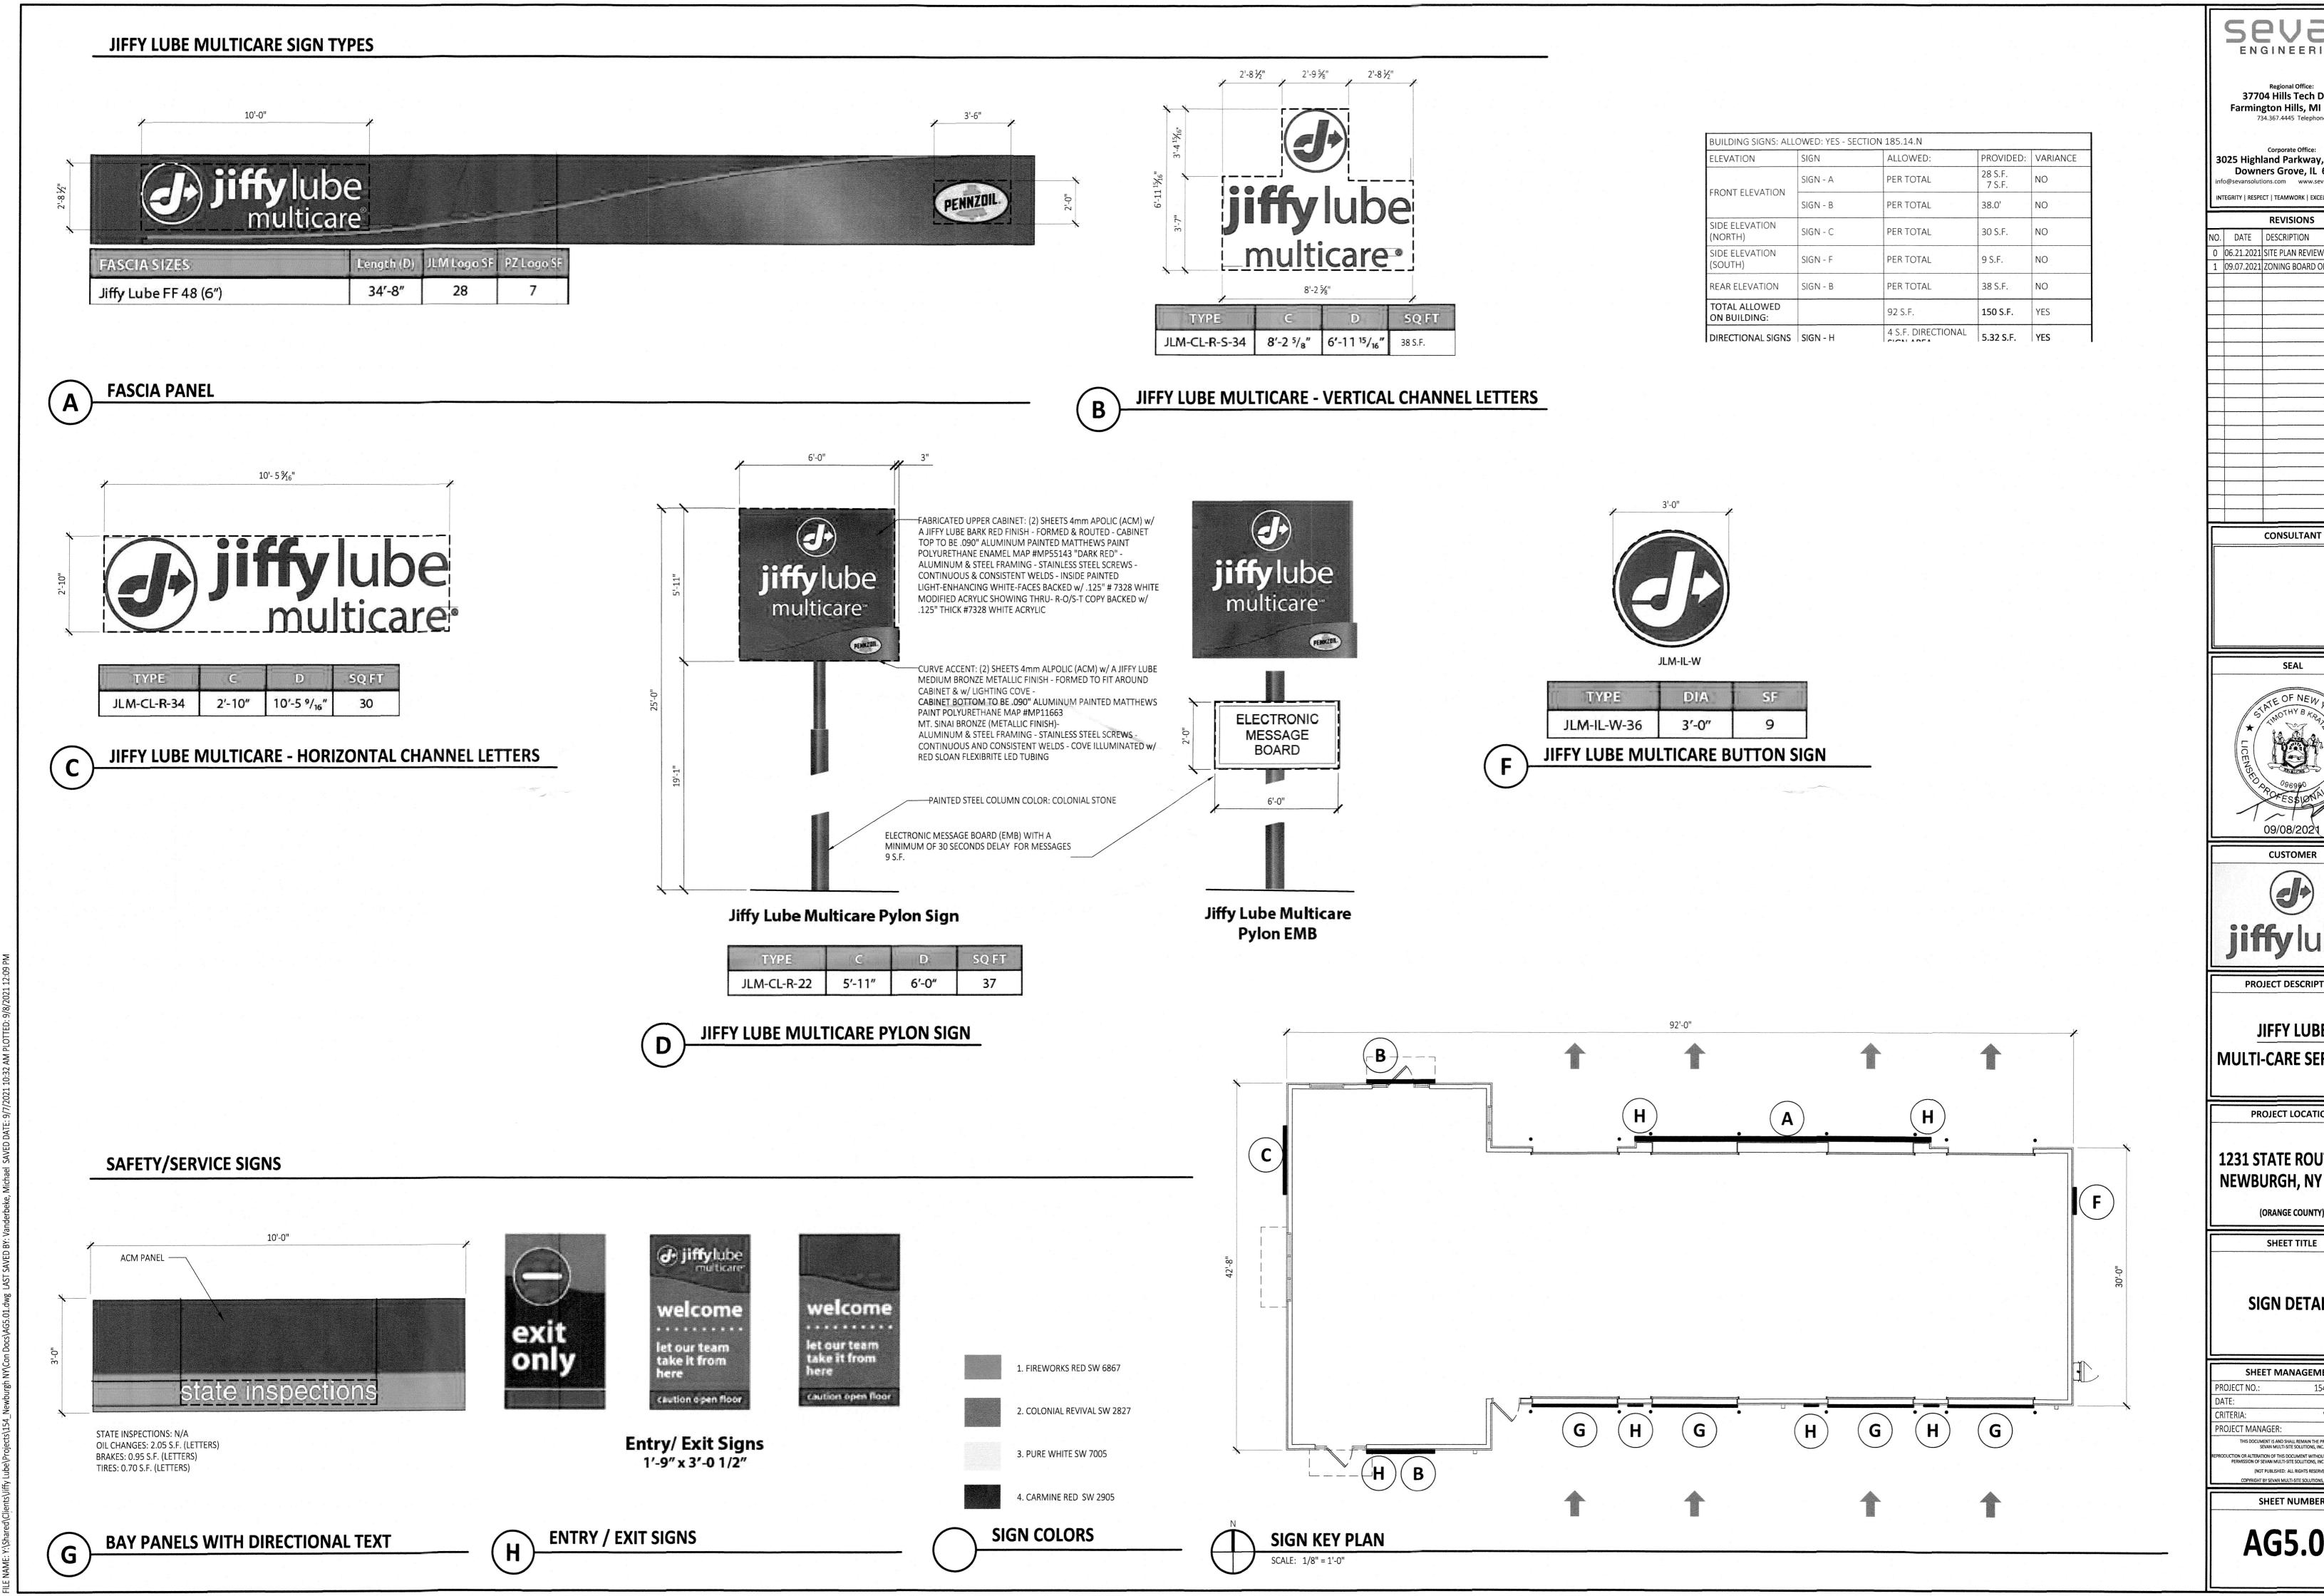

ENGINEERING

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REVISIONS

NO. DATE DESCRIPTION 0 06.21.2021 SITE PLAN REVIEW

1 09.07.2021 ZONING BOARD OF APPEALS

SEAL

09/08/2021

CUSTOMER

PROJECT DESCRIPTION

JIFFY LUBE MULTI-CARE SERVICES

PROJECT LOCATION

1231 STATE ROUTE 300 NEWBURGH, NY 12550

(ORANGE COUNTY)

SIGN DETAILS

SHEET MANAGEMENT

V2020.10-1X4 ROJECT MANAGER:

SHEET NUMBER

AG5.01