

Full Size Site Plans

are available for viewing at the

Zoning Board of Appeals
Office located at
308 Gardnertown Road
Newburgh, NY

845-566-4901

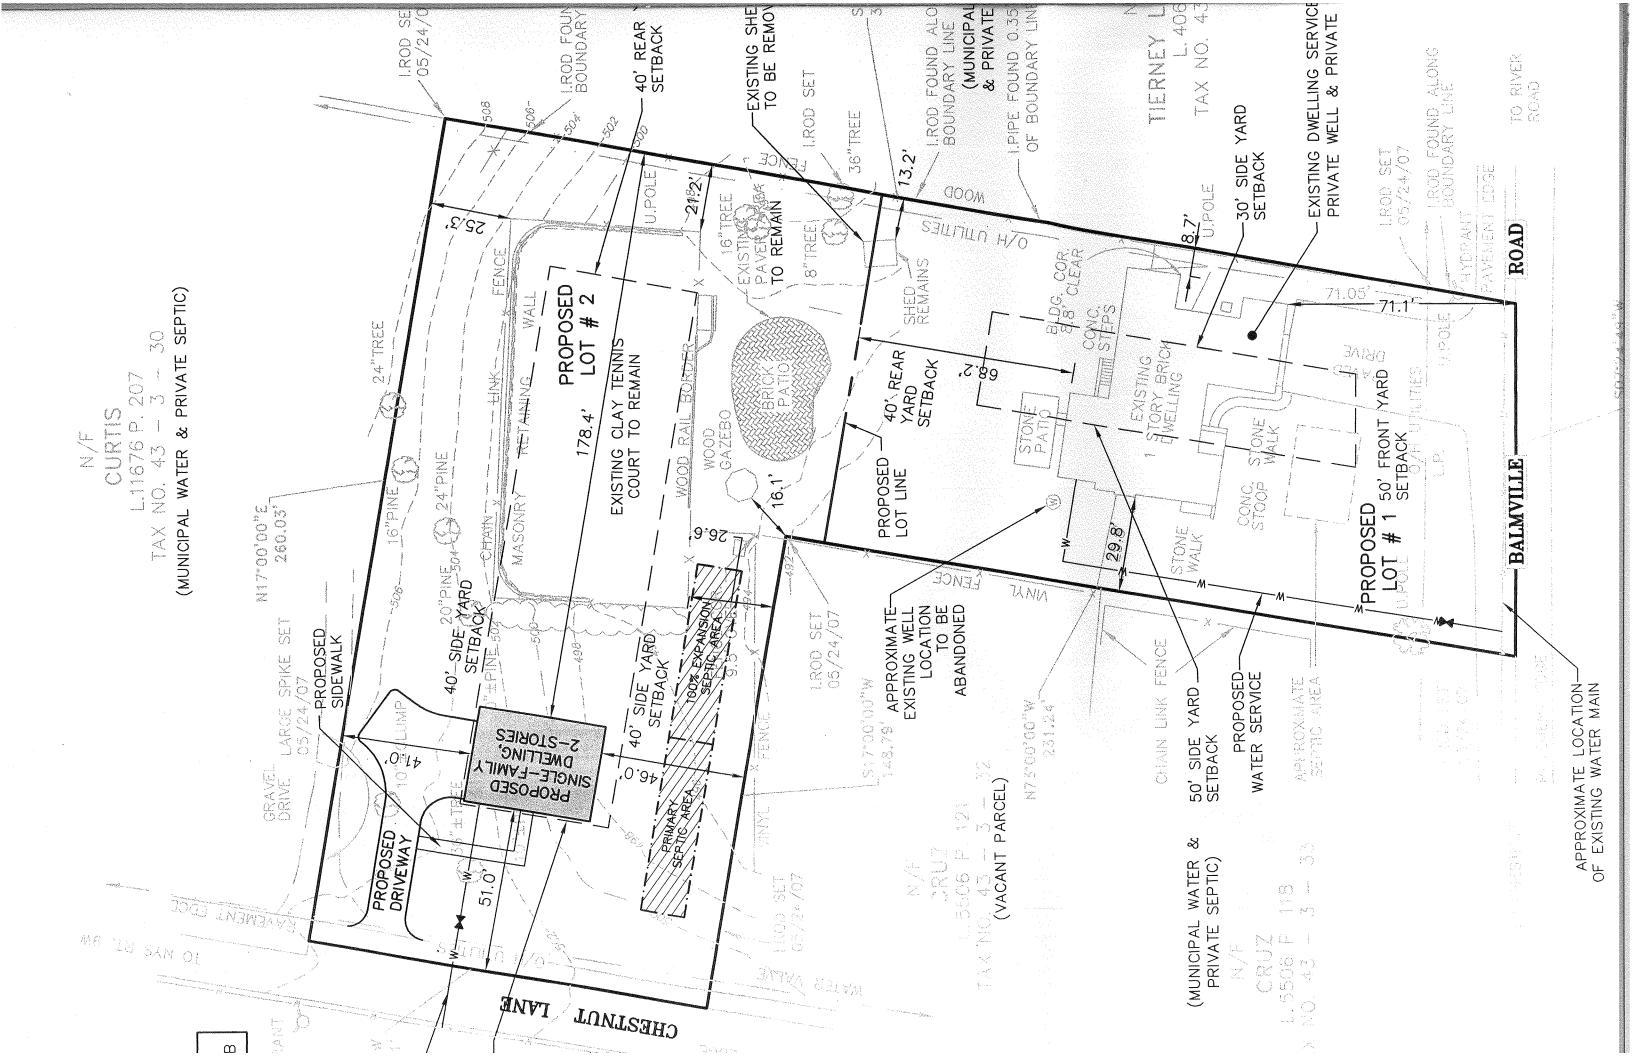

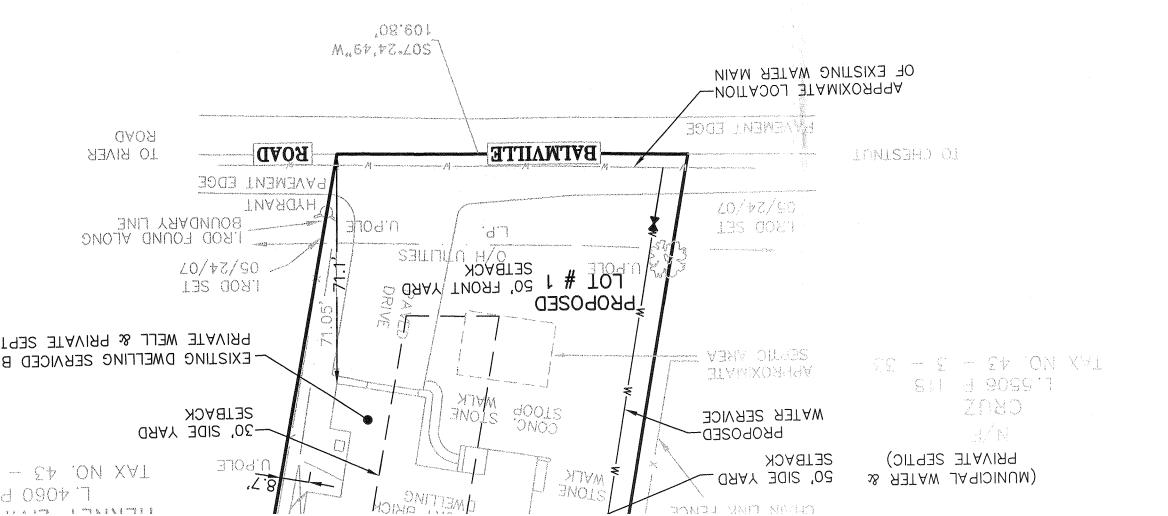

CENERAL NOTES:

- 1. EXISTING UTILITY INFORMATION FOR ADJACENT PARCELS SHOWN HERE ON WAS TAKEN FROM ORANGE COUNTY REAL PROPERTY.
- 2. SEPTIC LOCATION FOR PROPOSED LOT #2 IS APPROXIMATE AND REQUIRES FIELD TESTING AND APPROVAL FROM THE TOWN OF NEWBURGH BUILDING DEPT.
- 3. LOCATIONS OF EXISTING WATER DEPARTMENT.
 THE TOWN OF NEWBURGH WATER DEPARTMENT.

BELEBENCES:

1. EXISTING INFORMATION SHOWN HERE ON WAS TAKËN FROM PLAN ENTITLED "SURVEY PREPARED FOR PETER C. EXISTING INFORMATION SHOWN HERE ON WAS TAKËN FROM PLAN ENTITLED "SURVEY PREPARED FOR PETER C.

OWNER/APPLICANT:

SALLY N. POLHAMUS LIVING TRUST & PETER POLHAMUS
65 BALMVILLE ROAD
NEWBURGH, NY 12550

TAX LOT:

43-3-34.2

SITE AREA:

EXISTING: ±57,199 SQ. FT. ±1.31 ACRES

±22,923.7 SQ. FT. ±0.53 ACRES PROPOSED LOT #2: ±34,275.6 SQ. FT. ±0.78 ACRES


PROPOSED LOT #1:

SITE NOTES:

- 1. FIRE DISTRICT: MIDDLEHOPE
- 2. SCHOOL DISTRICT: NEWBURGH
- 3. THE PROPERTY IS NOT WITHIN ANY ONE-HUNDRED-YEAR FLOOD PLAIN AS PER FLOOD INSURANCE RATE MAP, NO. 36071C0144E.


PLAN LEGEND

EXISTING PROPERTY LINE	
PROPOSED LOT LINE	
SETBACK LINES	
EXISTING FENCE	and the second s
EDGE OF PAVEMENT	and the second s
LIGHT POLE	
UTILITY POLE	ar Section
FIRE HYDRANT	J.

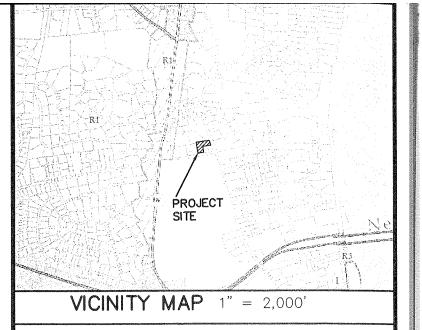



PLAN NORTH

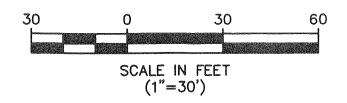

BULK TABLES

ZONE: R-1 RESIDENTIAL DISTRICT

PERMITTED USE: SINGLE FAMILY DWELLINGS, NOT TO EXCEED 1 DWELLING UNIT PER LOT

PERMITTED ACCESSORY USE: TENNIS COURT (PROPOSED LOT #2)


LOT #1

$1 \Omega T H 1$			7.1401/6		-
LOT #1	I REQUIRED	PROVIDED	REMARKS	17,076	42.69%
MINIMUM:		±22,923.7 SQ. FT.	VARIANCE REQ'D -		
	40,000 SQ. FT.	110.3 FT	VARIANCE REQ'D	39.7	26,46 %
LOT AREA	150 FT	219 FT	OK		
LOT WIDTH	150 FT	71.1 FT	OK		
LOT DEPTH	50 FT	68.2 FT	OK		-10
FRONT YARD SETBACK	40 FT	8.7 FT	VARIANCE REQ'D	21,3	71%
REAR YARD SETBACK	30 FT	The state of the s	VARIANCE REQ'D	41.5	51.87%
1 SIDEYARD SETBACK	80 FT	38.5 FT	OK		21,01
BOTH SIDEYARD SETBACK	1,500 SQ. FT.	>1,500 SQ. FT.	UN.	1 ^	
HABITABLE FLOOR AREA PER UNIT	1,300 30. 11.		VARIANCE REQ'D	4.8	And the second s
MAXIMUM:		14.8%	ALTERNATION AND DESCRIPTION AN		
LOT BUILDING COVERAGE	10%	<35'	OK DEG'D	123	
BUILDING HEIGHT	35 FT	32.3%	VARIANCE REQ'D		
LOT SURFACE COVERAGE	20%				

LOT #2

	T PROVIDED	REMARKS
REQUIRED	The state of the s	VARIANCE REQ'D
40,000 SQ. FT.	The state of the s	VARIANCE REQ'D
	CONTRACTOR OF THE PARTY OF THE	OK
THE RESIDENCE OF THE PROPERTY		OK
A CONTRACTOR OF THE PARTY OF TH	A CONTRACTOR OF THE PARTY OF TH	OK
		OK OK
	The state of the s	
The state of the s		OK
		OK
1,500 SQ. FT.	21.2 FT	OK
T) 15 FT FROM ANT LOT LINE		
	3.7%	OK
	<35'	OK
	AND DESCRIPTION OF THE PROPERTY OF THE PROPERT	VARIANCE REQ'D
20%		•
	REQUIRED 40,000 SQ. FT. 150 FT 150 FT 50 FT 40 FT 30 FT 80 FT 1,500 SQ. FT. T) 15 FT FROM ANY LOT LINE 10% 35 FT 20%	40,000 SQ. FT. ±34,275.6 SQ. FT. 150 FT 127.0 FT 150 FT 259.5 FT 51.0 FT 178.4 FT 40 FT 41.0 FT 30 FT 87.0 FT 80 FT >1,500 SQ. FT. 15 FT FROM ANY LOT LINE 21.2 FT 10% 3.7% 35 FT 34%

REVISED FOR ZBA SUBMISSION 1 8/8/15 DESCRIPTION REV. DATE DRAWN BY

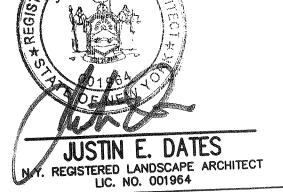



Consulting, Municipal & Environmental Engineers
Planners Surveyors Landscape Architects
State of N.Y. Certificate of Authorization: 0000172

New Jersey New York Pennsylvania Virginia
Customer Loyalty through Client Satisfaction

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NEWBURGH OFFICE 1607 Route 300 Suite 101 Newburgh, NY 12550 Phone: 845.564.4995 Fax: 845.564.0278 email: solutions @ maserconsulting.com

SKETCH

SKETCH SUBDIVISION PLAN

FOR

PETER POLHAMUS

TAX LOT 43-3-34.2

TOWN OF	NEWBURGH,	ORANGE CO	DUNTY, N.Y.
CALE:	DATE:	DRAWN BY:	CHECKED BY:
1"=30'	11/10/14	JUS	JED

PROJECT NUMBER:

14,31

15,333

5724.4

23

14%


13001929A

NB001407

SHEET NUMBER:

of

Y LIVING 4060 P. 21 43 - 3 372,30,00 (MUNICIPAL WATER & PRIVATE SEPTIC) EXISTING SHED TO BE REMOVED TAX NO. 506-36"TREE UPOLE EDGE OOOM U.POLE PAVER TO REMAIN SAITLITU HIS HYDRANT ROAD 12年10 FENCE BLOG COR. 8.8 CLEAR SENERAL SENERA PROPOSED LOT # 2 71.05 COSSO STATES # 24"TREE \bigcirc CLAY TENNIS TO REMAIN U.POL EXISTING STORY BRICK DWELLING WOOD RAIL BORDER & PRIVATE JAINE L.11676 P. 207 NO. 43 - 3 -直逐 DAVED RETAINING SUE I MOSD SAZEBO 5 (MUNICIPAL WATER EXISTING ANG. TO J () BALMVILLE 000NC 077000: 7.00.00° × 1.00° × 1.00° × TAX PROPOSED 010 1154 1154 # 20"PINE WIN BOX 100% EXPANSION SEPTIC AREA OR APPROXIMATE—EXISTING WELL LOCATION TO BE ABANDONED -6-WAY DIST. B (SEE DETAILS) ul Zi M V M DECK PROPOSED WATER SERVICE SEPTIC AREA S-SLOBIES
DMETFING
SINGTE-LYMIT
BROBOSED 200,00% 21.3 PROPOSED IN—GROUND SABSORPTION AREA 3 LATERALS © 53' 159 LF PROVIDED (SEE DETAIL SHEET) Z Z Z J 10.0 8 15.7 (VACANT PARCEL) PROPOSED DRIVEWAY ઐ PROPOSED -1,000 GAL. SEPTIC TANK WATER SEPTIC) NICIPAL RIVATE S A SYN OF

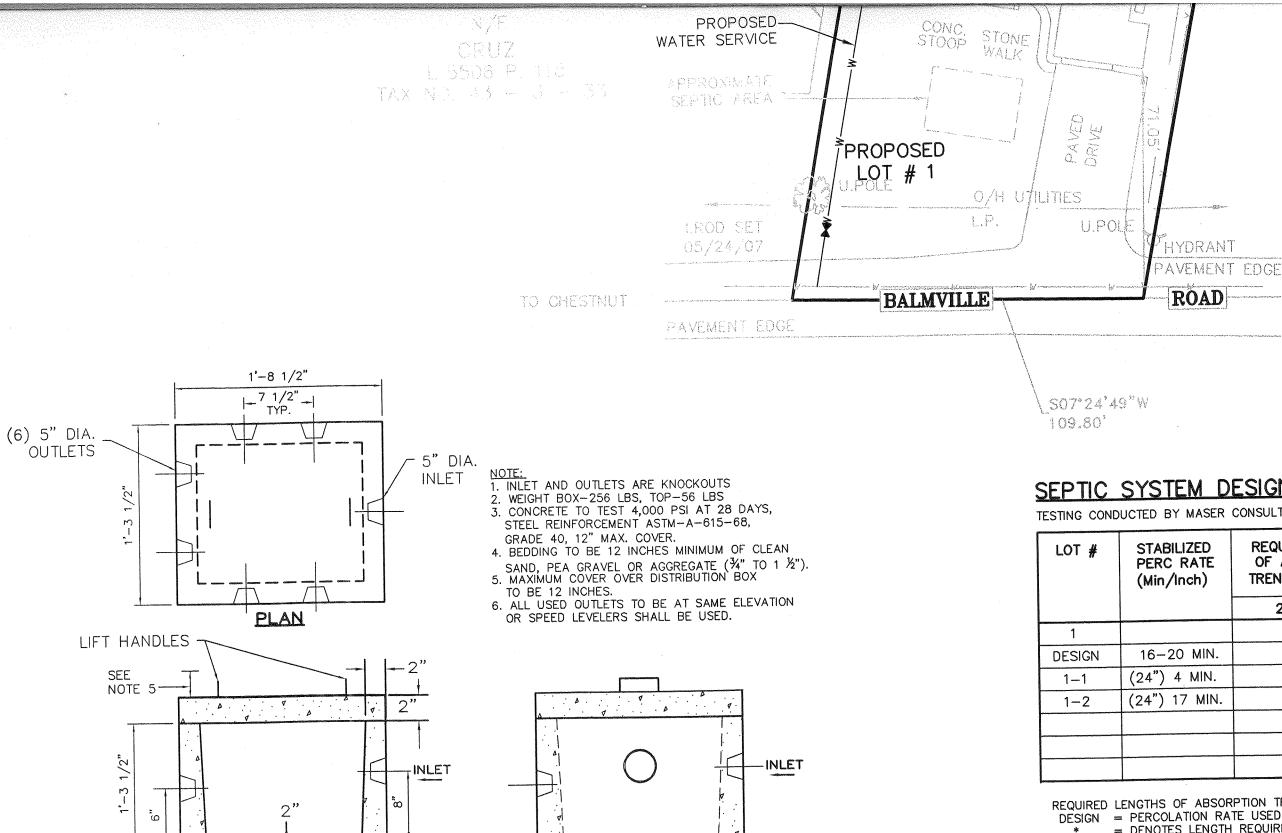

ELEVATION

6 WAY DISTRIBUTION BOX DETAIL

SEE

NOTE 4

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SECTION

N.T.S

SEPTIC SYSTEM DESIGN TABLE

TESTING CONDUCTED BY MASER CONSULTING ON 04/24/15

LOT #	STABILIZED PERC RATE (Min/Inch)	REQUIRED LENGTH OF ABSORPTION TRENCH (PRIMARY)	DEEP TEST INFORMATION (HOLE 1)	DE INF (
		2 BEDROOM		
1			1-1	
DESIGN	16-20 MIN.	158*	0-6" TOPSOIL 6-15" DARK LOAMY	0-6" T 6-18" D
1-1	(24") 4 MIN.		SAND W/ COBBLES THROUGHOUT	Ť
1-2	(24") 17 MIN.		15-72" BROWN LOAMY SAND W/ COBBLES	18-72" S L
			NO MOTTLING NO GROUNDWATER NO BEDROCK	NO MOTT NO WATE NO BEDE

TO RIVER

ROAD

REQUIRED LENGTHS OF ABSORPTION TRENCH SHOWN ON PLAN BASED ON DESIGN PERCOLATION

* PERCOLATION RATE USED FOR DESIGN

* DENOTES LENGTH REQUIRED FOR CONVENTIONAL ABSORPTION SYSTEM


TEST IATION E 2)	TYPE OF SEPTIC SYSTEM (PRIMARY)	TYPE OF SEPTIC SYSTEM (100% RESERVE)
2		
ANDY LOAM LL COBBLES HOUT CLAY COBBLES	IN GROUND SYSTEM	IN GROUND SYSTEM

SET TO NOTES:

- THE DESIGN AND LOCATION OF SANITARY FACILITIES (WATER AND SEWER SYSTEMS) SHALL
- TRENCHES SHALL NOT BE INSTALLED IN WET SOIL. THE SIDES AND BOTTOM OF TRENCHES MUST BE RAKED. THE ENDS OF THE LATERALS MUST BE CAPPED.
- THERE SHALL BE NO REGRADING, EXCEPT AS SHOWN ON THE APPROVED PLANS, IN THE
- HEAVY EQUIPMENT SHALL BE KEPT OFF THE AREA OF THE ABSORPTION FIELDS EXCEPT DURING THE ACTUAL CONSTRUCTION. THERE SHALL BE NO UNNECESSARY MOVEMENT OF CONSTRUCTION EQUIPMENT IN THE ABSORPTION FIELD AREA BEFORE, DURING, OR AFTER CONSTRUCTION. EXTREME CARE MUST BE TAKEN DURING ACTUAL CONSTRUCTION SO AS TO AVOID ANY UNDUE COMPACTION THAT COULD RESULT IN A RESULT IN A CHANGE OF THE ABSORPTION CAPACITY OF THE SOIL ON WHICH THE DESIGN WAS BASED.
- NO SWIMMING POOLS, DRIVEWAYS, OR STRUCTURES THAT MAY COMPACT THE SOIL SHALL
- THIS SYSTEM WAS NOT DESIGNED TO ACCOMMODATE GARBAGE GRINDERS, JACUZZI TYPE SPA TUBS OVER 100 GALLONS, OR WATER CONDITIONERS. AS SUCH THESE ITEMS SHALL NOT BE INSTALLED UNLESS THE SYSTEM IS REDESIGNED TO ACCOUNT FOR THEM AND RE-APPROVED BY THE ORANGE COUNTY HEALTH DEPARTMENT.
- THERE MUST BE AN UNINTERRUPTED POSITIVE SLOPE FROM THE SEPTIC TANK AND PUMPING CHAMBER TO THE BUILDING, ALLOWING SEPTIC GASES TO DISCHARGE THROUGH
- THE OWNER/APPLICANT SHALL BE PROVIDED WITH A COPY OF THE APPROVED PLANS AND AN ACCURATE AS-BUILT DRAWING OF ANY EXISTING SANITARY FACILITIES. THE OWNER/APPLICANT SHALL ALSO BE ADVISED OF ANY ROUTINE OR SPECIAL MAINTENANCE PROCEDURES THAT MAY BE NECESSARY
 - A. SEPTIC TANKS SHOULD BE INSPECTED PERIODICALLY AND PUMPED EVERY 2-3 YEARS.
 - B. PUMP CHAMBERS SHOULD BE INSPECTED PERIODICALLY BY A PROPERLY TRAINED PERSON FOR PROPER OPERATION, INCLUDING HIGH WATER ALARMS, VENTING AND ANY
 - C. DISTRIBUTION BOXES SHOULD BE INSPECTED PERIODICALLY TO ASSURE THAT THEY
- INDIVIDUAL WELLS AND SEWAGE DISPOSAL SYSTEMS SHALL NO LONGER BE CONSTRUCTED OR USED WHEN PUBLIC FACILITIES BECOME AVAILABLE. CONNECTION TO THE PUBLIC SEWER SYSTEM IS REQUIRED WITHIN 1 YEAR OF AVAILABILITY.
- 10. A NEW YORK STATE LICENSED PROFESSIONAL ENGINEER SHALL INSPECT THE SANITARY FACILITIES AT THE TIME OF CONSTRUCTION. THE ENGINEER SHALL CERTIFY TO THE ORANGE COUNTY DEPARTMENT OF HEALTH AND THE LOCAL CODE ENFORCEMENT OFFICER THAT THE FACILITIES HAVE BEEN INSTALLED IN ACCORDANCE WITH THE APPROVED PLANS AND THAT ANY SEPTIC TANK JOINTS HAVE BEEN SEALED AND TESTED FOR WATER

UNAUTHORIZED ALTERATION TO A MAP BEARING A UCENSED PROFESSIONAL ENGINEER'S SEAL IS A MOLATION OF SECTION 7209, SUB-DIVISION 2, OF THE NEW YORK STATE EDUCATION LAW. THE THE NEW YORK STATE EDUCATION LAW. THE CERTIFICATION IS NOT AN EXPRESS OR IMPLIED STATEMENT OF GUARANTEE, IT IS PURELY A KNOWLEDGE, INFORMATION AND BELIEF, BASED ON EXISTING FIELD EMDENCE AND DOCUMENTARY EMDENCE AVAILABLE. CERTIFICATIONS ARE NOT TRANSFERABLE TO ADDITIONAL INSTITUTIONS OR SUBSEQUENT OWNERS.

DESCRIPTION

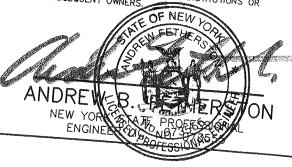



Consulting, Municipal & Environmental Engineers Planners Surveyors Landscape Architects State of N.Y. Certificate of Authorization: 0000172

New Jersey New York Pennsylvania Virginia Customer Loyalty through Client Satisfaction

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NEWBURGH OFFICE

1607 Route 300 Suite 101 Newburgh, NY 12550 Phone: 845.564.4995 Fax: 845.564.0278 email: solutions @ maserconsulting.com

SKETCH

SKETCH SUBDIVISION PLAN FOR

PETER POLHAMUS TAX LOT 43-3-34.2

TOWN OF NEWBURGH, ORANGE COUNTY, N.Y. DRAWN BY:

SCALE: 1"=30" CHECKED BY: 11/10/14 PROJECT NUMBER: JED


13001929A SHEET NUMBER:

2

NB001407

2

of

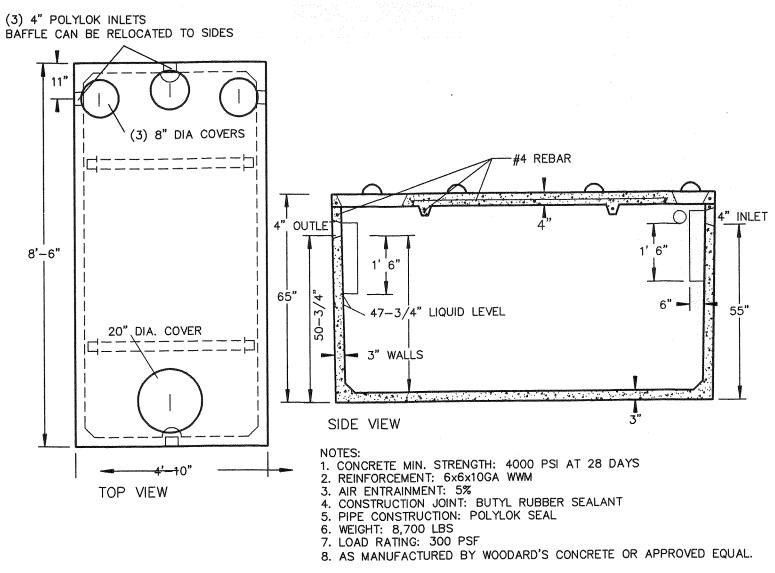

1.000 GALLON PRECAST SEPTIC TANK DETAIL

N.T.S

