
Full Size Site Plans

are available for viewing at the

Zoning Board of Appeals
Office located at
308 Gardnertown Road
Newburgh, NY

845-566-4901

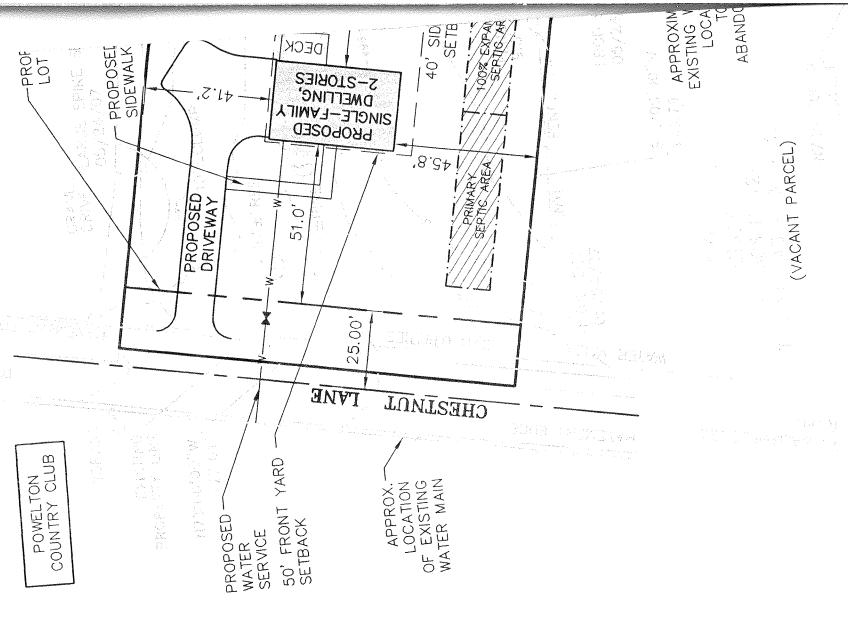

(MUNICIPAL WATER & PRIVATE SEPTIC)

PROPOSED-WATER SERVICE 50' SIDE YARD — SETBACK

PROPOSED -

APPROXIMATE LOCATION-OF EXISTING WATER MAIN

BULK TABLES

ZONE: R-1 RESIDENTIAL DISTRICT

PERMITTED USE: SINGLE FAMILY DWELLINGS, NOT TO EXCEED 1 DWELLING UNIT PER LOT

PERMITTED ACCESSORY USE: TENNIS COURT (PROPOSED LOT #2)

LOT #1

LOT #1	DECLUCE	PROVIDED	REMARKS
AINIMUM:	REQUIRED	±20,174.9 SQ. FT.	VARIANCE REQ'D
OT AREA	40,000 SQ. FT.	108.8 FT	VARIANCE REQ'D
	150 FT	184.2 FT	OK
OT WIDTH	150 FT	46.0 FT	VARIANCE REQ'D
OT DEPTH	50 FT	68.2 FT	OK
RONT YARD SETBACK	40 FT	8.7 FT	VARIANCE REQ'D
REAR YARD SETBACK	30 FT	38.5 FT	VARIANCE REQ'D
SIDEYARD SETBACK	80 FT		OK
BOTH SIDEYARD SETBACK	1,500 SQ. FT.	>1,500 SQ. FT.	UN
HABITABLE FLOOR AREA PER UNIT			VARIANCE REQ'D
MAXIMUM:	10%	16.8%	OK OK
LOT BUILDING COVERAGE	35 FT	<35'	
BUILDING HEIGHT		28%	VARIANCE REQ'D
LOT SURFACE COVERAGE	20%		

LOT #2

OT #2	PROVIDED REMAR		
IINIMUM:	REQUIRED	±31,811.1 SQ. FT.	VARIANCE REQ'D
	40,000 SQ. FT.		VARIANCE REQ'D
OT AREA	150 FT	127.0 FT	OK
OT WIDTH	150 FT	240.1 FT	OK
OT DEPTH	50 FT	51.0 FT	OK
RONT YARD SETBACK	40 FT	164.1 FT	OK OK
EAR YARD SETBACK	30 FT	41.2 FT	CONTROL OF THE PROPERTY OF THE
SIDEYARD SETBACK	80 FT	87.0 FT	OK
OTH SIDEYARD SETBACK	1,500 SQ. FT.	>1,500 SQ. FT.	OK
ABITABLE FLOOR AREA PER UNIT	DT) 15 ET FROM ANY LOT LINE	21.2 FT	OK
ABITABLE FLOOR AREA FER SIMI CCESSORY USE SETBACK (TENNIS COUI	RIJIS FI IKOM ARTES.	The second secon	
IAXIMUM:	A COTA	3.1%	OK
OT BUILDING COVERAGE	10%	<35'	OK
BUILDING HEIGHT	35 FT	32%	VARIANCE REQ'D
OT SURFACE COVERAGE	20%	Company of the Control of the Contro	

	The same of the sa		
			REVISED PER COMMENT FROM THE ZBA
2	8/10/15	JAP	
4	8/8/15	JAP	REVISED FOR ZBA SUBMISSION
1	0/0/13	U/V	DESCRIPTION
æν.	DATE	DRAWN BY	COOM!



N.Y. REGISTERED LANDSCAPE ARCHITECT LIC. NO. 001964



Consulting, Municipal & Environmental Engineers Planners Surveyors Landscape Architects State of N.Y. Certificate of Authorization: 0000172

New Jersey New York Pennsylvania Virginia
Customer Loyalty through Client Satisfaction

COPYRIGHT @2012, MASER CONSULTING P.A ALL RIGHTS RESERVED

THIS DRAWING AND ALL THE INFORMATION CONTAINED HEREIN IS AUTHORIZED FOUSE ONLY BY THE PARTY FOR WHOM THE WORK WAS CONTRACTED OR TO WHOM IT IS CERTIFIED. THIS DRAWING MAY NOT BE COPIED, REUSED, DISCLOSED DISTRIBUTED OR RELIED UPON FOR ANY OTHER PURPOSE WITHOUT THE EXPRESS WRITTEN CONSENT OF MASER CONSULTING, P.A.

NEWBURGH OFFICE 1607 Route 300 Suite 101 Newburgh, NY 12550 Phone: 845.564.4995 Fax: 845.564.0278

email: solutions @ maserconsulting.com

SKETCH

SKETCH SUBDIVISION PLAN

PETER POLHAMUS

TAX LOT 43-3-34.2

TOWN OF	NEWBURGH,	ORANGE CO	OUNTY, N.Y.
ACCRECATE THE PROPERTY OF THE		DRAWN BY:	CHECKED BY:
scale: 1"=30'	11/10/14	JJS	JED

PROJECT NUMBER:


13001929A


NB00140


SHEET NUMBER:


of

N/F CURTIS L.11676 P. 207 TAX NO. 43 - 3 - 30 (MUNICIPAL WATER & PRIVATE SEPTIC)

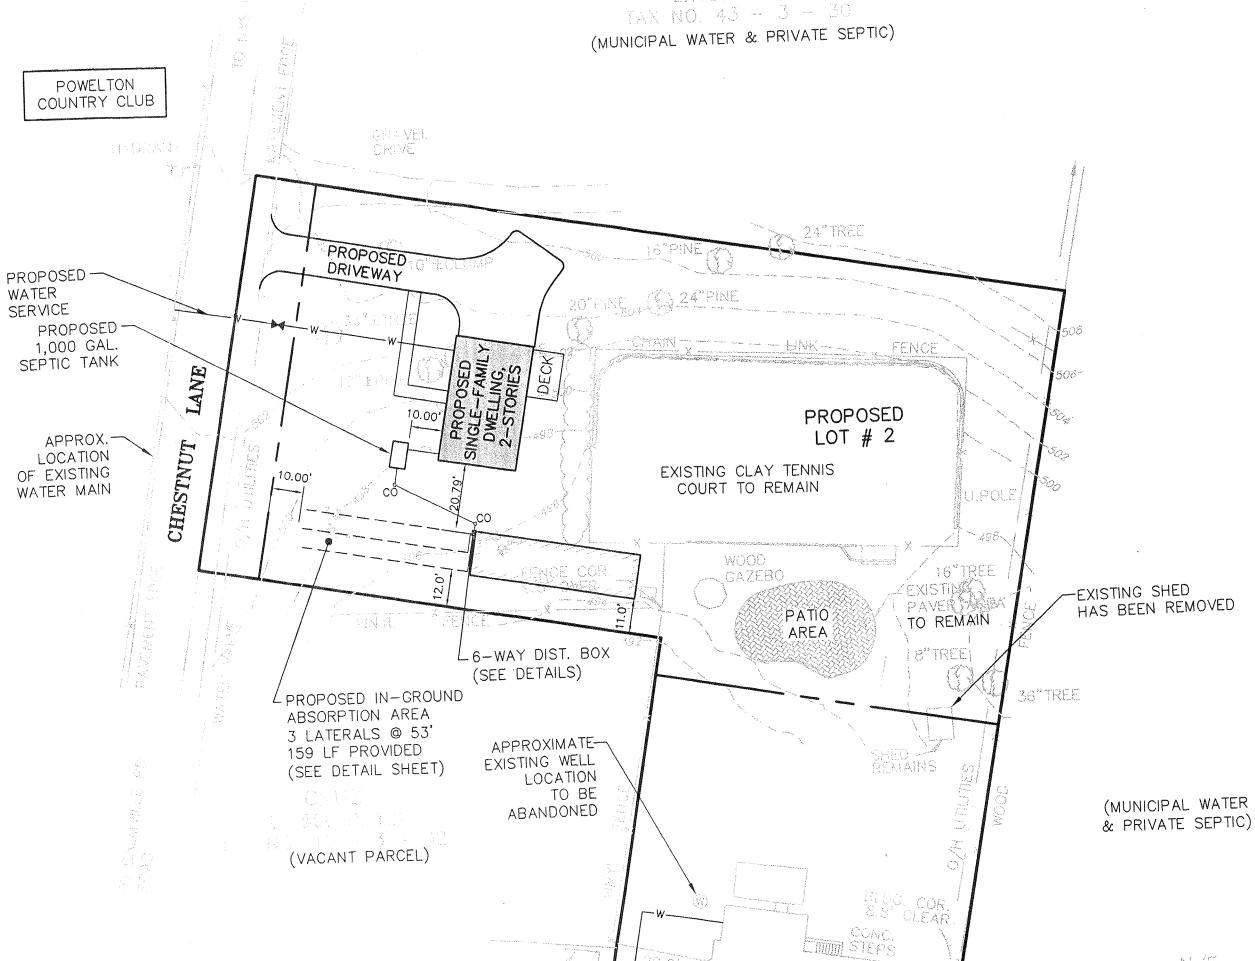

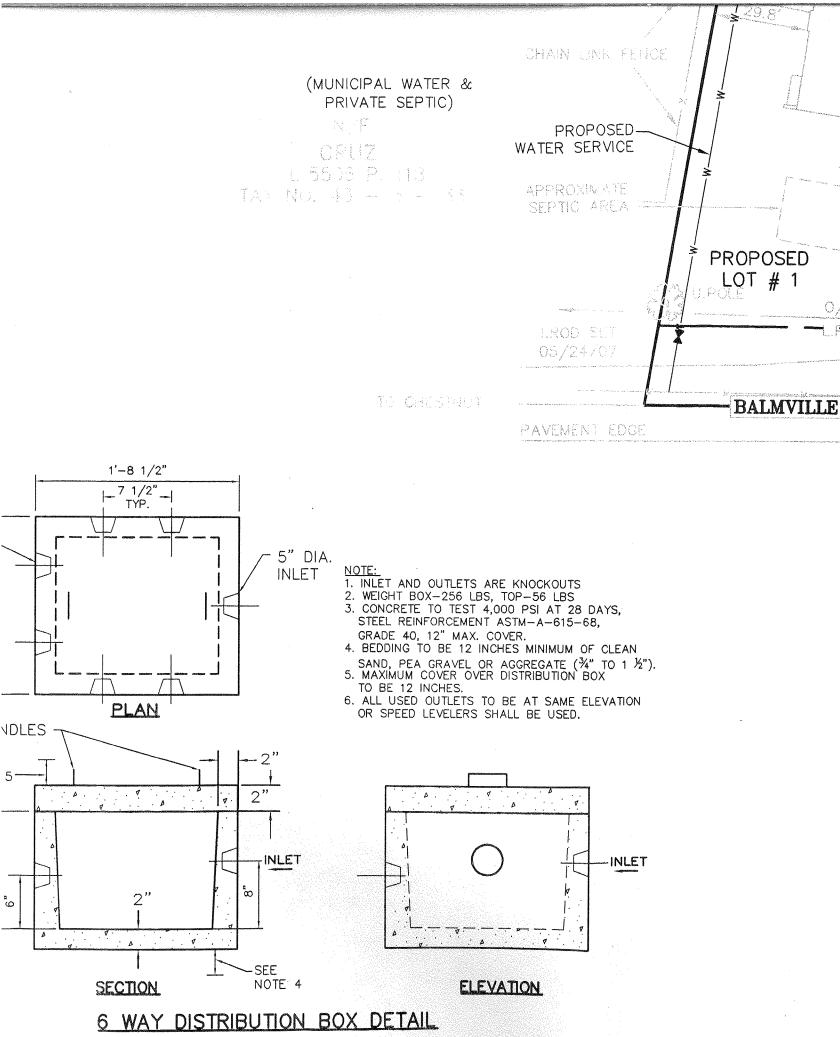

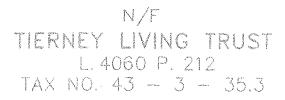

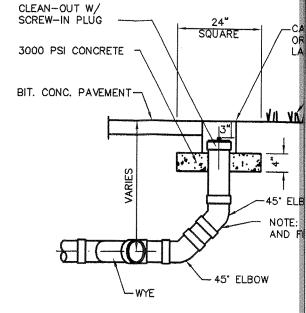

SANITARY SEWER CLEANO

N.T.S.

SEPTIC SYSTEM DESIGN TABLE

HYDRANT

ROAD

PAVEMENT EDGE

U.POLE

MILL STEPS

EXISTING 1 STORY BRICK DWELLING

O/H UTILITIES

TESTING CONDUCTED BY MASER CONSULTING ON 04/24/15

LOT #	STABILIZED PERC RATE (Min/Inch)	REQUIRED LENGTH OF ABSORPTION TRENCH (PRIMARY) 2 BEDROOM	DEEP TEST INFORMATION (HOLE 1)	DEEP TEST INFORMATION (HOLE 2)	TYPE OF SEPTIC SYSTEM (PRIMARY)
1			1-1	1-2	
DESIGN	16-20 MIN.	158*	0-6" TOPSOIL 6-15" DARK LOAMY	0-6" TOPSOIL 6-18" DARK SANDY LOAM	IN GROUND
1-1	(24") 4 MIN.		SAND W/ COBBLES	W/ SMALL COBBLES	
1-2	(24") 17 MIN.		THROUGHOUT 15-72" BROWN LOAMY	THROUGHOUT 18-72" SANDY CLAY	
-			SAND W/ COBBLES	LOAM W/ COBBLES	
	**************************************		NO MOTTLING	NO MOTTLING	
			NO GROUNDWATER NO BEDROCK	NO WATER NO BEDROCK	

REQUIRED LENGTHS OF ABSORPTION TRENCH SHOWN ON PLAN BASED ON DESIGN PERCOLATION RATE

TO RIVER ROAD

DESIGN = PERCOLATION RATE USED FOR DESIGN

* = DENOTES LENGTH REQUIRED FOR CONVENTIONAL ABSORPTION SYSTEM