



Carter H. Strickland, Jr.
Commissioner

Sean McAndrew, P.E.
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Mr. John P. Ewasutyn, Chairman
Town of Newburgh Planning Board
308 Gardner Town Road
Newburgh, New York 12550

FEB 10 2014

Re: New York City Department of Environmental Protection
Delaware Aqueduct Rondout-West Branch Tunnel Repair Program
West Connection Site/Shaft 5B
Dewatering Force Main Extension Site Plan Approval Modification Request
Town Project Number 2013-5¹

Dear Mr. Ewasutyn:

Please see the enclosed project description and drawing package for the proposed 20-inch diameter dewatering force main extension for the Delaware Aqueduct Rondout-West Branch Tunnel Repair Program West Connection Site/Shaft 5B. The force main is needed to carry treated process water and infiltrated groundwater encountered during tunnel construction to the Hudson River given the limited capacity of the onsite stream to accommodate large flows. The force main will be abandoned in place at the end of the program.


This concept was first introduced to the Planning Board during the initial site plan approval process and development of the Environmental Impact Statement (EIS), and the first leg of the force main, which will extend along 9W from the 5B site to the intersection of 9W and Old Post Road, was included in the approved site plans. A detailed design for the remainder of the force main from 9W to the Hudson via Old Post Road and River Road was not initially available. The full length of the force main has now been designed, and DEP would like to request a modification of the existing site plan approval to include it.

This submission is intended to introduce DEP's near-final design for the force main extension and initiate work with the Planning Board and Town staff so that a complete application for site plan modification can be submitted in the summer of 2014.

Please see the enclosed materials, including a brief project description and design drawings, for more information. DEP looks forward to the February 20, 2014 Planning Board meeting and is prepared to present the design and discuss the site plan approval modification request.

Should you have any questions or require additional information in the meantime, please do not hesitate to contact me or my staff.

Sincerely,

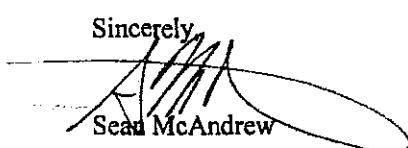

Sean McAndrew

cc. Michael Donnelly, Town of Newburgh Planning Board Attorney (w/ attachments)
Patrick Hines, Town of Newburgh Planning Board Engineer (w/ attachments)
Gerald Canfield, Town of Newburgh Code Compliance Officer (w/ attachments)
Dan Michaud, DEP BWS (w/o attachments)
Ted Dowey, DEP BEDC (w/o attachments)
Phil Simmons, DEP BEDC (w/o attachments)
Chris Villari, DEP BEDC (w/o attachments)

¹ The pre-application project number was 2011-15. The post-approval project number is 2013-5.

Project Description
New York City Department of Environmental Protection
Delaware Aqueduct Rondout-West Branch Tunnel Repair Program
West Connection Site/Shaft 5B
Town Project Number 2013-5¹

Dewatering Force Main Extension
Site Plan Approval Modification Request
February 6, 2014

Introduction

To support the construction of the Rondout-West Branch Tunnel (RWBT) bypass, DEP has proposed the installation of a 20-inch diameter dewatering force main to carry treated process water and infiltrated groundwater encountered during tunnel construction to the Hudson River. This concept was first introduced to the Planning Board during the initial site plan approval process and development of the Environmental Impact Statement (EIS). In fact, the first leg of the force main, which extends along 9W from the 5B site to the intersection of 9W and Old Post Road, is included in the approved site plans. A detailed design for the remainder of the force main from 9W to the Hudson, however, was not initially available. The full length of the force main has now been designed, and DEP would like to request a modification of the existing site plan approval to include this extension (See Figure 1).

The force main is intended for use during tunnel construction and will be abandoned in place, filled, and grouted upon project completion. The outfall and rip rap apron on the bank of the Hudson River inlet would also be removed, and the bank will be restored to its original condition.

Construction of the force main is expected to occur in the spring and summer of 2015 in preparation for the subsequent tunnel construction.

For a description of the larger Delaware Aqueduct Rondout-West Branch Tunnel Repair Program, see "Background" below.

Force Main Need

During construction of the shaft and bypass tunnel, groundwater is expected to infiltrate. At present, a treatment system has been installed to manage up to one million gallons per day (mgd) of water from the shaft construction. This minor volume of water is being discharged, post-treatment, to the onsite stream.

¹ The pre-application project number was 2011-15. The post-approval project number is 2013-5.

During tunnel construction, the infiltrated groundwater is expected to be on the order of 10 mgd, and the onsite stream is unable to accommodate such a large volume. Therefore, the treatment systems will be upgraded accordingly, and a force main will be needed to carry the water to the Hudson River which can accommodate the flow.

Background²

The Delaware Aqueduct is critical to the nine million people who rely on the New York City water supply, including New York City and upstate residents. Repairing the Rondout-West Branch portion of the Delaware Aqueduct is required in order to maintain this critical piece of the City's water supply infrastructure. DEP is responsible for ensuring the safe and reliable transmission of drinking water from the watershed to consumers in sufficient quantity to meet all present and future water demands. The RWBT is a critical component of DEP's Delaware water supply system, which provides fifty percent of the City's supply, and is currently leaking, in total, between 10 and 35 million gallons per day in two critical areas in the vicinity of the Wawarsing and Roseton crossings.

Shutting down the Delaware Aqueduct during the bypass tunnel connection and repair of the leak in Wawarsing may require DEP to supplement its water sources, manage demand and make provisions for changes in the distribution system during the shutdown period.

Once ready with all of the necessary provisions for reliable drinking water during the shutdown, DEP will undertake the bypass tunnel connection to the existing Delaware Aqueduct. During the connection period, certain inspection and repairs from within the RWBT will be made to the remainder of the existing tunnel in areas outside the bypassed section, particularly those sections located in the Town of Wawarsing, which need repair.

Construction of the bypass tunnel and shaft sites began with construction of the shafts, which started in 2013 and will be complete in 2015. Construction of the bypass tunnel will begin in 2015 and be connected in 2020. It is anticipated that up to 15 months would be needed to complete the bypass connection and to undertake the inspection and repair of the RWBT, expected to occur sometime in 2021.

Force Main Route

As can be seen in the design drawings and Figure 1, the newly designed portion of force main extends along the southern edge of Old Post Road adjacent to Cedar Hill Cemetery from 9W to the intersection with River Road. It then extends down River Road to Tax Lot No 9-1-18.1, a

² Resolution of Approval: Site Plan for New York City Department of Environmental Protection [Delaware Aqueduct Rondout-West Branch Tunnel Repair Program] Project # 2011-15, certified July 9, 2012. (Note: The pre-application project number was 2011-15. The post-approval project number is 2013-5.)

narrow parcel owned by CCI Roseton LLC (formerly owned by Dynegy) that stretches through the northeastern corner of the cemetery. From the cemetery, the force main would continue through the CCI Roseton property to the west of River Road (Tax Lot No. 9-1-25.1), crossing River Road onto the eastern portion of that same CCI Roseton parcel. The force main would then run to the east of and roughly parallel to River Road, crossing into an adjacent parcel to the south also owned by CCI Roseton (Tax Lot No. 9-1-29). The force main would eventually curve to the east and then south to the Hudson River inlet on the southern border of that property.³

Zoning

The force main route is located largely in the “AR, Agricultural” and “I, Industrial” zones which encompass Cedar Hill Cemetery and CCI Roseton. However, the initial portion along Old Post Road is located in a “B, Business” zone with a “LHI, Light and Heavy Equipment and Recreational Vehicle Sales, Service, and Repair” overlay.⁴

Forthcoming Information

DEP will work with the Planning Board to provide additional information required to modify the existing Shaft 5B site plan approval. For instance, erosion and sediment control plans, traffic control plans, and additional tree survey information, among other items as listed in the “Town of Newburgh Planning Board Application Package for Subdivisions, Site Plans, Lot Line Changes, and Special Exception Use Permits Procedures and Requirements” will be provided, as appropriate and required by the Planning Board.

³ Town of Newburgh Tax Year 2013, Tax Map 334600, Orange County Tax Map Department, New York

⁴ Town of Newburgh, Orange County, New York, Official Zoning Map, Orange County Planning Department, October 22, 2012.

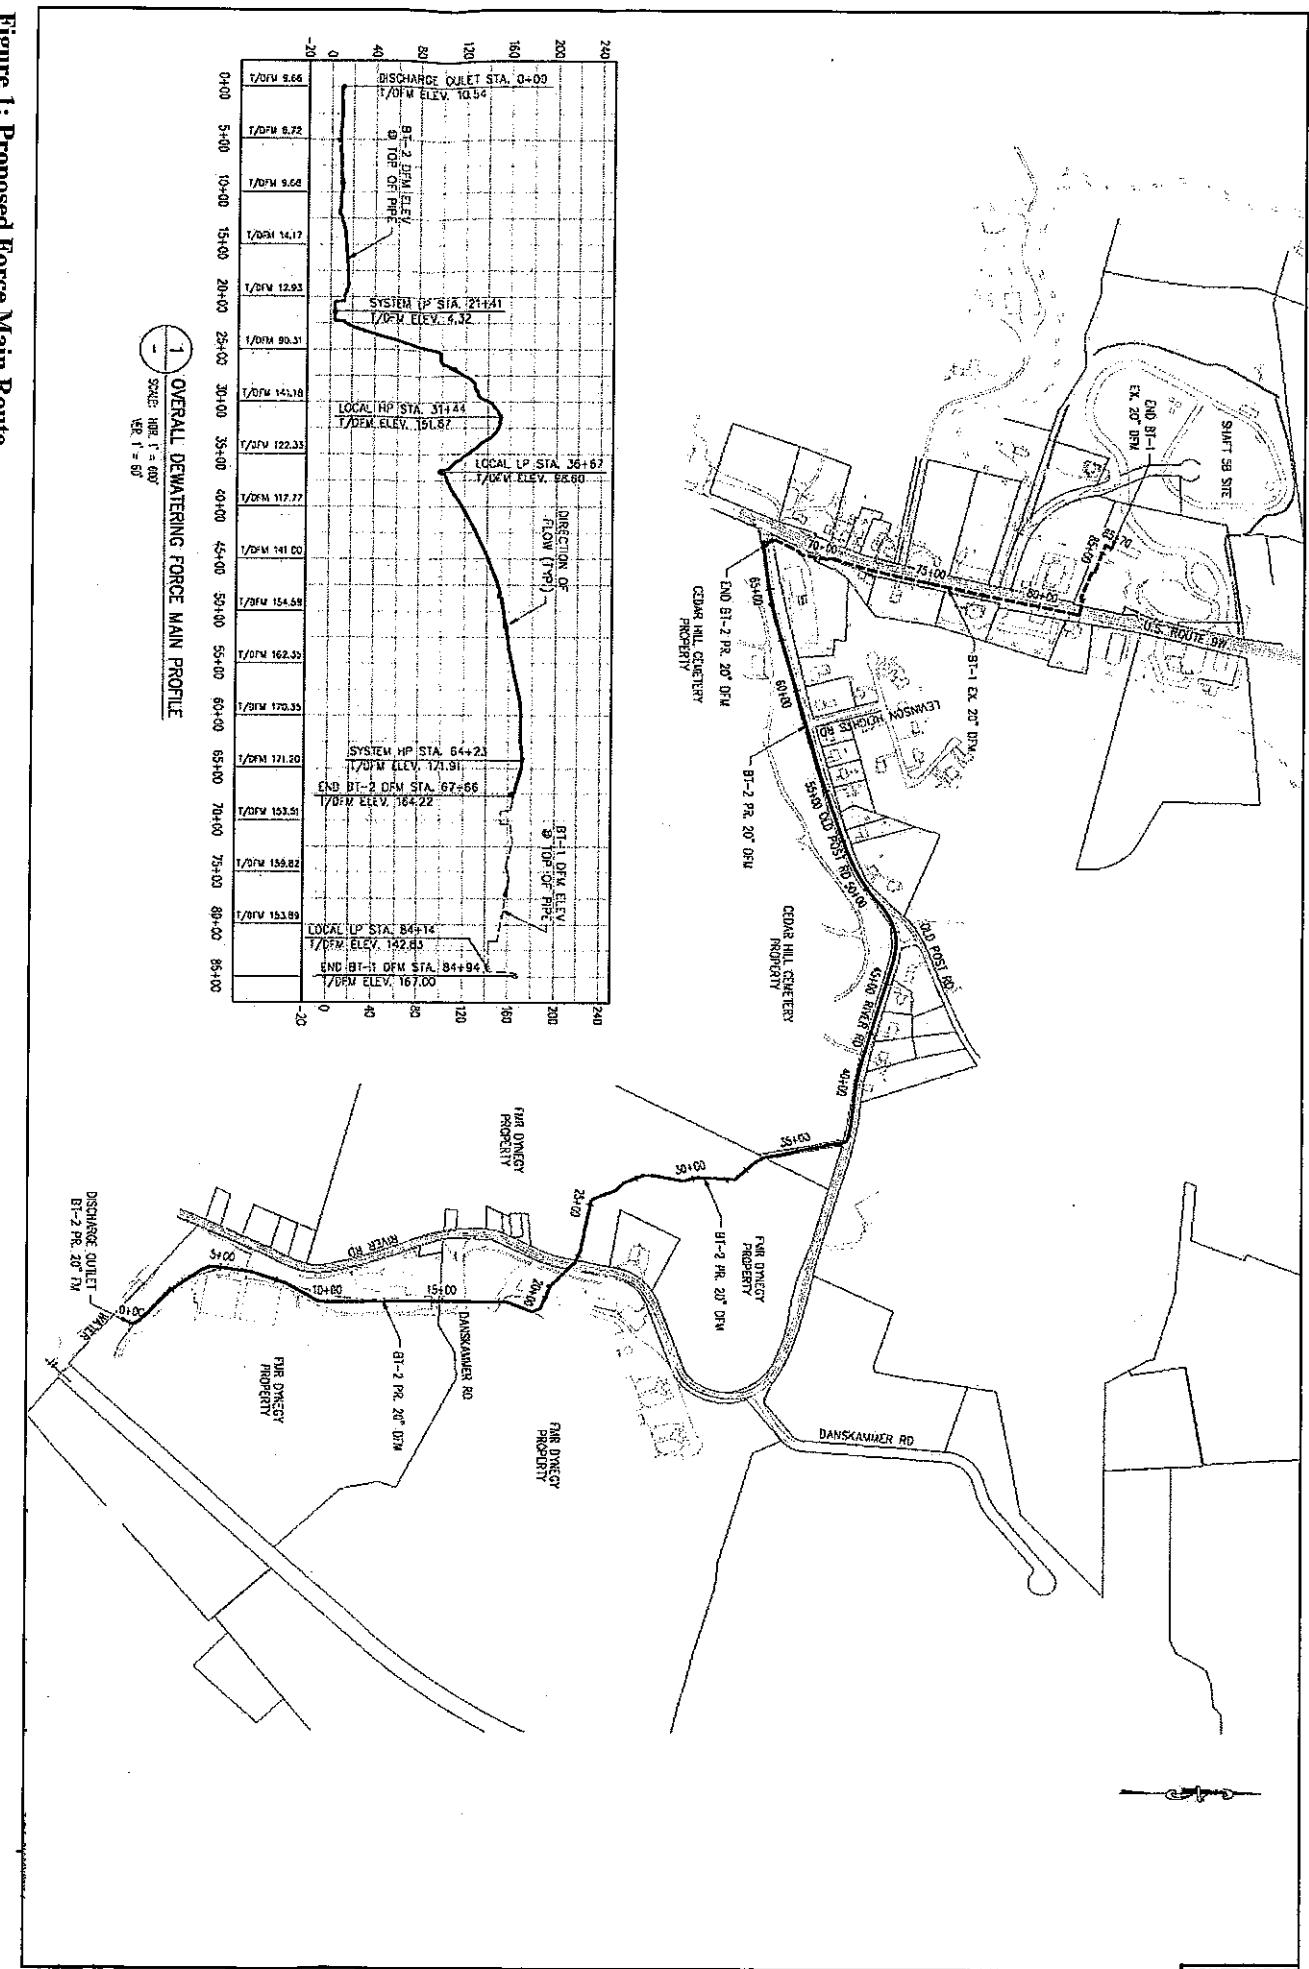


Figure 1: Proposed Force Main Route



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February 7, 2014

Mr. John P. Ewasutyn, Chairman
Town of Newburgh Planning Board
308 Gardner Town Road
Newburgh, New York 12550

Re: New York City Department of Environmental Protection
Delaware Aqueduct Rondout-West Branch Tunnel Repair Program
West Connection Site/Shaft 5B
Bell Property Preliminary Conceptual Design
Town Project Number 2013-5¹

Dear Mr. Ewasutyn:

Please see the enclosed drawing package that represents the preliminary design for the proposed expansion of DEP's Rondout West Branch Tunnel Repair Program Shaft 5B site onto the adjacent lot to the north, Tax Lot 8-1-22.2, the parcel currently owned by Mr. William E. Bell, Robert Bell, Jr., and Charles A. Perella (i.e., the Bell property). DEP has proposed the expansion into the Bell property for the purposes of placement of material from bypass tunnel excavation, process water treatment, and construction storage and laydown area. Beyond efficiency benefits for DEP, the use of the Bell property for these purposes would reduce the traffic associated with transporting excavated material from the bypass tunnel on Route 9W as the material would be handled solely on the internal, larger, combined site.

The intention of this submission is to introduce the Town of Newburgh Planning Board to DEP's conceptual design for the Bell property and solicit feedback from the Planning Board in order to address comments, concerns, and regulatory obligations as the design progresses. DEP would like to continue to work with the Planning Board and Town staff through the spring of this year, as appropriate, to advance the design in accordance with Planning Board and DEP needs so that a complete application for site plan modification can be made in the summer of 2014.

Please see the enclosed materials, including a brief project description and preliminary design drawings, for more information. DEP looks forward to the February 20, 2014 Planning Board meeting, and is prepared to present the preliminary design and discuss the site plan approval modification request.

Should you have any questions or require additional information in the meantime, please do not hesitate to contact me or my staff.

Sincerely,

Sean McAndrew

FEB 10 2014

cc.

Michael Donnelly, Town of Newburgh Planning Board Attorney (w/ attachments)
Patrick Hines, Town of Newburgh Planning Board Engineer (w/ attachments)
Gerald Canfield, Town of Newburgh Code Compliance Officer (w/ attachments)
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Chris Villari, DEP BEDC (w/o attachments)

¹ The pre-application project number was 2011-15. The post-approval project number is 2013-5.

Project Description
New York City Department of Environmental Protection
Delaware Aqueduct Rondout-West Branch Tunnel Repair Program
West Connection Site/Shaft 5B
Town Project Number 2013-5¹

Bell Property
Preliminary Conceptual Design
February 6, 2014

Introduction

To better support the construction of the Rondout-West Branch Tunnel (RWBT) bypass, DEP has proposed expanding the existing Shaft 5B site by adding the 30.8-acre Bell property to the site plan. The additional space would be used for the following major purposes (see “Background” below for a description of the larger project).

- Placement of excavated material, on the order of 325,000 cubic yards, from the construction of the bypass tunnel;
- Location of settling ponds and treatment facilities to properly treat process water. This would include groundwater drained from the material from the deep rock excavation; and;
- Supplemental storage and laydown to facilitate the bypass tunnel construction, primarily for tunnel lining segments.

The use of the Bell property for these purposes would provide three major benefits to the project and, most importantly, reduce the traffic associated with the project, as follows.

- Streamline incoming construction material storage and handling;
- Provide for more effective process water treatment; and
- Reduce truck traffic by transporting excavated material within the site (i.e., from Shaft 5B to the Bell property) and removing these trucks from traffic on Route 9W.

After construction of the bypass tunnel and completion of the connection to the aqueduct, the Bell property would be returned to a state similar to its existing condition, albeit with a modified topography due to the placement of material. At present, the final landscaping plan has not been developed, but it is DEP’s intention to work with the Town of Newburgh to create a scheme that would mirror and complement the landscaping plan for the 5B site, incorporating the 60-foot

¹ The pre-application project number was 2011-15. The post-approval project number is 2013-5.

buffer of existing vegetation that would be maintained along the perimeter of the site throughout construction.

Background²

The Delaware Aqueduct is critical to the nine million people who rely on the New York City water supply, including New York City and upstate residents. Repairing the Rondout-West Branch portion of the Delaware Aqueduct is required in order to maintain this critical piece of the City's water supply infrastructure. DEP is responsible for ensuring the safe and reliable transmission of drinking water from the watershed to consumers in sufficient quantity to meet all present and future water demands. The RWBT is a critical component of DEP's Delaware water supply system, which provides fifty percent of the City's supply, and is currently leaking, in total, between 10 and 35 million gallons per day in two critical areas in the vicinity of the Wawarsing and Roseton crossings.

Shutting down the Delaware Aqueduct during the bypass tunnel connection and repair of the leak in Wawarsing may require DEP to supplement its water sources, manage demand and make provisions for changes in the distribution system during the shutdown period.

Once ready with all of the necessary provisions for reliable drinking water during the shutdown, DEP will undertake the bypass tunnel connection to the existing Delaware Aqueduct. During the connection period, certain inspection and repairs from within the RWBT will be made to the remainder of the existing tunnel in areas outside the bypassed section, particularly those sections located in the Town of Wawarsing, which need repair.

Construction of the bypass tunnel and shaft sites began with construction of the shafts, which started in 2013 and will be complete in 2015. Construction of the bypass tunnel will begin in 2015 and be connected in 2020. It is anticipated that up to 15 months would be needed to complete the bypass connection and to undertake the inspection and repair of the RWBT, expected to occur sometime in 2021.

Location

The 30.8-acre Bell property (Tax Lot 8-1-22.2, currently owned by Mr. William E. Bell, Robert Bell, Jr., and Charles A. Perella) is located immediately north of and adjacent to Tax Lot 8-1-19.1, the lot comprising the majority of the existing Shaft 5B site. To the east, the Bell property is bordered by Tax Lots 8-1-21.12 and 8-21.22. A narrow portion of the lot also extends to Route 9W. To the north, the site is bounded by a Central Hudson Gas and Electric (CHGE) utility right

² Resolution of Approval: Site Plan for New York City Department of Environmental Protection [Delaware Aqueduct Rondout-West Branch Tunnel Repair Program] Project # 2011-15, certified July 9, 2012. (Note: The pre-application project number was 2011-15. The post-approval project number is 2013-5.)

of way (8-1-31.12). And to the west, the site is adjacent to five lots, including 8-1-85.2, 8-1-85.3, 8-1-85.4, 8-1-4.22, and 8-1-5.1.³

Zoning

The Bell property is zoned “AR, Agricultural” with a “Professional Office Overlay (O)” covering a small portion along the eastern boundary of the site.⁴ Note that it is DEP’s understanding that with the addition of the Bell property, the full, combined site would be considered a public utility, as the Shaft 5B site is currently categorized with regard to zoning and use variances.

Construction Use and Final Disposition

As indicated in the introduction, the Bell property would be used for additional storage and laydown, water treatment and, primarily, for placement of excavated material from the bypass tunnel construction. Activities associated with these purposes would occur largely within the interior of the site and within a 60-foot buffer of existing vegetation, except along the southern border with the existing Shaft 5B site. After construction is completed, the Bell property would be returned to a state similar to its existing condition, albeit with a modified topography due to the filling activity. At present, the final landscaping plan has not been developed, but it is DEP’s intention to work with the Town of Newburgh to develop a scheme that would mirror and complement the landscaping plan for the 5B site as well as integrating the 60-foot buffer.

Forthcoming Information

As the design progresses, DEP will work with the Planning Board to provide additional information required to modify the existing Shaft 5B site plan approval. For instance, a Stormwater Pollution Prevention Plan (SWPPP), a detailed construction description, an environmental assessment,⁵ and additional information as listed in the “Town of Newburgh Planning Board Application Package for Subdivisions, Site Plans, Lot Line Changes, and Special Exception Use Permits Procedures and Requirements” would be provided, as appropriate.

³ Town of Newburgh Tax Year 2013, Tax Map 334600, Orange County Tax Map Department, New York

⁴ Town of Newburgh, Orange County, New York, Official Zoning Map, Orange County Planning Department, October 22, 2012.

⁵ The environmental review will include cumulative transportation, air, noise, greenhouse gas, and historic resources assessments for use of both the current site and the proposed Bell property, among others.

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ENVIRONMENTAL PROTECTION
BUREAU OF ENGINEERING DESIGN & CONSTRUCTION


96-05 HORACE HARDING EXPRESSWAY 5th FLOOR

CORONA, NEW YORK 11368

www.nyc.gov/dep

**RONDOUT-WEST BRANCH BYPASS TUNNEL
SHAFT 5B THE TOWN OF NEWBURGH, NY**


DATE: FEBRUARY 10, 2014
WEST CONNECTION SITE
SITE PLAN MODIFICATION:
BELL PROPERTY CONCEPTUAL DESIGN
TOWN PROJECT #2013-5

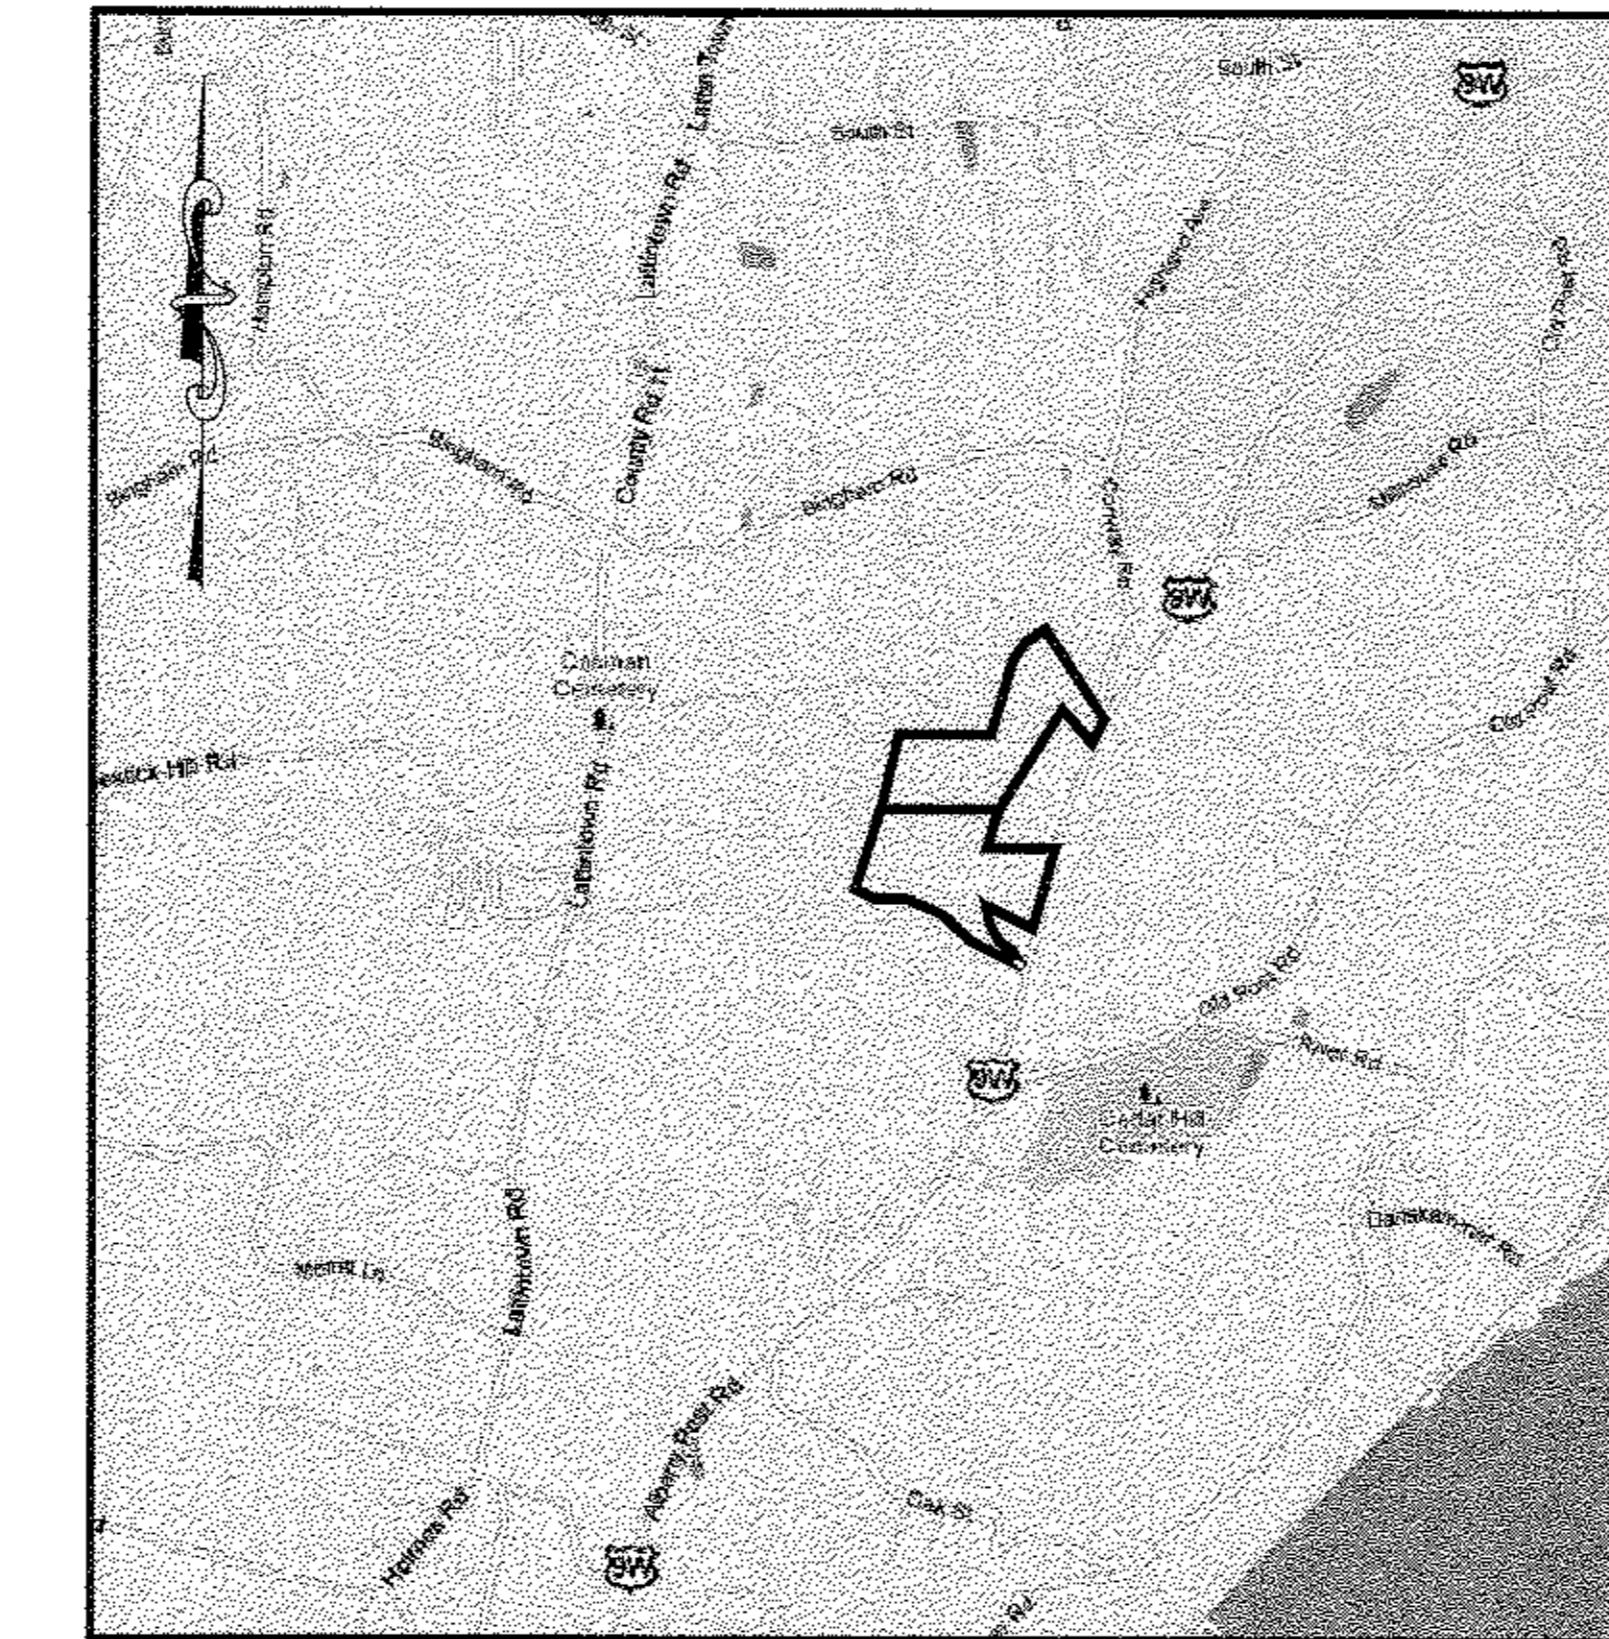

LOCATION PLAN – WEST CONNECTION SITE

SCALE: 1" = 2000' (APPROX)

0 2000 4000 FT.
1"=2000'

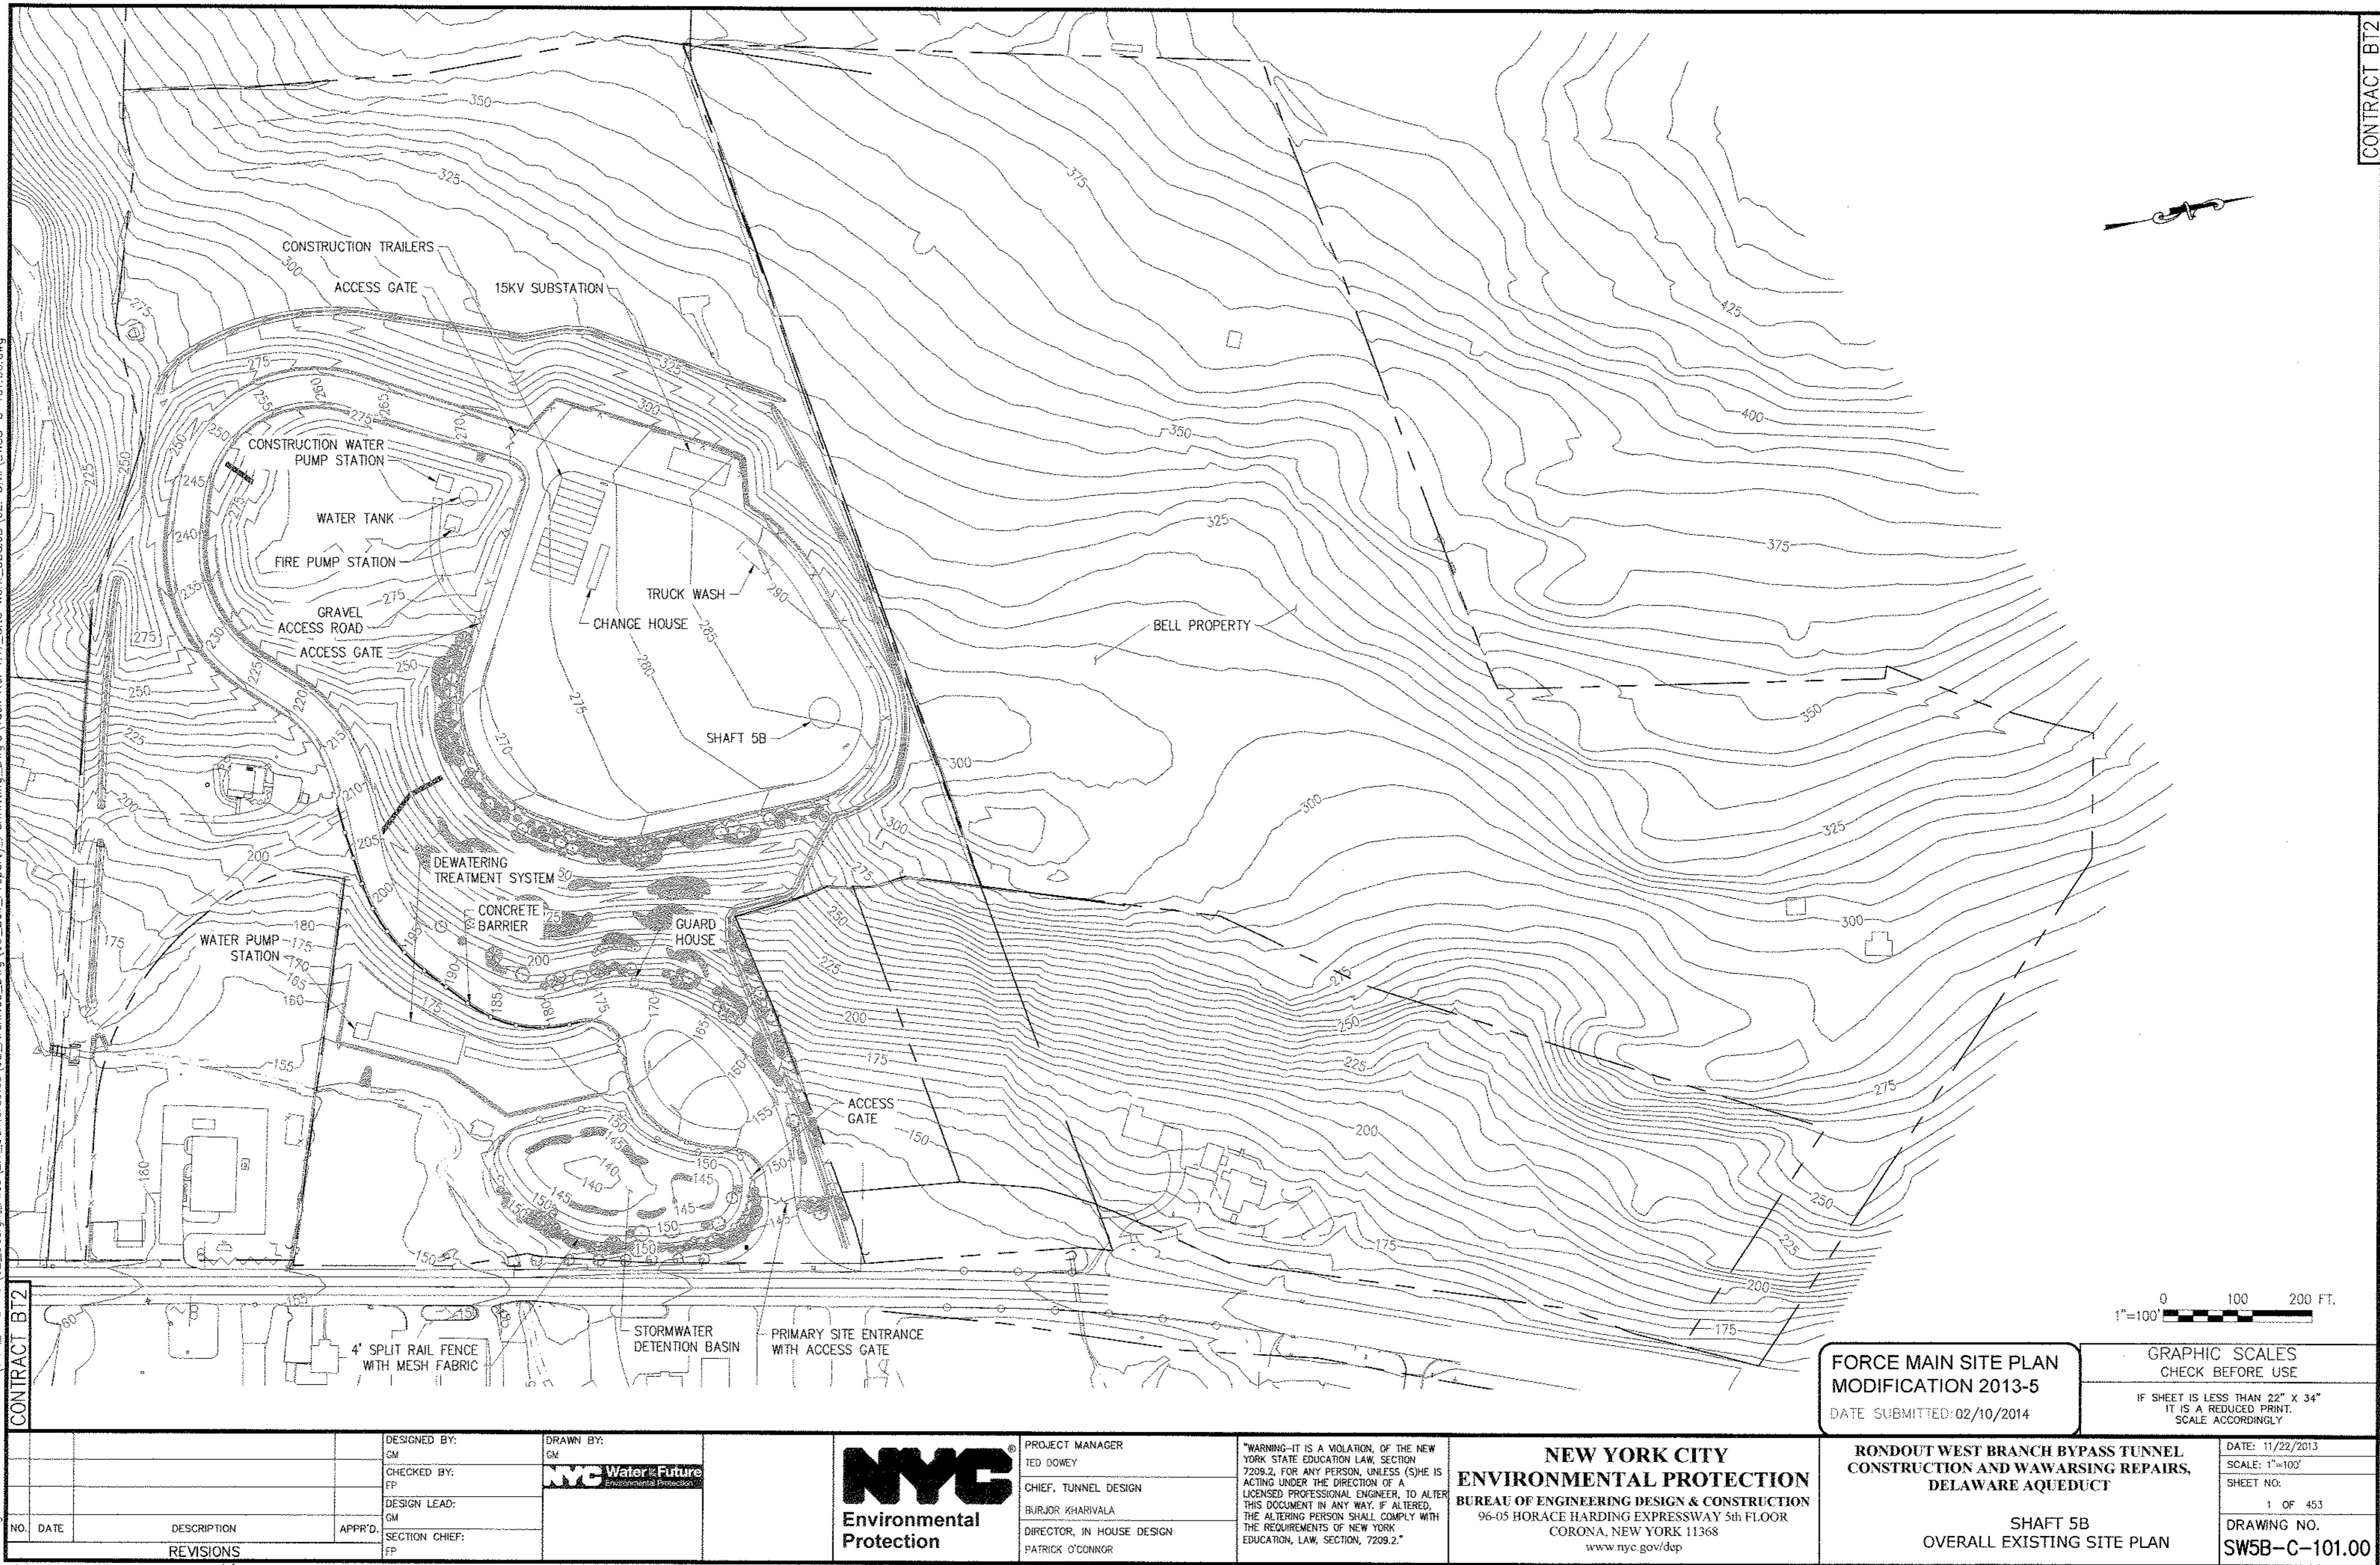

PRELIMINARY

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RONDOUT-WEST BRANCH BYPASS PROJECT

NEW YORK STATE

BELL PROPERTY SITE DESIGN EXISTING CONDITIONS AFTER BT-1

DATE

02/04/2014

FIGURE

1

JACOBS ASSOCIATES

Engineers/Consultants






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JACOBS ASSOCIATES
Engineers/Consultants

NYC
Environmental Protection

**RONDOUT-WEST BRANCH BYPASS PROJECT
NEW YORK STATE**
**BELL PROPERTY SITE DESIGN
DEVELOPMENT OF SETTLING BASINS AND ROAD**

| | |
|--------|------------|
| DATE | 02/04/2014 |
| FIGURE | 2 |

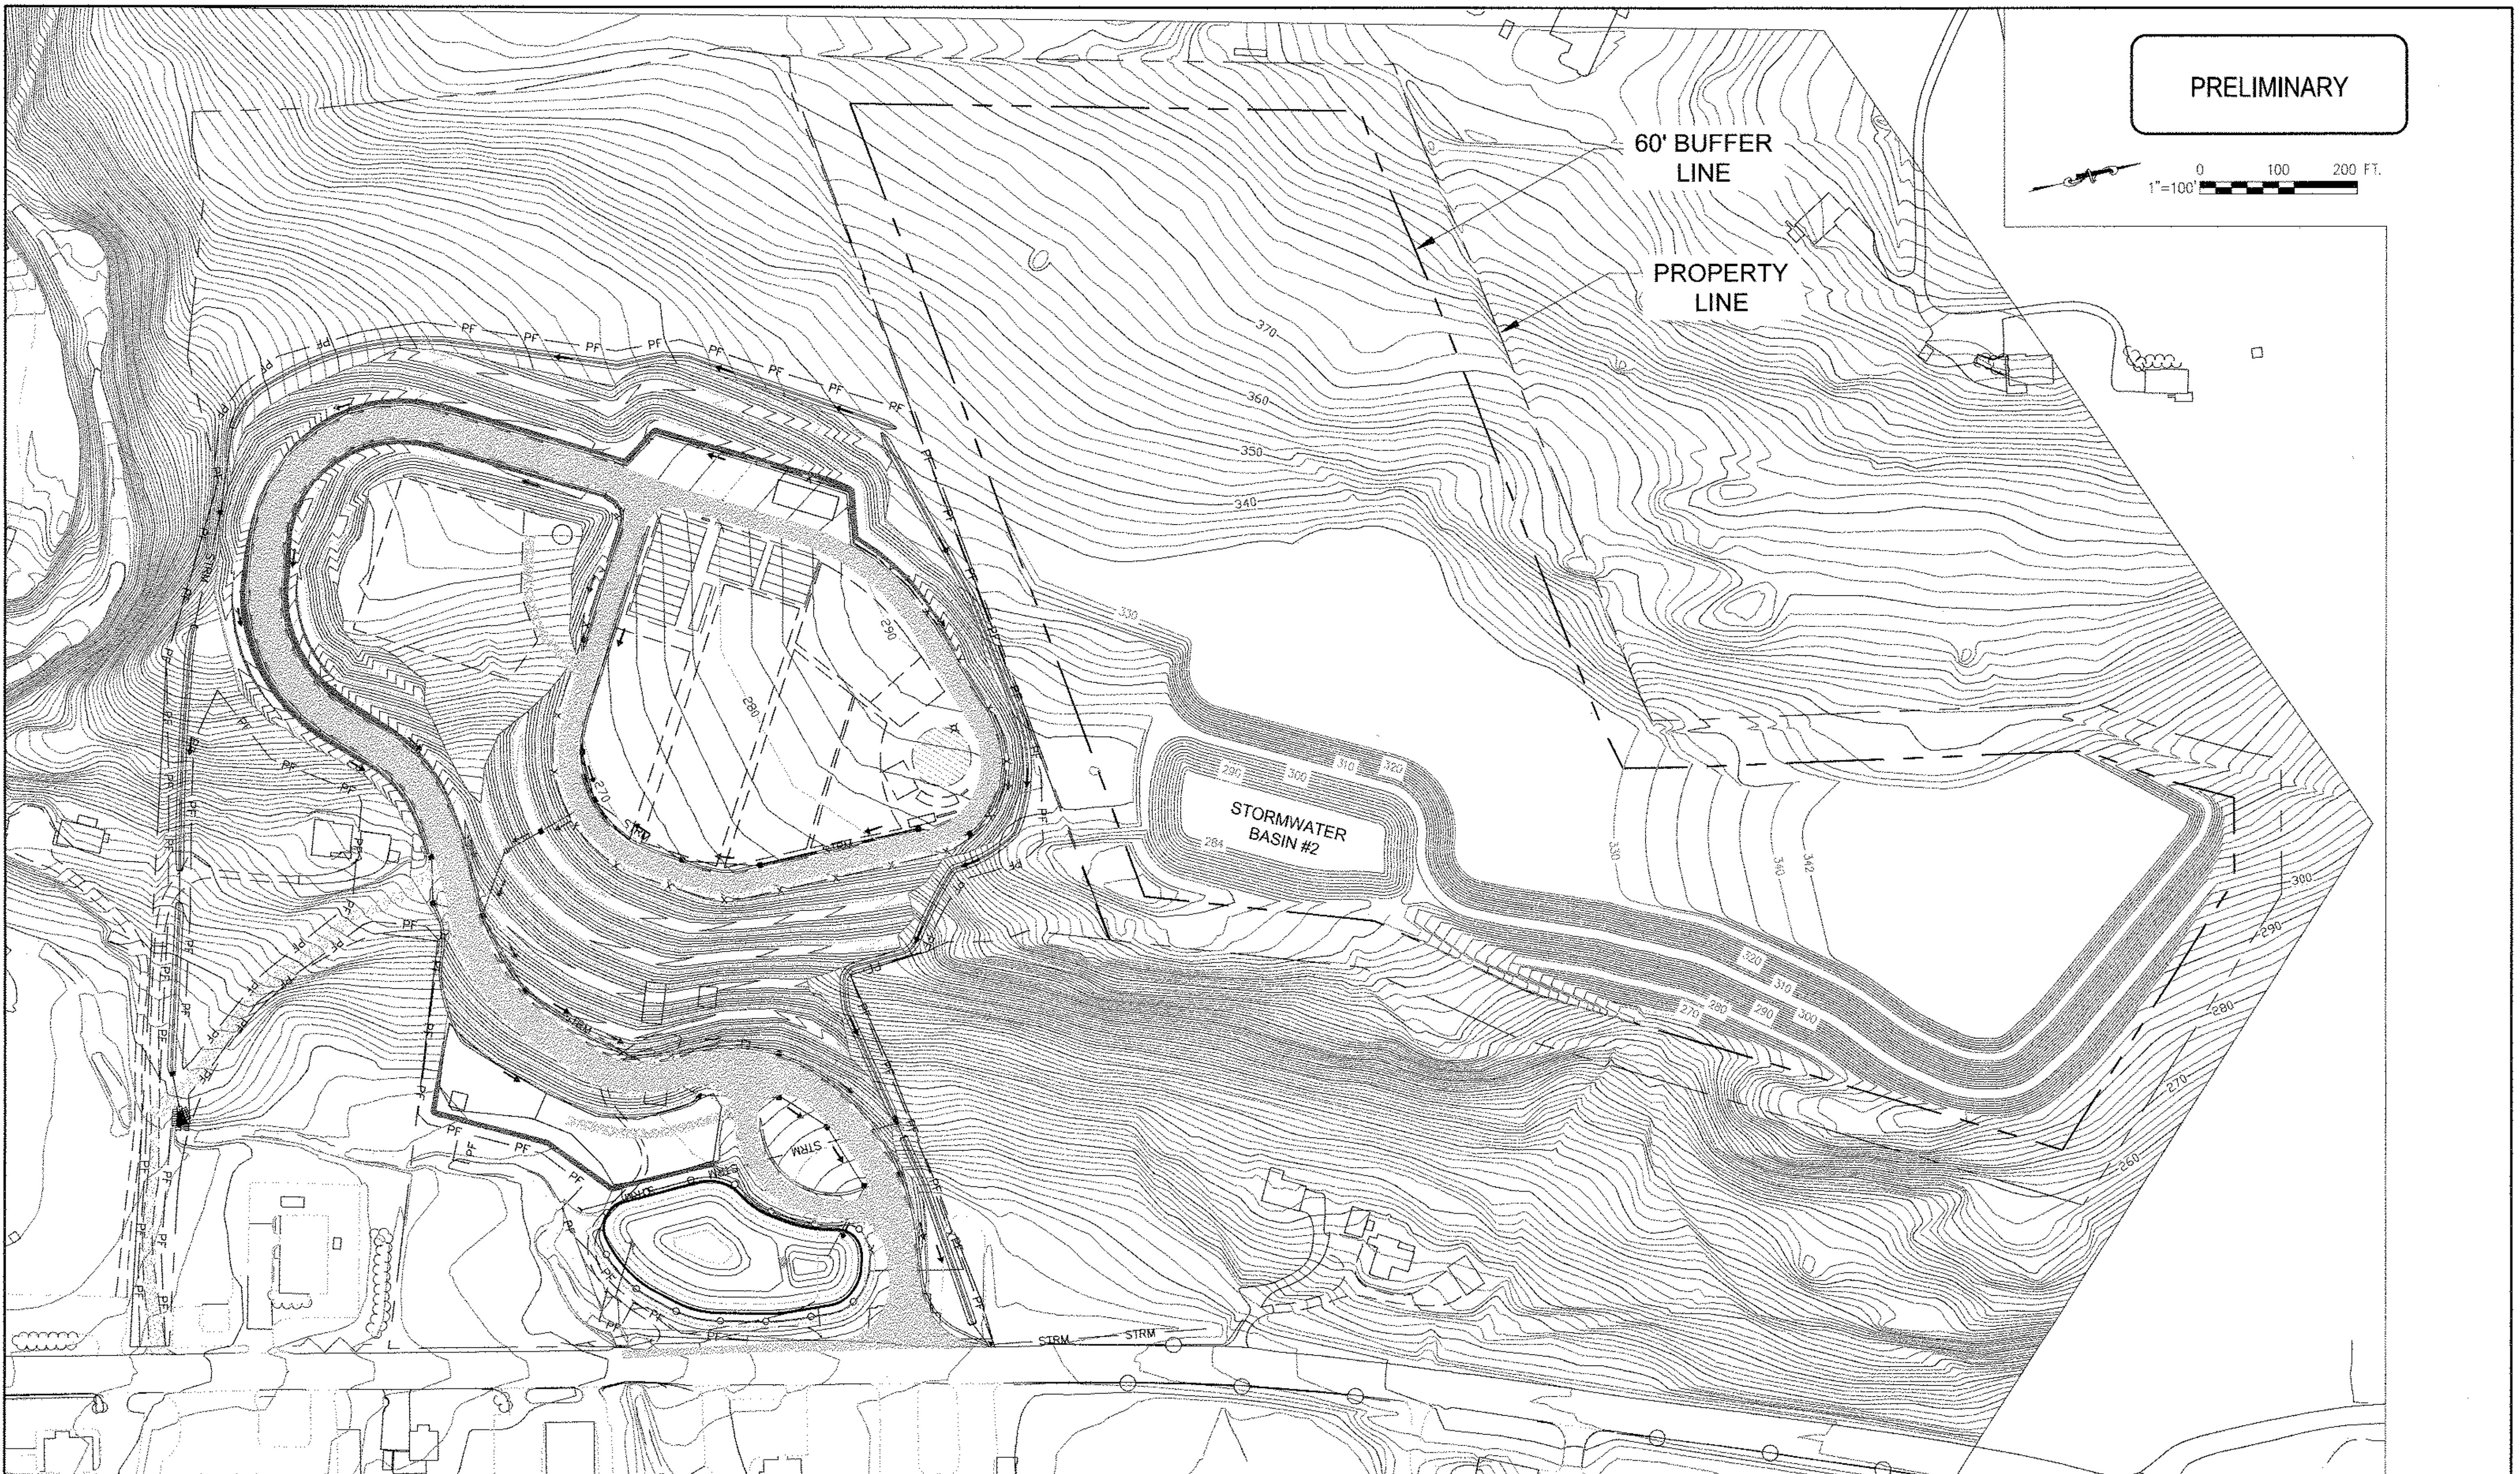

RONDOUT-WEST BRANCH BYPASS PROJECT - BELL PROPERTY SITE DESIGN - 02/04/2014 23:25:24 PM

JACOBS ASSOCIATES
Engineers/Consultants



**RONDOUT-WEST BRANCH BYPASS PROJECT
NEW YORK STATE**
**BELL PROPERTY SITE DESIGN
SITE RESTORATION PLAN**

| DATE |
|------------|
| 02/04/2014 |

| FIGURE |
|--------|
| 3 |

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**RONDOUT-WEST BRANCH BYPASS TUNNEL
SHAFT 5B THE TOWN OF NEWBURGH, NY**

DATE: FEBRUARY 10, 2014
WEST CONNECTION SITE
SITE PLAN MODIFICATION:
DEWATERING FORCE MAIN
TOWN PROJECT #2013-5




LOCATION PLAN – WEST CONNECTION SITE

SCALE: 1" = 2000' (APPROX)
0 2000 4000 FT.
1"=2000'

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CONTRACT BT2

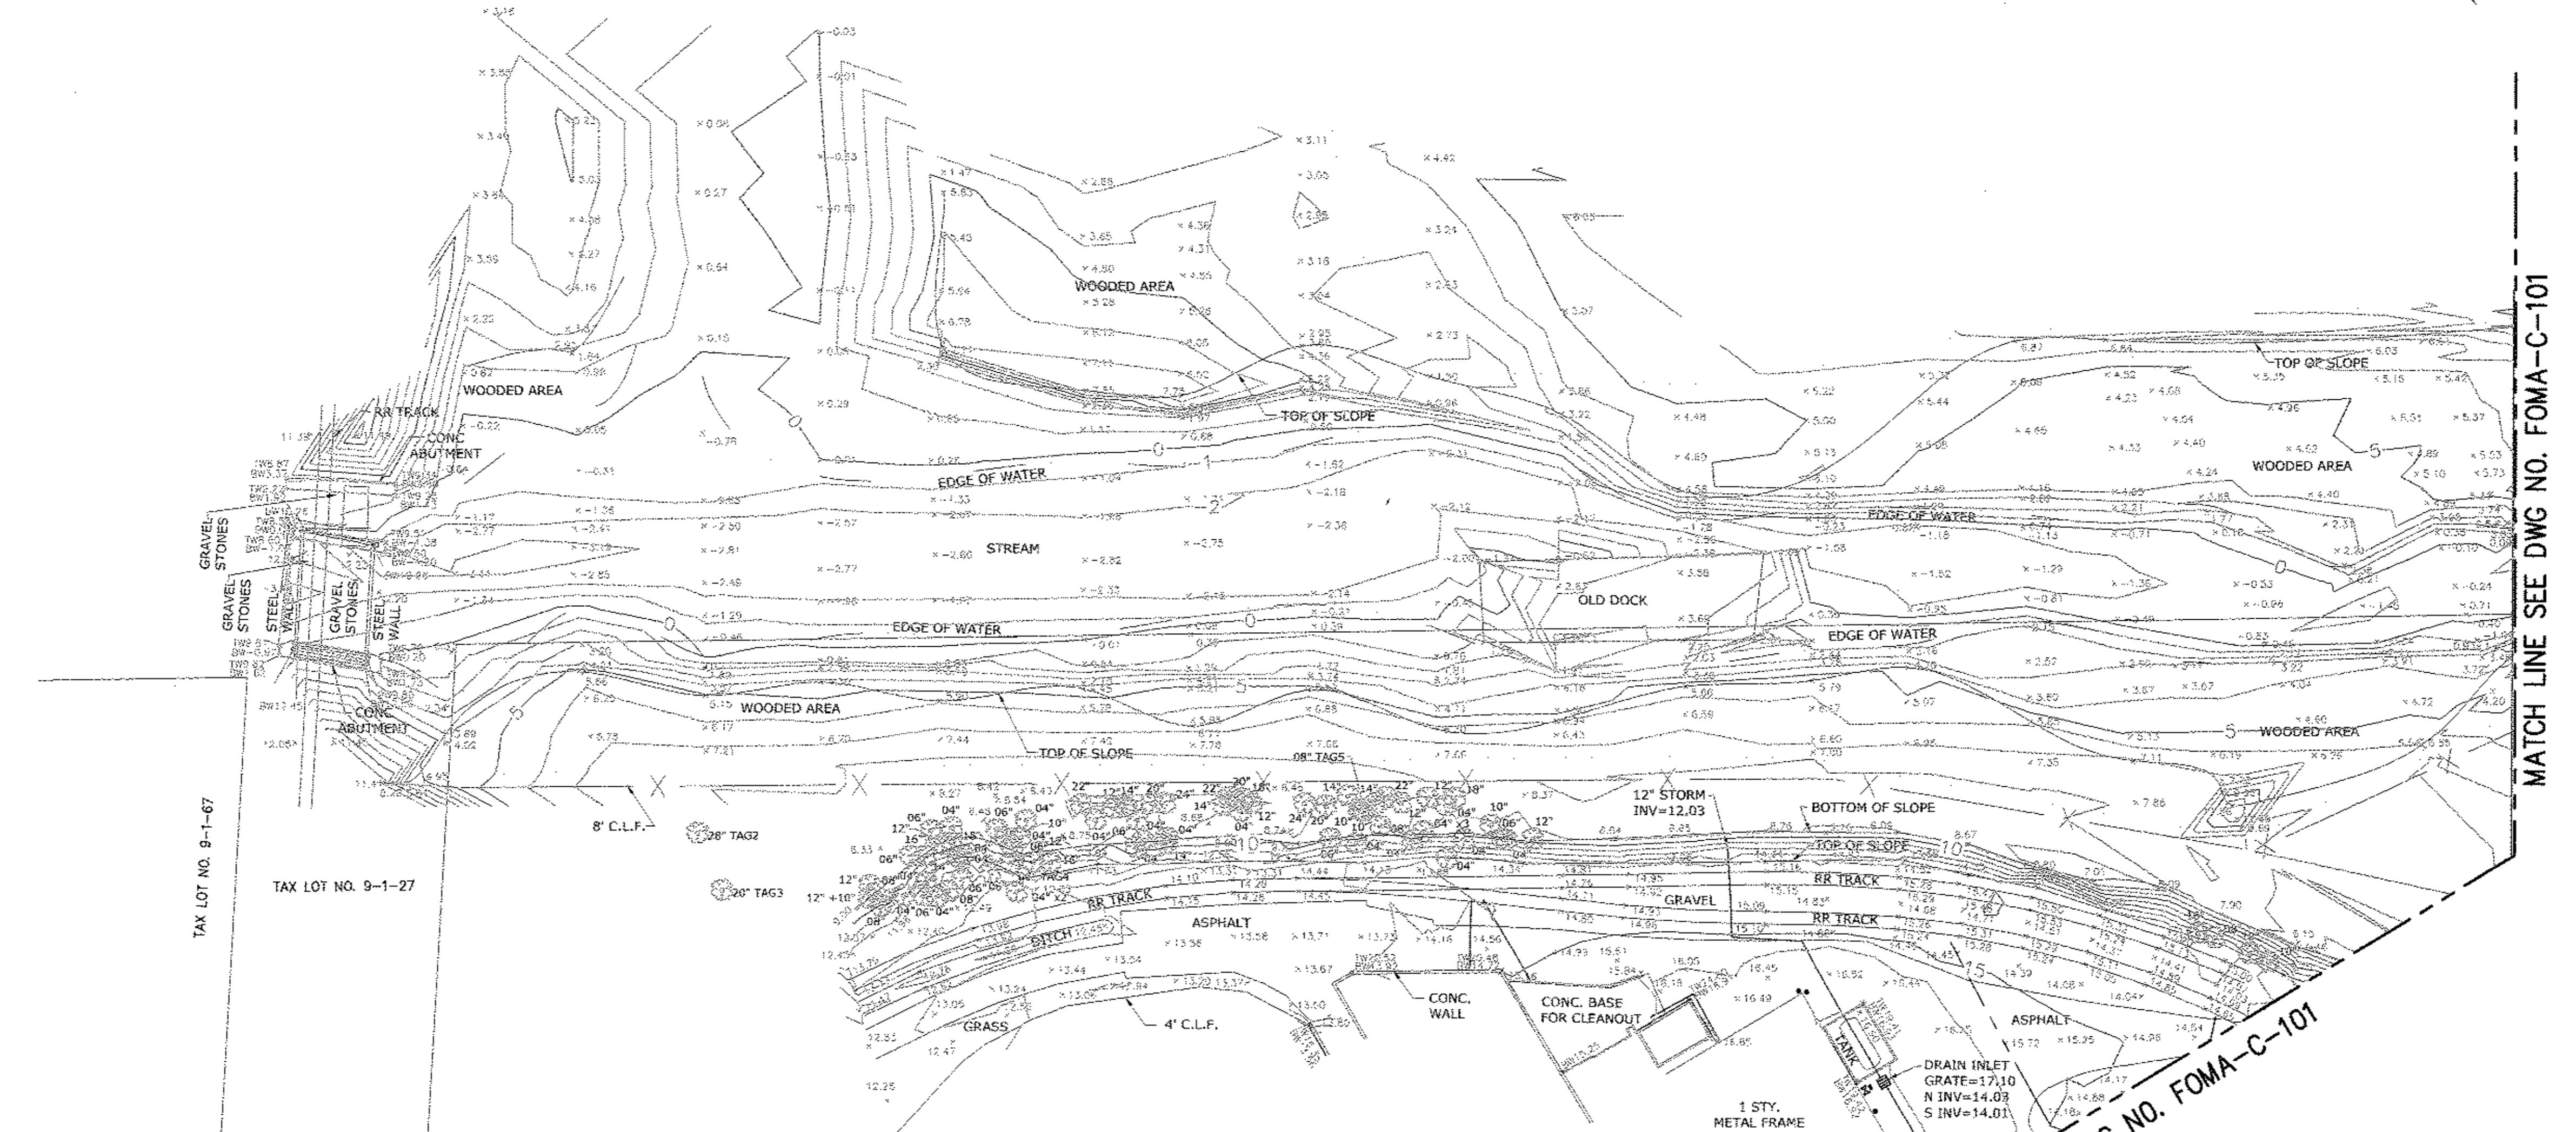

0 40 80 FT.
1"=40'

BELL PROPERTY
SITE DESIGN
DATE SUBMITTED: 02/10/2014

GRAPHIC SCALES
CHECK BEFORE USE

IF SHEET IS LESS THAN 22" X 34"
IT IS A REDUCED PRINT,
SCALE ACCORDINGLY

| | | | | |
|--------------------|-----------------|------------------------------|---|---|
| DESIGNED BY: GM | DRAWN BY: GM | | PROJECT MANAGER TED DOWNEY | "WARNING--IT IS A VIOLATION, OF THE NEW YORK STATE EDUCATION LAW, SECTION 7209.2, FOR ANY PERSON, UNLESS (S)HE IS ACTING UNDER THE DIRECTION OF A LICENSED PROFESSIONAL ENGINEER, TO ALTER THIS DOCUMENT IN ANY WAY. IF ALTERED, THE ALTERING PERSON SHALL COMPLY WITH THE REQUIREMENTS OF NEW YORK EDUCATION, LAW, SECTION, 7209.2." |
| CHECKED BY: FP | | NYC Environmental Protection | CHIEF, TUNNEL DESIGN BURJAR KHARIVALA | |
| DESIGN LEAD: GM | | | DIRECTOR, IN-HOUSE DESIGN PATRICK O'CONNOR | |
| NO. DATE | DESCRIPTION | APPR'D. | | |
| | REVISIONS | FP | | |



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RONDOUT WEST BRANCH BYPASS TUNNEL
CONSTRUCTION AND WAWARSING REPAIRS,
DELWARE AQUEDUCT
FORCE MAIN
EXISTING TOPOGRAPHIC SURVEY
SHEET 1 OF 8

DATE: 11/22/2013
SCALE: 1/8"=1'-0"
SHEET NO:
1 OF 453
DRAWING NO.
FOMA-C-100.00



0 40 80 FT.
1"=40'

BELL PROPERTY
SITE DESIGN
DATE SUBMITTED: 02/10/2014

GRAPHIC SCALES
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SCALE ACCORDINGLY

RONDOUT WEST BRANCH BYPASS TUNNEL
CONSTRUCTION AND WAWARSING REPAIRS,
DELWARE AQUEDUCT
FORCE MAIN
EXISTING TOPOGRAPHIC SURVEY
SHEET 2 OF 8

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1 OF 453
DRAWING NO.
FOMA-C-101.00




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| CHECKED BY: FP | | |
| DESIGN LEAD: GM | | |
| SECTION CHIEF: FP | | |
| REVISIONS | | |

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| NO. | DATE | DESCRIPTION | APPR'D. | PROJECT MANAGER TED DOWNEY CHIEF, TUNNEL DESIGN BURJOR KHARJALA DIRECTOR, IN-HOUSE DESIGN PATRICK O'CONNOR | "WARNING--IT IS A VIOLATION, OF THE NEW YORK STATE EDUCATION LAW, SECTION 7209.2, FOR ANY PERSON, UNLESS (S)HE IS ACTING UNDER THE DIRECTION OF A LICENSED PROFESSIONAL ENGINEER, TO ALTER THIS DOCUMENT IN ANY WAY. IF ALTERED, THE ALTERING PERSON SHALL COMPLY WITH THE REQUIREMENTS OF NEW YORK EDUCATION, LAW, SECTION, 7209.2." |
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CONTRACT BT2



CONTRACT BT2

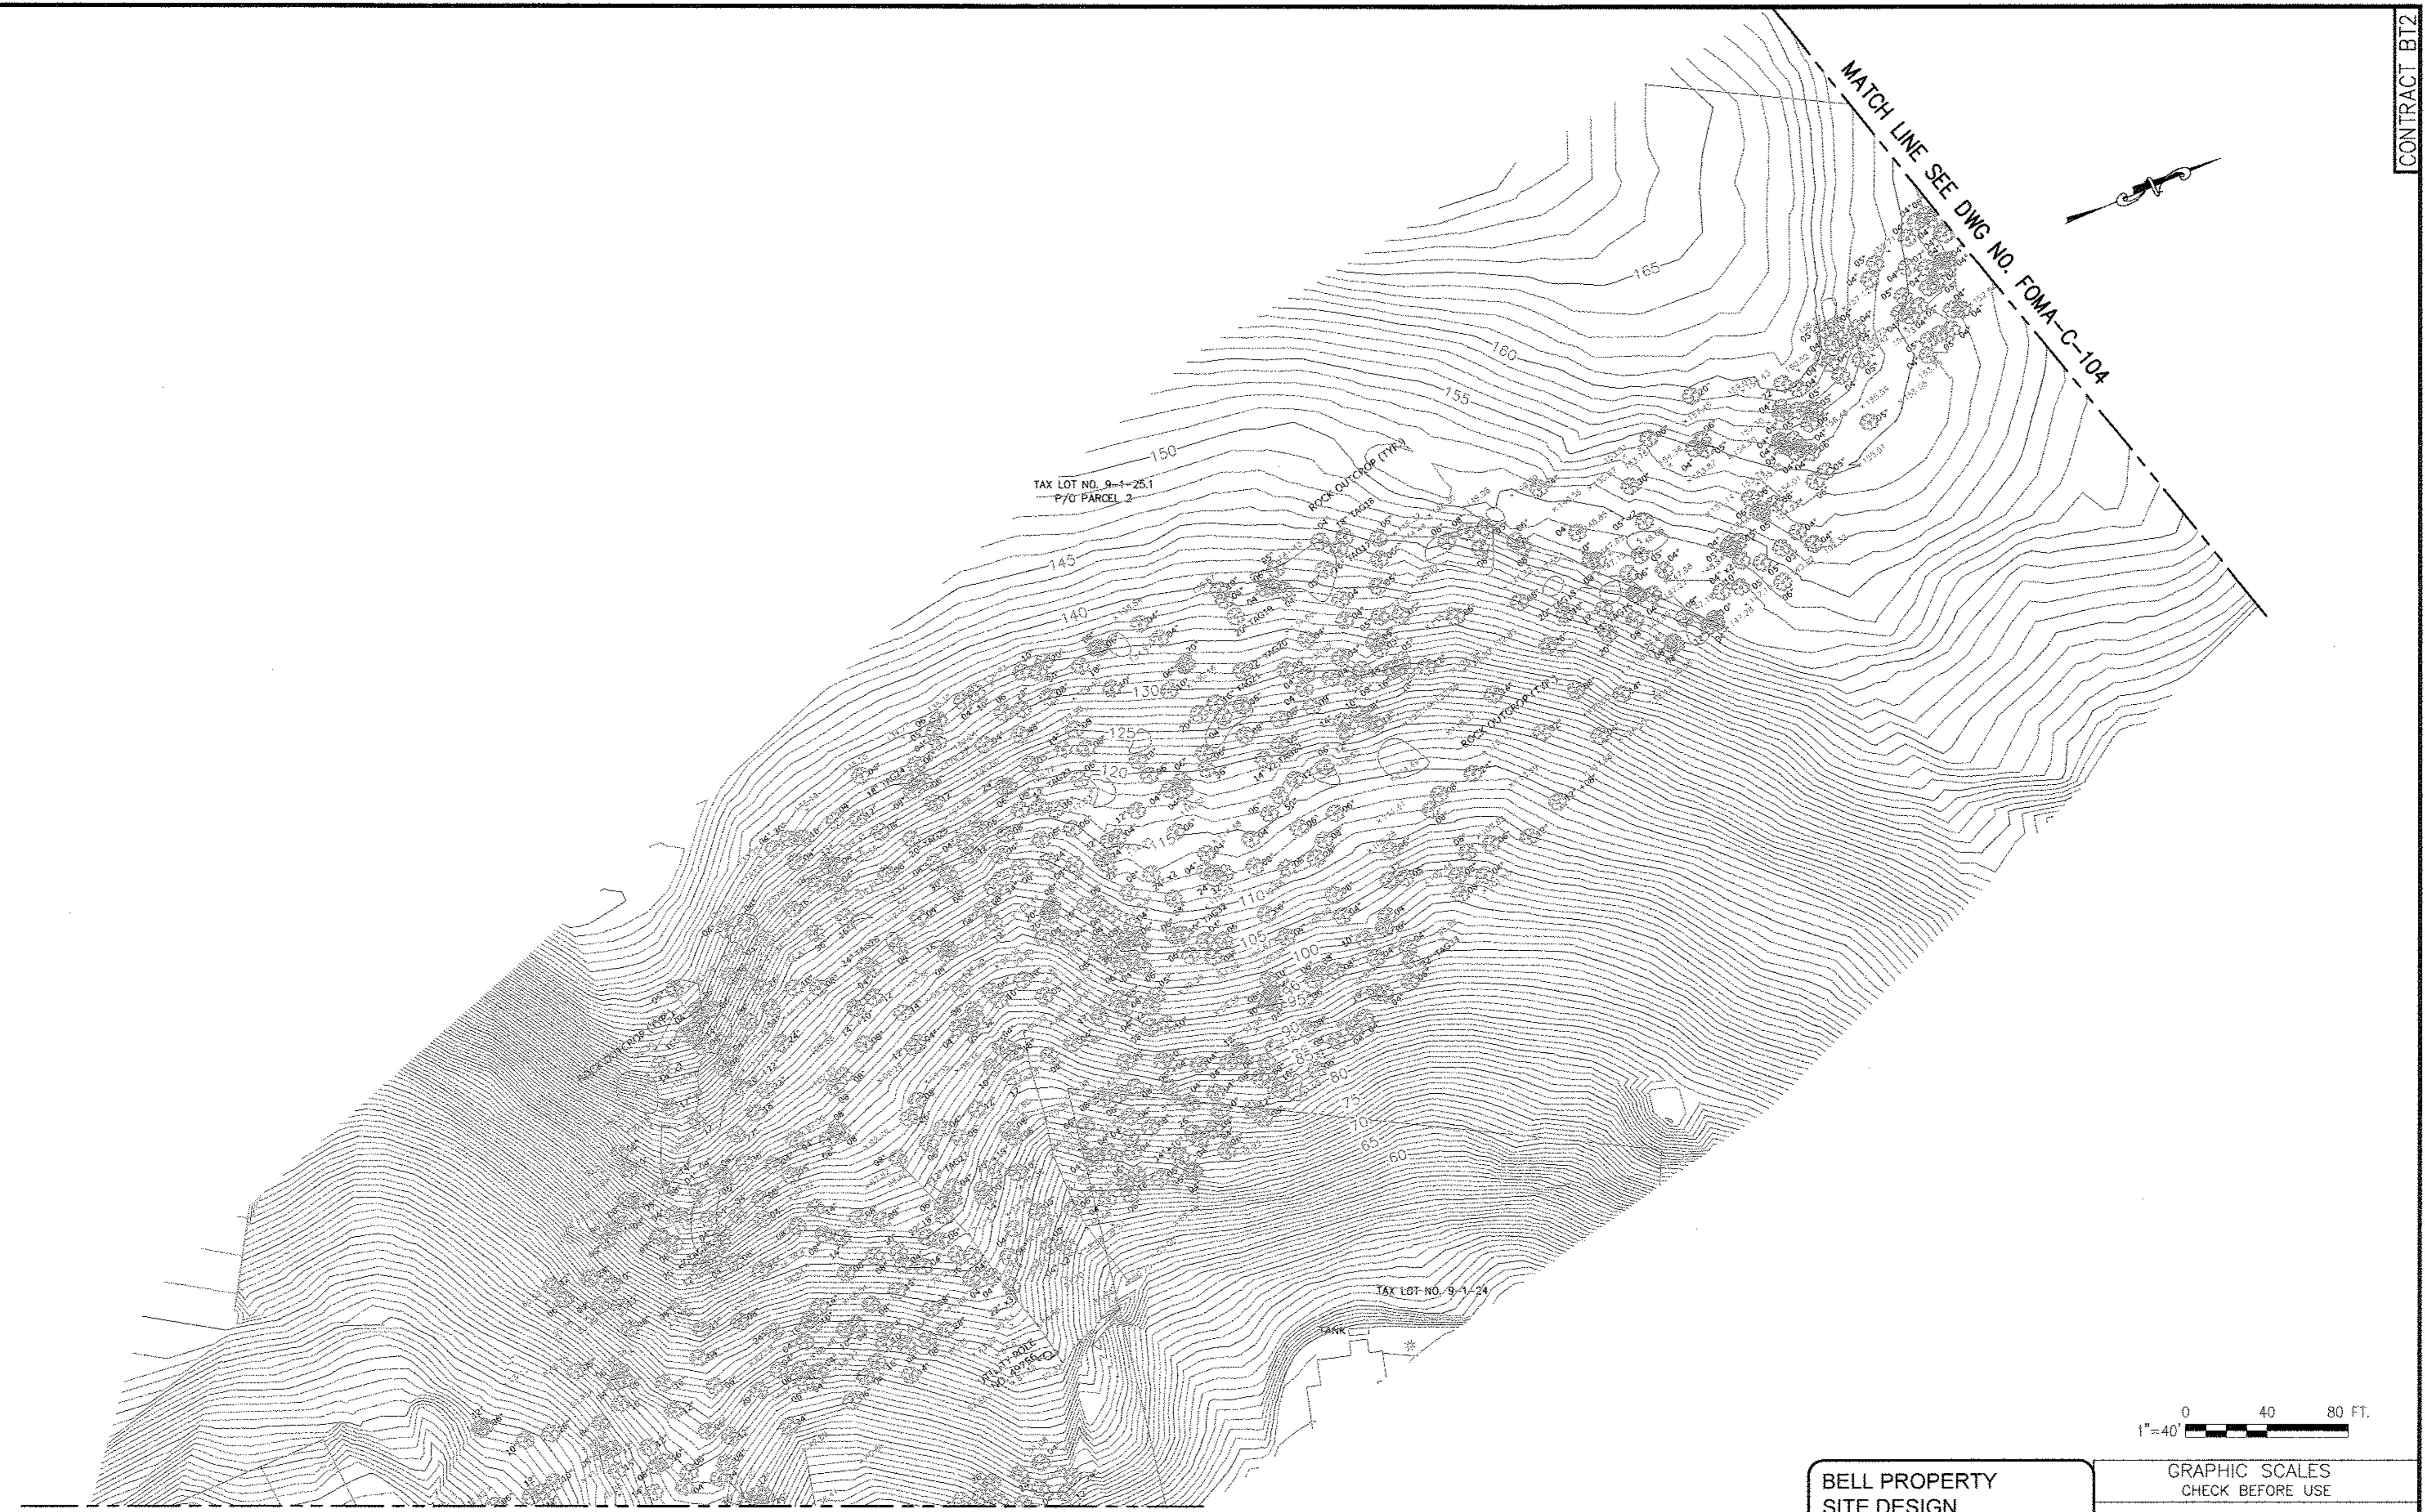MATCH LINE SEE DWG NO. FOMA-C-102

DESIGNED BY:

GM

DRAWN BY:

GM

NYC Water & Future Environmental Protection

NO. DATE DESCRIPTION APPR'D.
REVISIONS SECTION CHIEF:
FP



PROJECT MANAGER
TED DOWNEY

CHIEF, TUNNEL DESIGN
BURJOR KHARIVALA

DIRECTOR, IN-HOUSE DESIGN
PATRICK O'CONNOR


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NEW YORK CITY ENVIRONMENTAL PROTECTION
BUREAU OF ENGINEERING DESIGN & CONSTRUCTION
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BELL PROPERTY SITE DESIGN
DATE SUBMITTED: 02/10/2014

GRAPHIC SCALES
CHECK BEFORE USE
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IT IS A REDUCED PRINT.
SCALE ACCORDINGLY

DATE: 11/22/2013
SCALE: 1/8"=1'-0"
SHEET NO:
1 OF 453
DRAWING NO.
FOMA-C-103.00



Last Saved By & Date: EugeneL Tuesday, February 04, 2014 and Date Plotted: Tuesday, February 04, 2014
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CONTRACT BT2
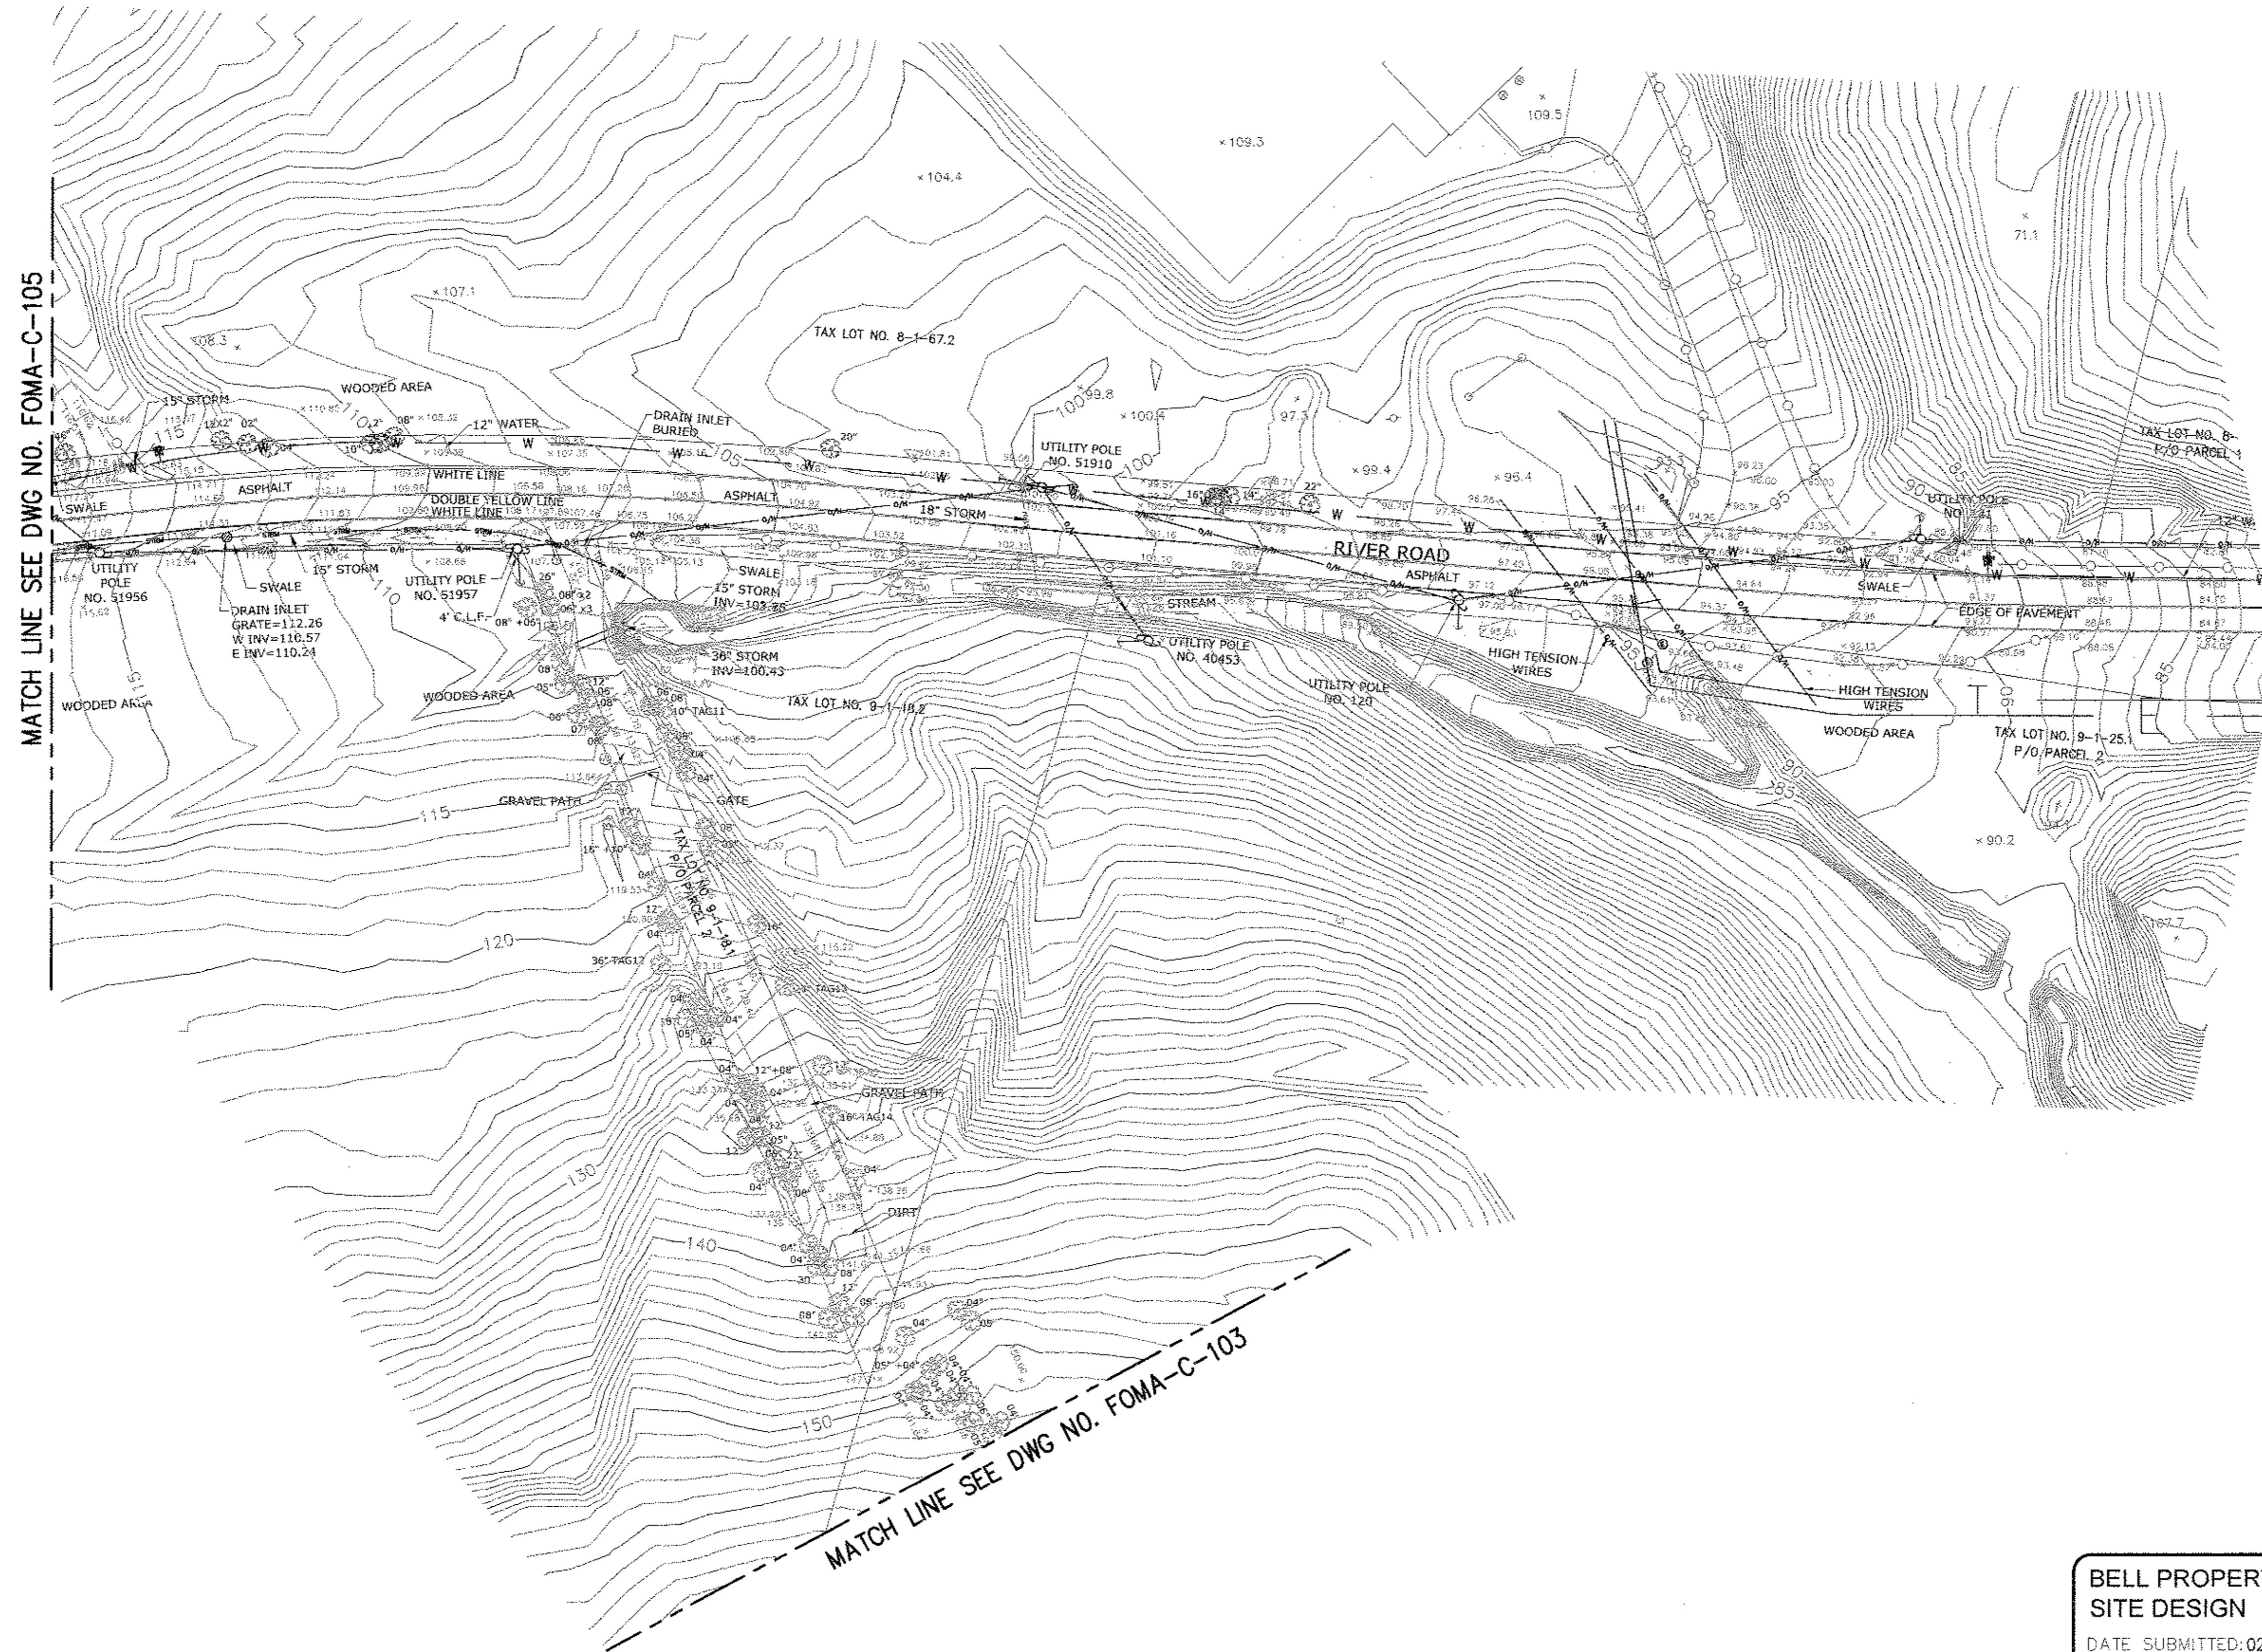
| NO. | DATE | DESCRIPTION | APPR'D. |
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| | | REVISIONS | FP |

DESIGNED BY:
GMDRAWN BY:
GMCHECKED BY:
FPDESIGN LEAD:
GMSECTION CHIEF:
FP

PROJECT MANAGER
TED DOWNEY
CHIEF, TUNNEL DESIGN
BURJAR KHARIVALA
DIRECTOR, IN-HOUSE DESIGN
PATRICK O'CONNOR

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NEW YORK CITY ENVIRONMENTAL PROTECTION
BUREAU OF ENGINEERING DESIGN & CONSTRUCTION
96-05 HORACE HARDING EXPRESSWAY 5th FLOOR
CORONA, NEW YORK 11368
www.nyc.gov/dep

RONDOUT WEST BRANCH BYPASS TUNNEL CONSTRUCTION AND WAWARSING REPAIRS,
DELAWARE AQUEDUCT
FORCE MAIN
EXISTING TOPOGRAPHIC SURVEY
SHEET 5 OF 8

DATE: 11/22/2013
SCALE: 1/8"=1'-0"
SHEET NO:
1 OF 453
DRAWING NO.
FOMA-C-104.00

CONTRACT BT2



0 40 80 FT.

**BELL PROPERTY
SITE DESIGN**
DATE SUBMITTED: 02/10/2014

**GRAPHIC SCALES
CHECK BEFORE USE**

IF SHEET IS LESS THAN 22" X 34"
IT IS A REDUCED PRINT.
SCALE ACCORDINGLY

**RONDOUT WEST BRANCH BYPASS TUNNEL
CONSTRUCTION AND WAWARSING REPAIRS,
DELAWARE AQUEDUCT**
FORCE MAIN
EXISTING TOPOGRAPHIC SURVEY
SHEET 6 OF 8
FOMA-C-105.00

DATE: 11/22/2013
SCALE: 1/64"=1'-0"
SHEET NO:
1 OF 453
DRAWING NO.
FOMA-C-105.00

| NO. | DATE | DESCRIPTION | APPR'D. |
|-----|------|-------------|---------|
| | | REVISIONS | FP |

DESIGNED BY:
GM
DRAWN BY:
GM

CHECKED BY:
FP
NYC Water & Future Environmental Protection

DESIGN LEAD:
GM
SECTION CHIEF:
FP




PROJECT MANAGER
TED DONEY
CHEF, TUNNEL DESIGN
BURJOR KHARVALA
DIRECTOR, IN-HOUSE DESIGN
PATRICK O'CONNOR

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MATCH LINE SEE DWG NO. FOMA-C-105



0 40 80 FT.
1"=40'

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SITE DESIGN
DATE SUBMITTED: 02/10/2014
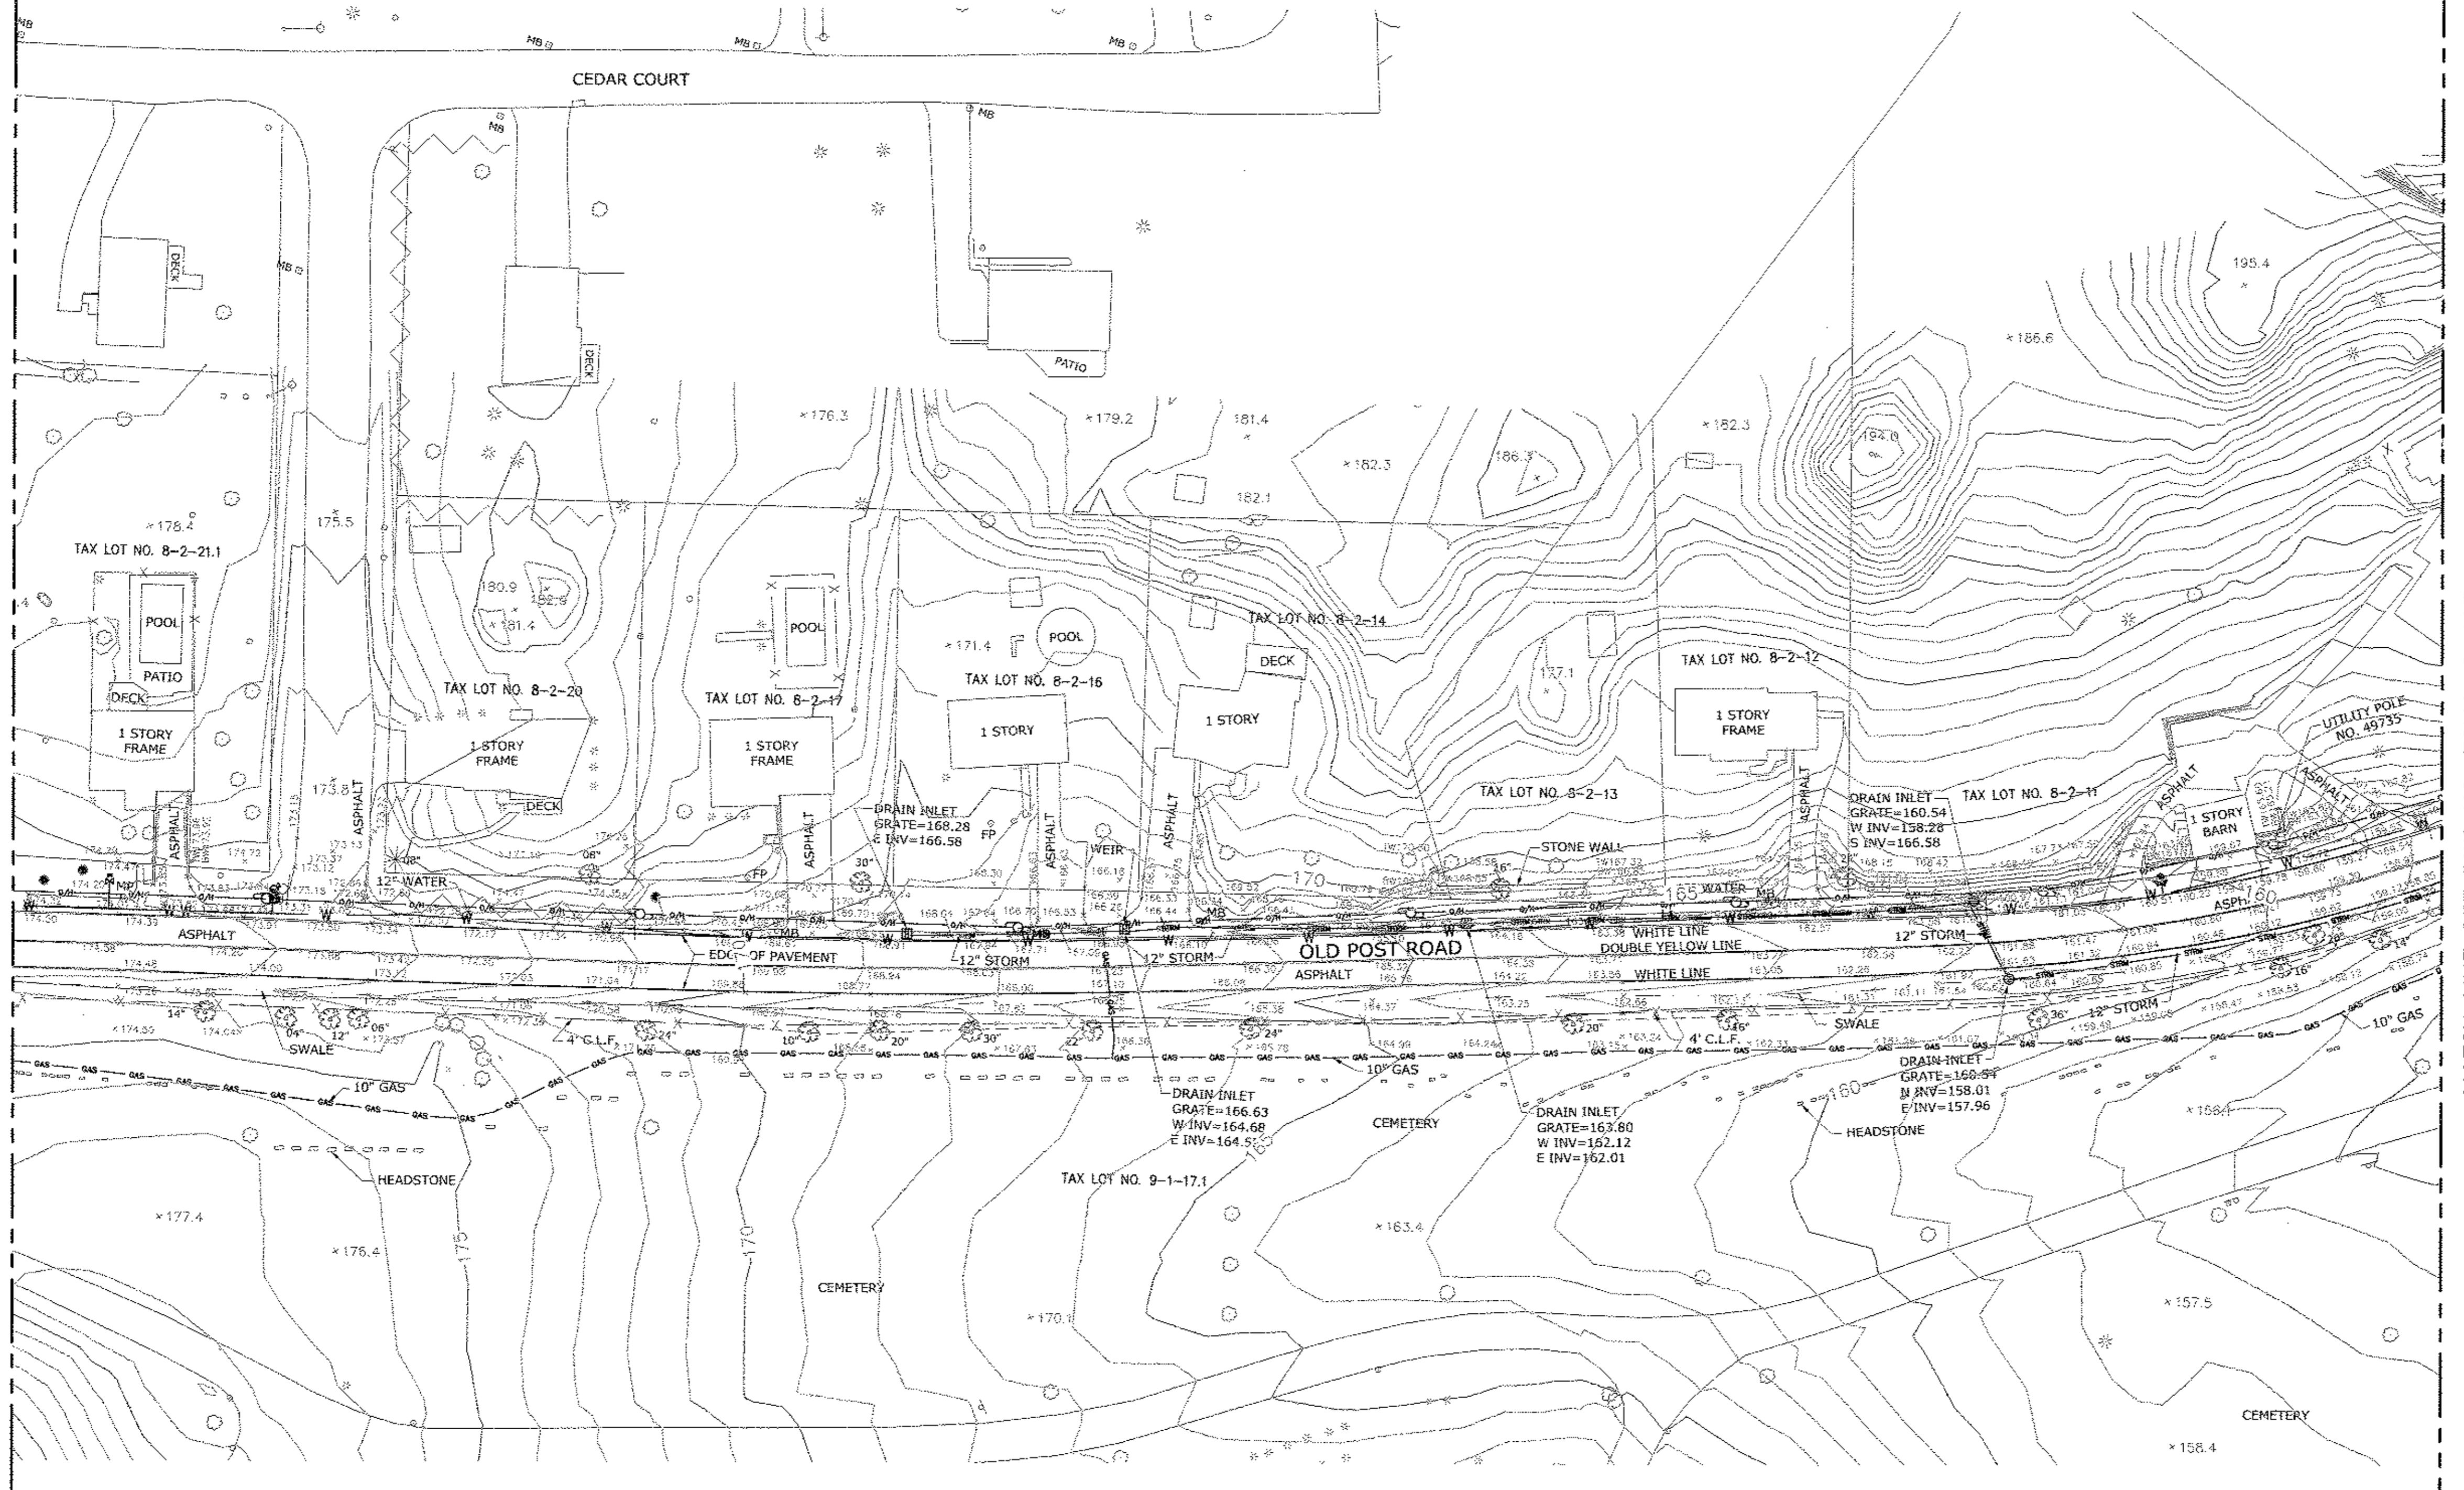
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RONDOUT WEST BRANCH BYPASS TUNNEL
CONSTRUCTION AND WAWARSING REPAIRS,
DELAWARE AQUEDUCT
FORCE MAIN
EXISTING TOPOGRAPHIC SURVEY
SHEET 7 OF 8


DATE: 11/22/2013
SCALE: 1/8"=1'-0"
SHEET NO:
1 OF 453
DRAWING NO.
FOMA-C-106.00

CEDAR COURT

CONTRACT BT2


DESIGNED BY:
GM

DRAWN BY:
GM

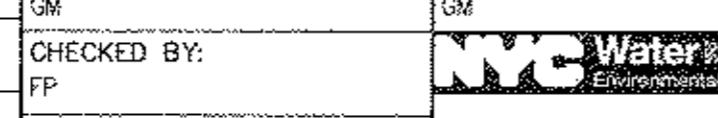

NYC
Water Future
Environmental Protection

ENVIRONMENTAL
PROTECTION

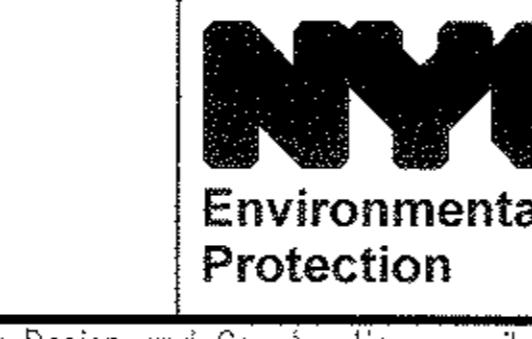

PROJECT MANAGER
TED DOWNEY
CHIEF, TUNNEL DESIGN
BURJOR KHARIVALA
DIRECTOR, IN-HOUSE DESIGN
PATRICK O'CONNOR

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96-05 HORACE HARDING EXPRESSWAY 5TH FLOOR
CORONA, NEW YORK 11368
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0 40 80 FT.
1" = 40'

**BELL PROPERTY
SITE DESIGN**

DATE SUBMITTED: 02/10/2014

**GRAPHIC SCALES
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DATE: 11/22/2013
SCALE: 1/8" = 1'-0"
SHEET NO:
1 OF 453
DRAWING NO.
FOMA-C-107.00

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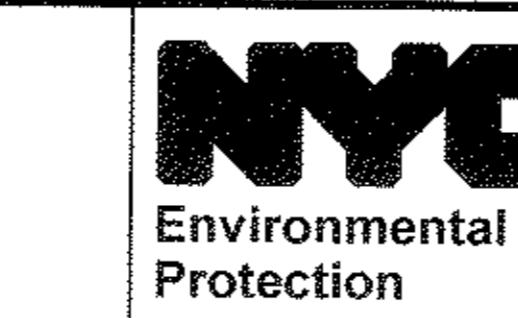
CONTRACT BT2

DESIGNED BY:
GM

DRAWN BY:
GM



NYC
Water Future
Environmental Protection



PROJECT MANAGER
TED DOWNEY
CHIEF, TUNNEL DESIGN
BURJAR KHARIVALA
DIRECTOR, IN-HOUSE DESIGN
PATRICK O'CONNOR


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**RONDOUT WEST BRANCH BYPASS TUNNEL
CONSTRUCTION AND WAWARSHING REPAIRS,
DELAWARE AQUEDUCT**
FORCE MAIN
EXISTING TOPOGRAPHIC SURVEY
SHEET 8 OF 8

Last Saved By & Date: Eugene, Tuesday, February 04, 2014 and Date Plotted: Tuesday, February 04, 2014
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 Drawing Name & Location: B:\BINS\RWB\2\02_Design_J_Files\21_Design\Task No. 1.13_Force Main...\5B\02_Civil\InfoMA-C-108.00.dwg

CONTRACT BT2



0 10 20 50 FT.
1"=300'

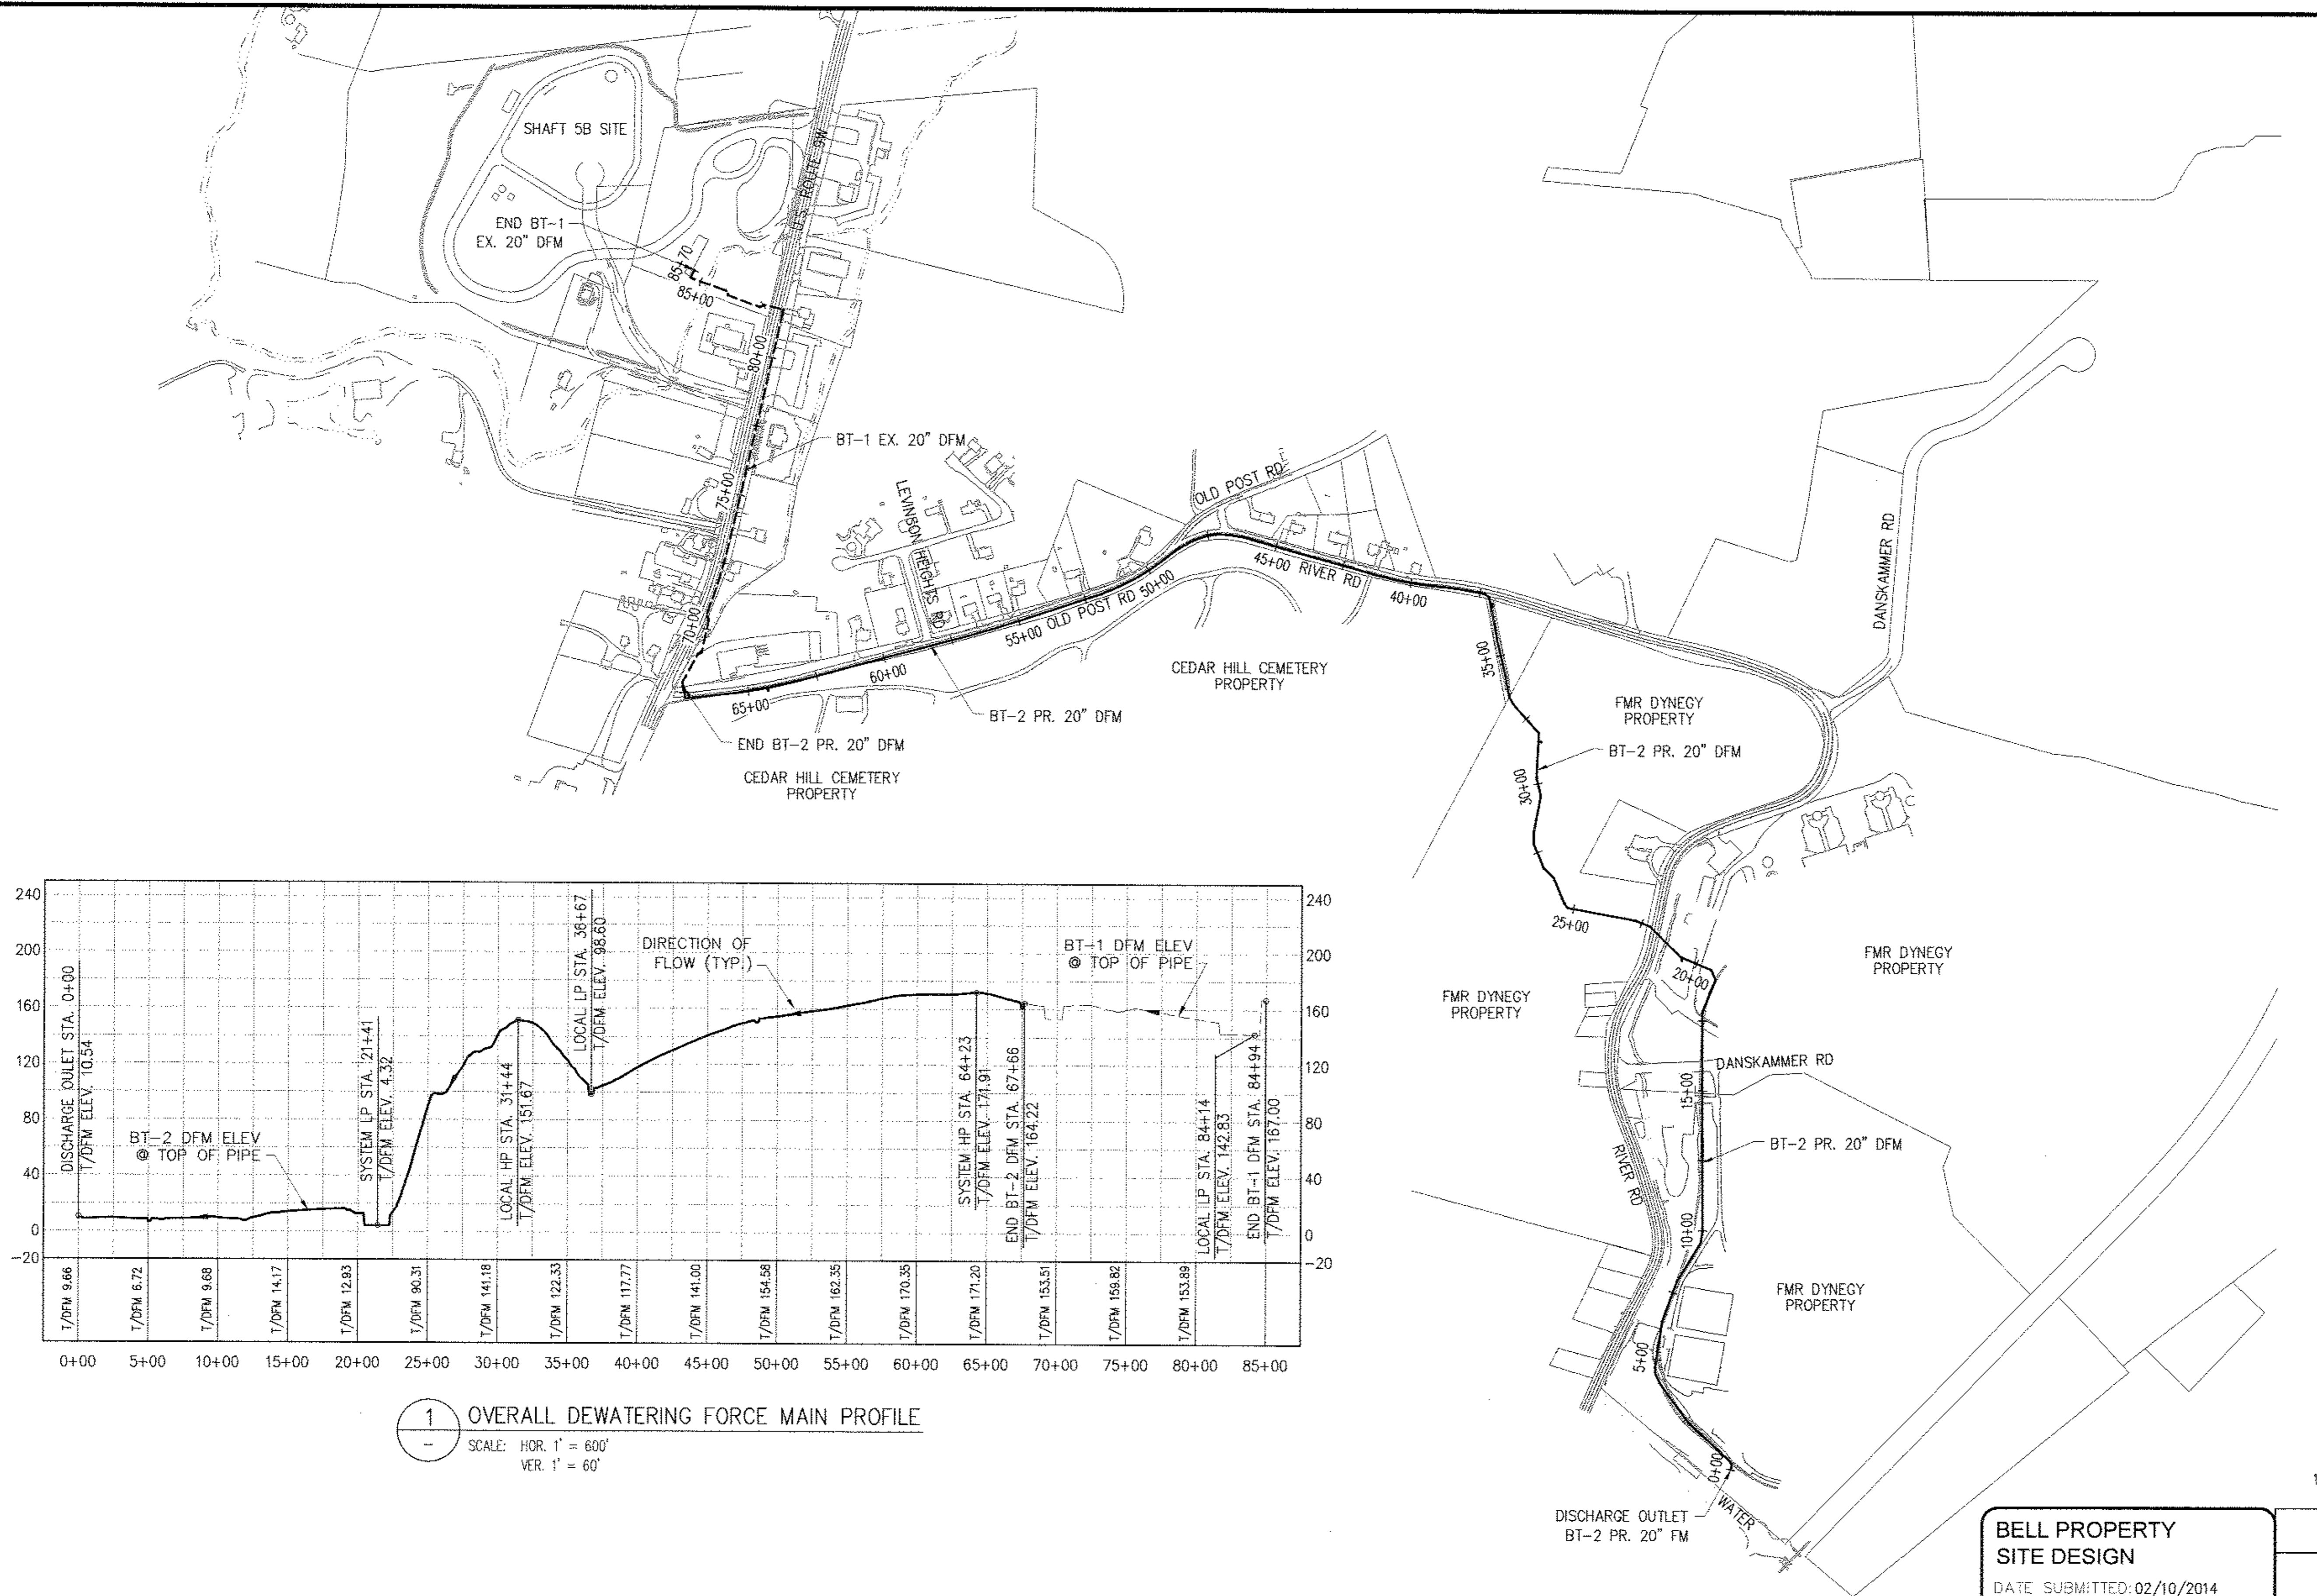BELL PROPERTY
SITE DESIGN
DATE SUBMITTED: 02/10/2014

GRAPHIC SCALES
CHECK BEFORE USE

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SCALE ACCORDINGLY

DATE: 11/22/2013
SCALE: 1/8=1'-0"
SHEET NO:
1 OF 453
DRAWING NO.
FOMA-C-108.00

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CORONA, NEW YORK 11368
www.nyc.gov/dep

DATE: 11/22/2013
SCALE: 1/8=1'-0"
SHEET NO:
1 OF 453
DRAWING NO.
FOMA-C-108.00


| NO. | DATE | DESCRIPTION | APPR'D. |
|-----|------|-------------|---------|
| | | REVISIONS | FP |


| | |
|----------------------|--|
| DESIGNED BY: GM | DRAWN BY: CM |
| CHECKED BY: FP | Water Future Environmental Protection |
| DESIGN LEAD: GM | |
| SECTION CHIEF: FP | |




PROJECT MANAGER
TED DOWNEY
CHIEF, TUNNEL DESIGN
BURJOR KHARIVALA
DIRECTOR, IN-HOUSE DESIGN
PATRICK O'CONNOR

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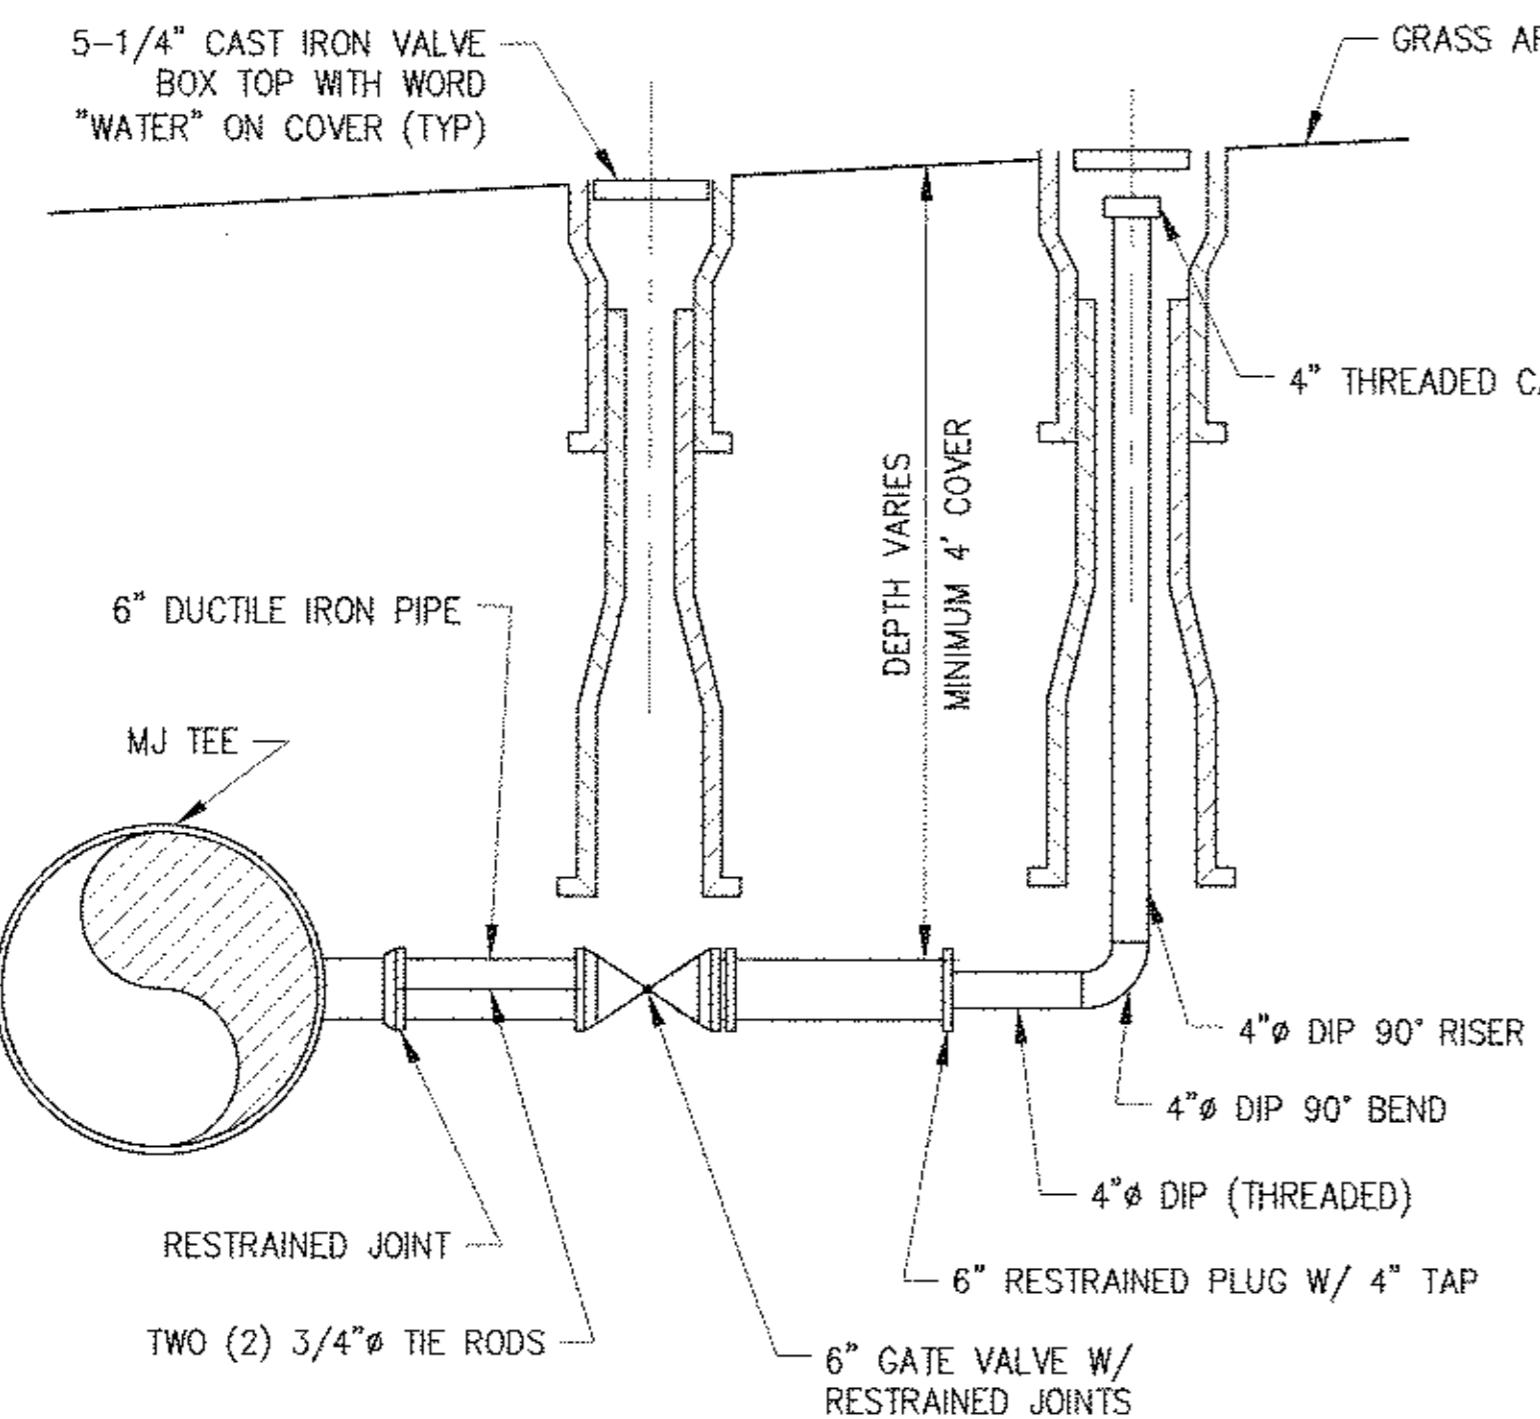


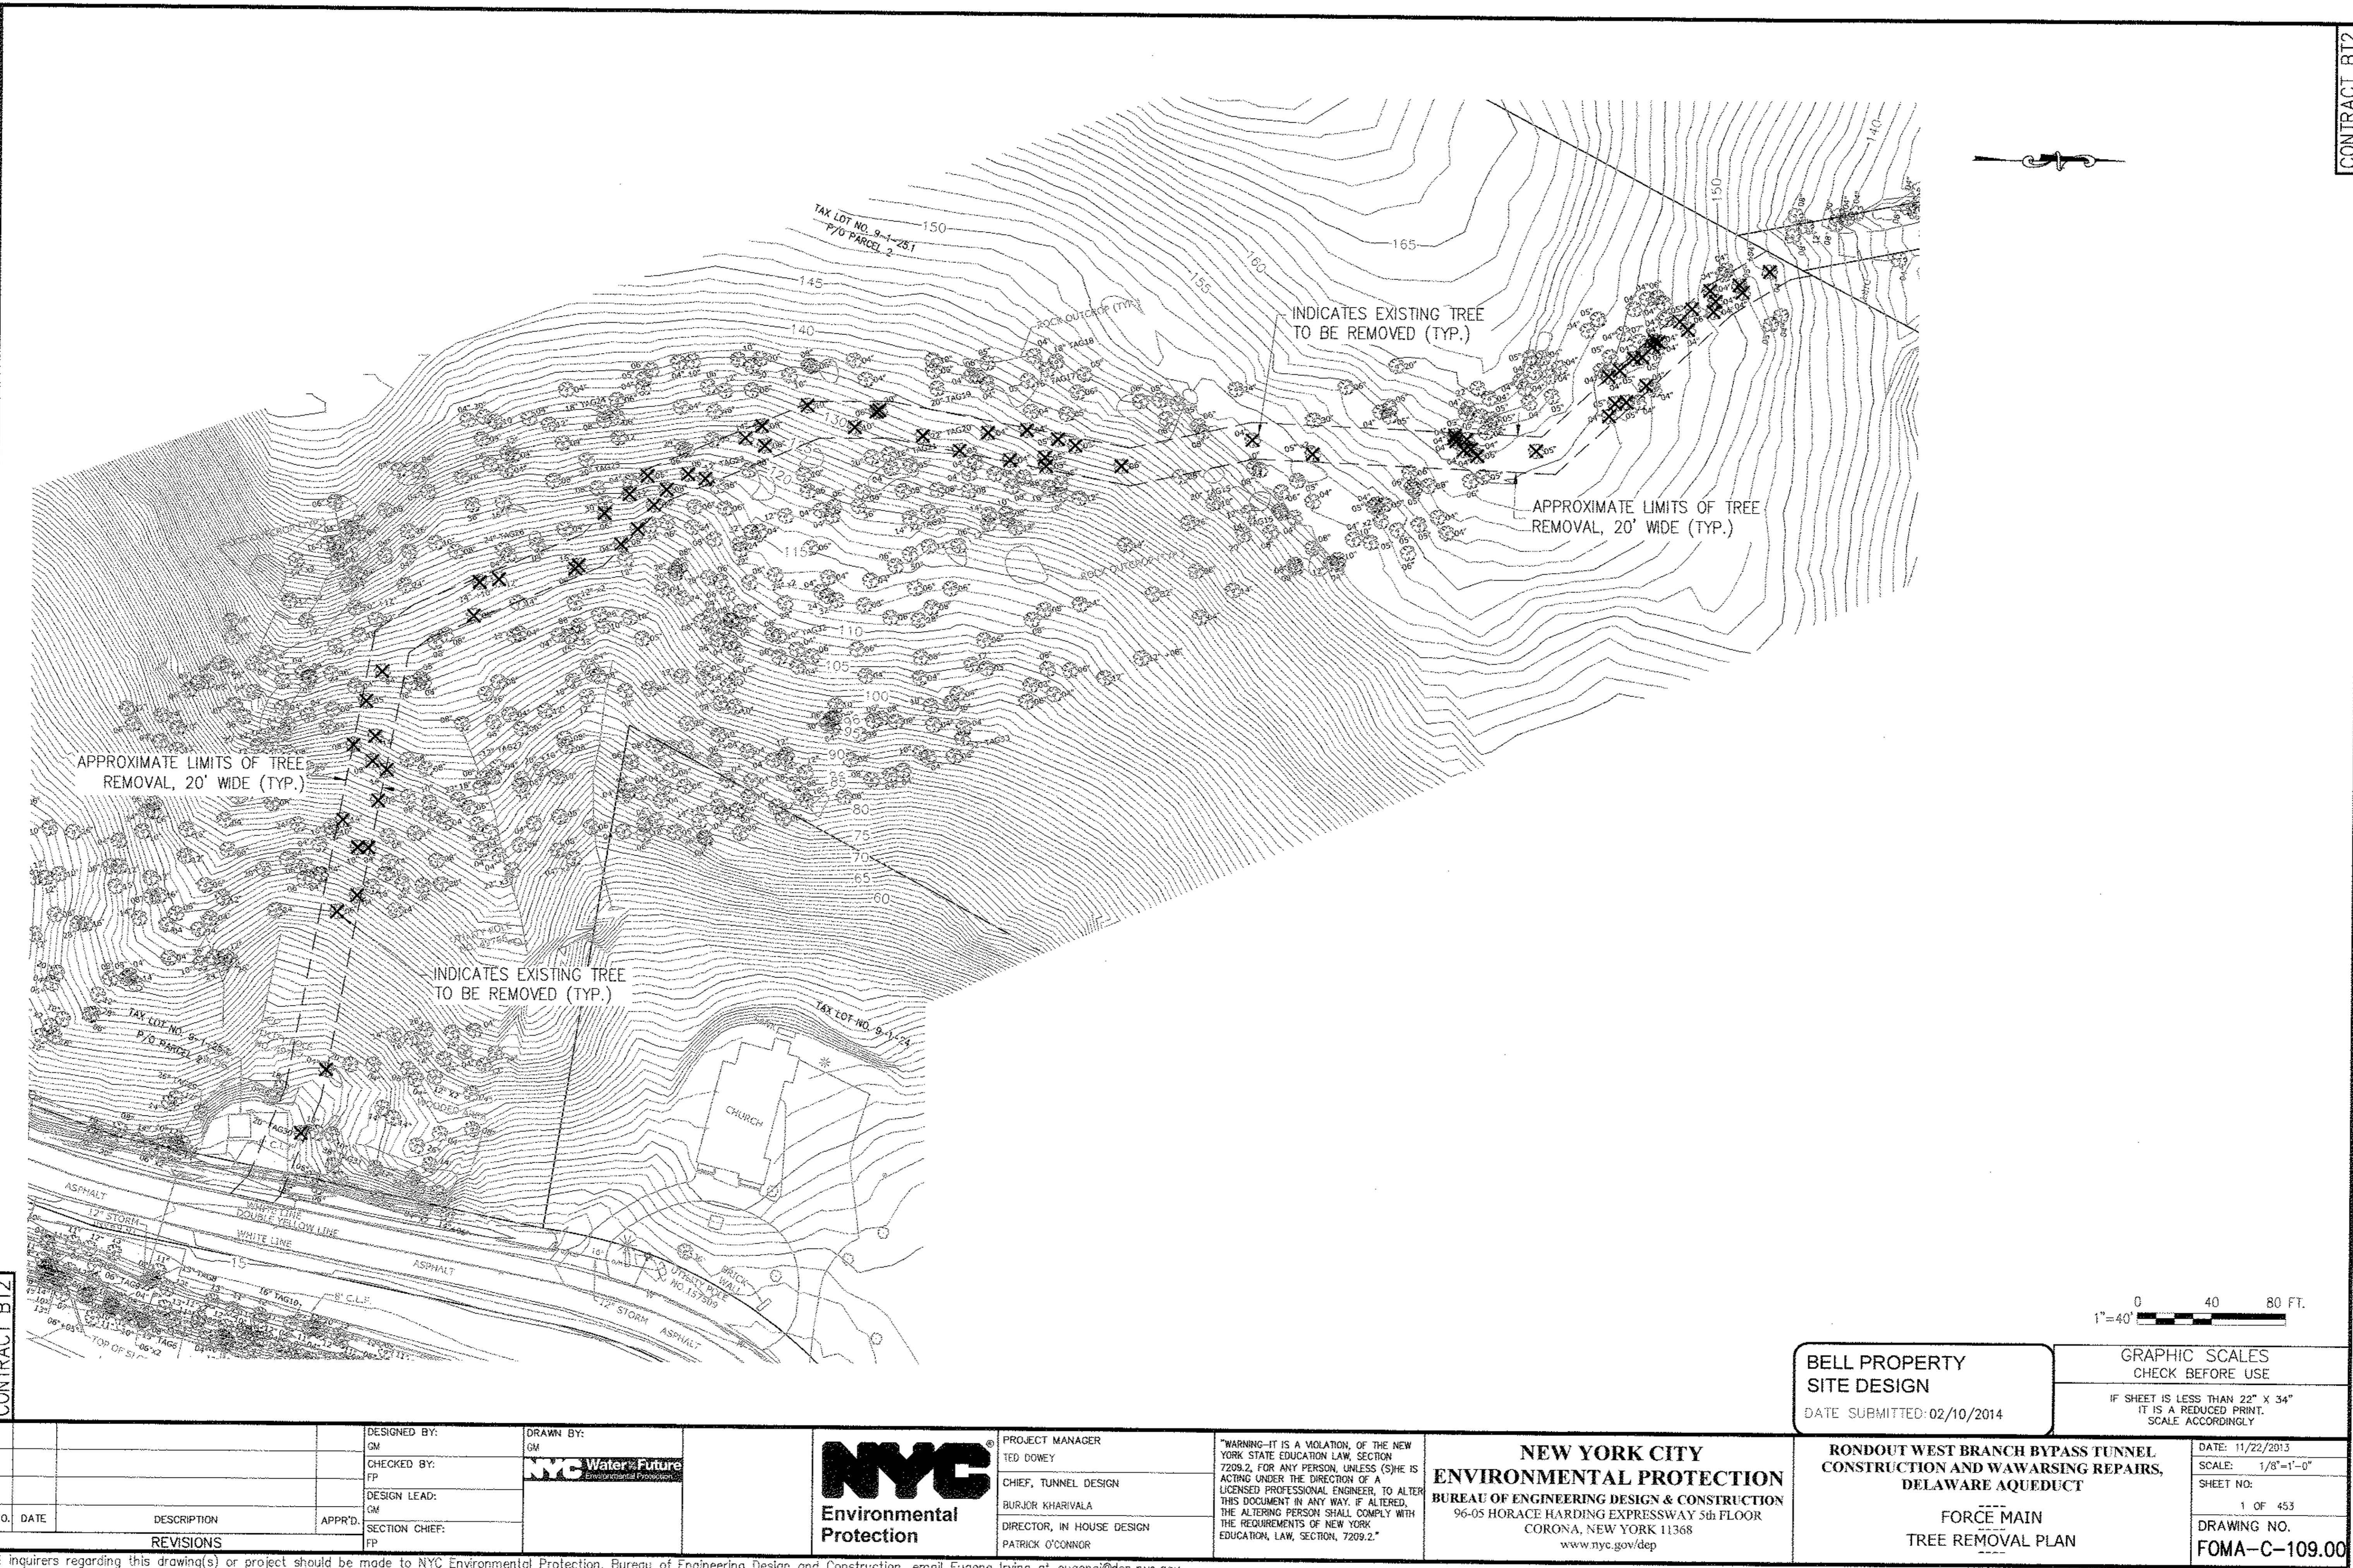

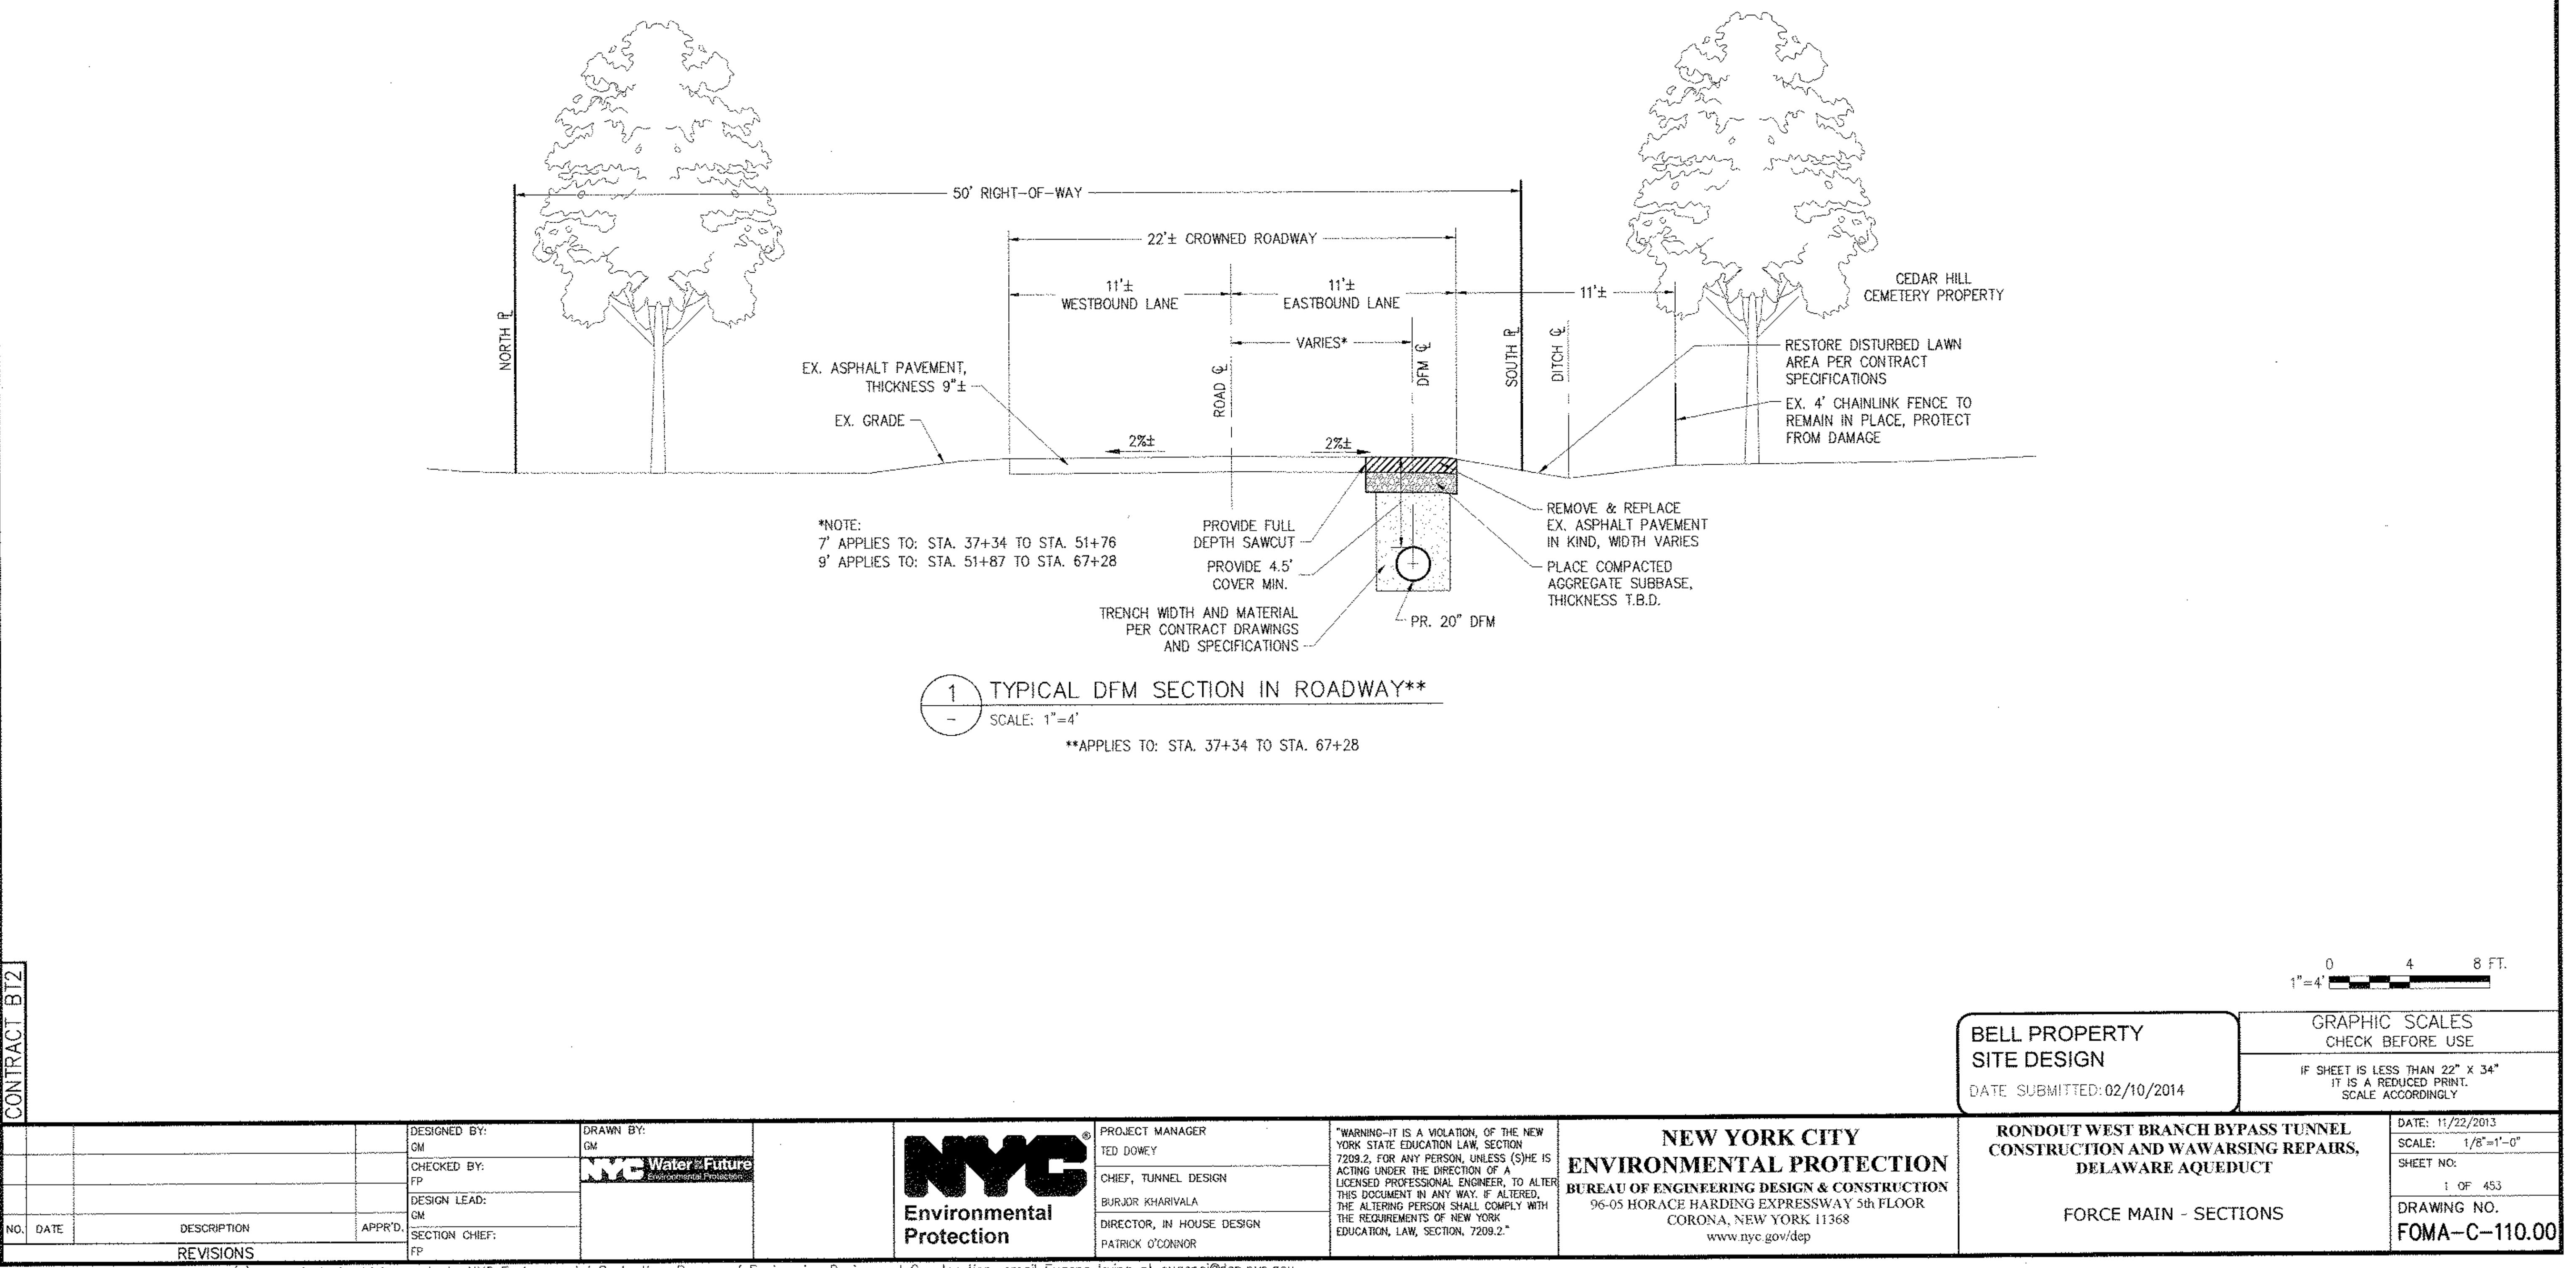

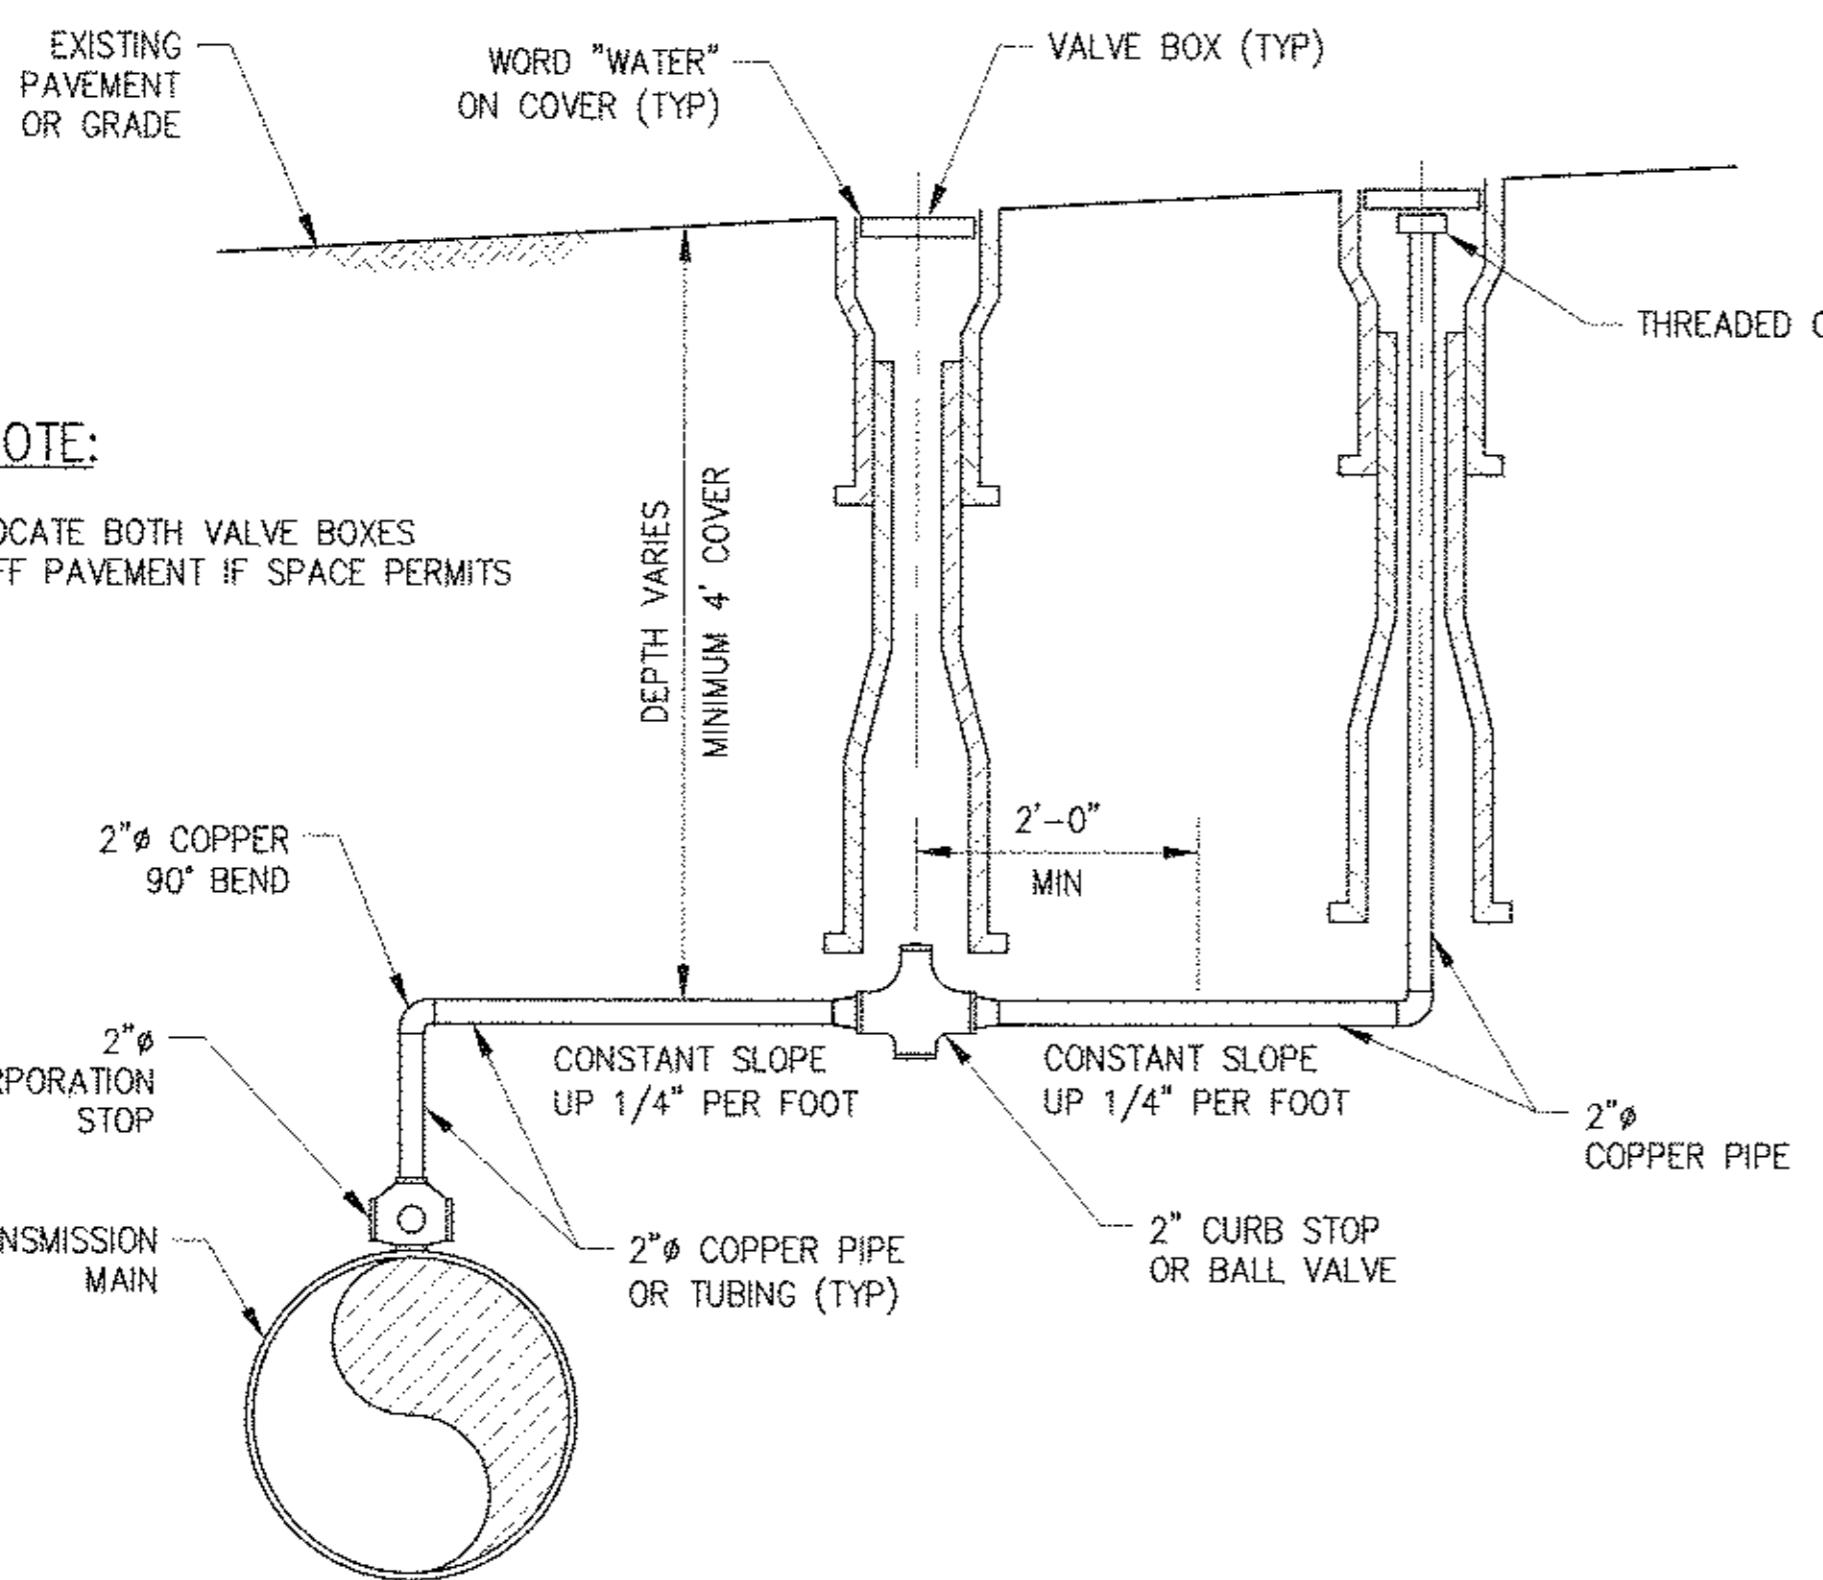101 AIR RELEASE ASSEMBLY DETAIL

SCALE: NTS




102 BLOW-OFF ASSEMBLY DETAIL

SCALE: NTS

FORCE MAIN NOTES

- THE CONTRACTOR IS RESPONSIBLE FOR NOTIFYING THE GAS COMPANY PRIOR TO CROSSING THE GAS MAIN. A REPRESENTATIVE OF THE GAS COMPANY SHALL BE PRESENT TO WITNESS THE COMPLETE UTILITY CROSSING.
- PIPING SHALL BE HYDROSTATICALLY TESTED IN ACCORDANCE WITH THE SPECIFICATIONS PRIOR TO FINAL APPROVAL.
- THRUST BLOCKS ARE NOT SHOWN ON PLAN AND PROFILE VIEWS FOR CLARITY PURPOSES. THRUST BLOCKS SHALL BE INSTALLED AS SPECIFIED AND IN ACCORDANCE WITH THE SCHEDULE PROVIDED ON GC-XXX.
- RESTRAINING LENGTHS ARE NOT SHOWN ON THE PLAN AND PROFILE VIEWS FOR CLARITY PURPOSES. JOINT RESTRAINT SHALL BE PROVIDED IN ACCORDANCE WITH THE SPECIFICATIONS AND AS SHOWN ON THE SCHEDULE PROVIDED ON GC-XXX.
- VERTICAL BENDS ARE NOT SHOWN ON THE PLAN VIEW FOR CLARITY PURPOSES. REFER TO PROFILE VIEW FOR LOCATION OF ALL VERTICAL BENDS TO BE INSTALLED.
- THE CONTRACTOR SHALL REFER TO 5C-XXX FOR WORK ZONE TRAFFIC CONTROL REQUIREMENTS.
- AS TRENCHES ARE BACKFILLED AND COMPAKTED, THE CONTRACTOR IS TO STABILIZE THE SURFACE WITH PAVEMENT SUBBASE OR TOPSOIL AND SEED, AS REQUIRED.
- PROVIDE MINIMUM VERTICAL DISTANCE OF 18-INCHES BETWEEN OUTSIDE OF DEWATERING FORCE MAIN AND OUTSIDE OF POTABLE WATER MAIN OR GAS MAIN. WHERE NOT POSSIBLE, PROVIDE CONCRETE ENCASEMENT IN ACCORDANCE WITH THE SPECIFICATIONS.
- THE CONTRACTOR SHALL FURNISH AND INSTALL STEEL SHEETING AT THE PERIMETER OF THE JACKING AND RECEIVING PITS TO STABILIZE THE PIT WALLS. THE PITS LOCATED IN THE RIVER ROAD R.O.W. ARE TO BE PROTECTED IN ACCORDANCE WITH APPLICABLE RULES AND REGULATIONS. THE PITS LOCATED IN PRIVATE PROPERTY ARE TO BE PROTECTED WITH CONCRETE BARRIERS AT NO ADDITIONAL COST TO THE OWNER.
- FOR THE WORK REQUIRING EASEMENTS FROM PROPERTY OWNERS, THE CONTRACTOR IS TO MAINTAIN VEHICULAR ACCESS TO ALL BUILDINGS ON THE PROPERTY OWNER'S SITE. THIS INCLUDES CLEAR AND ADEQUATE ACCESS FOR LARGER VEHICLES AND DELIVERY TRUCKS. THE CONTRACTOR WILL BE REQUIRED TO MOVE EQUIPMENT AT THE REQUEST OF THE PROPERTY OWNER TO ALLOW VEHICULAR TRAFFIC THROUGH THE PROPERTY OWNER'S SITE. ALL WORK BLOCKING DRIVeways AND/OR SITE ENTRANCES SHALL BE STAGED TO MAINTAIN AT MINIMUM ONE-HALF OF THE SITE ENTRANCE OR AMPLE ROOM FOR LARGE VEHICLES TO ENTER THE SITE, WHICHEVER IS GREATER.
- ANY EXCAVATION WITHIN THE RIGHT-OF-WAY WHICH EXCEEDS FIVE FEET IN DEPTH AND HAS LIVE TRAFFIC OR UTILITIES WITHIN A 1V:1H PROJECTION FROM THE BOTTOM OF THE EXCAVATION SHALL UTILIZE A SHEETING/SHORING SYSTEM WHICH PROVIDES DIRECT CONTACT AND SUPPORT OF THE EXCAVATION SIDES. REFER TO THE SPECIFICATIONS FOR EXCAVATION SUPPORT REQUIREMENTS.

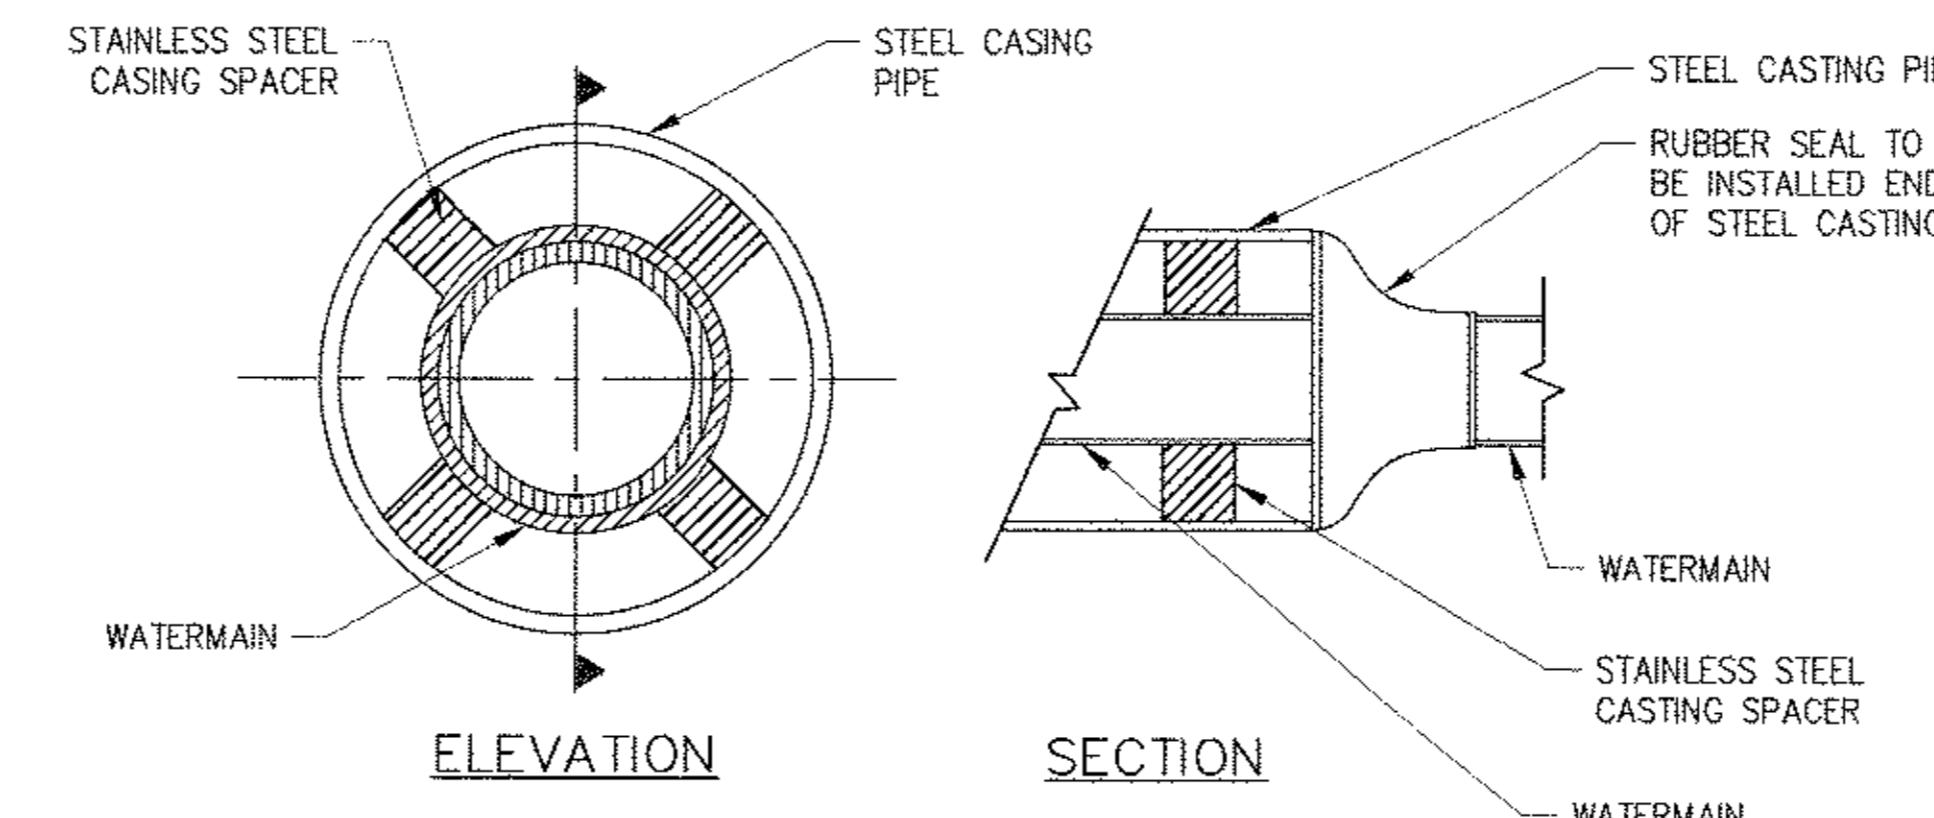

103 STEEL CASING SLEEVE DETAILS

SCALE: NTS

BELL PROPERTY
SITE DESIGN

DATE SUBMITTED: 02/10/2014

GRAPHIC SCALES
CHECK BEFORE USE


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RONDOUT WEST BRANCH BYPASS TUNNEL
CONSTRUCTION AND WAWARSING REPAIRS,
DELAWARE AQUEDUCT

FORCE MAIN - NOTES & DETAILS


DATE: 11/22/2013
SCALE: 1/8"=1'-0"
SHEET NO:
1 OF 453
DRAWING NO.
FOMA-C-111.00

Last Saved By & Date: Eugene, Tuesday, February 04, 2014 and Date Plotted: Tuesday, February 04, 2014
 Paper Size: ANSI D (34.00 x 22.00 inches) Plot Scale: 1:1 Plot Style Table: BDC_22x34_Full_Size.ctb
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UTILITY CROSSING SCHEDULE

| NAME | STATION | DESCRIPTION | DFM ELEVATION | CROSSING ELEVATION |
|------|---------|-----------------|---------------|--------------------|
| A | 0+80 | UNK UTILITY | T/P 9.13 | VERIFY IN FIELD |
| B | 0+82 | UNK UTILITY | T/P 9.14 | VERIFY IN FIELD |
| C | 1+80 | 12" STORM DRAIN | T/P 9.51 | B/P 12.34± (VIF) |
| D | 2+60 | UNK UTILITY | T/P 9.59 | VERIFY IN FIELD |
| E | 3+74 | UNK UTILITY | T/P 8.92 | VERIFY IN FIELD |
| F | 4+58 | UNK UTILITY | T/P 8.68 | VERIFY IN FIELD |
| G | 5+08 | UNK ELECTRICAL | T/P 6.72 | VERIFY IN FIELD |
| H | 5+44 | 4" STORM DRAIN | T/P 8.78 | B/P 10.50± (VIF) |
| I | 6+01 | UNK WATER MAIN | T/P 8.21 | VERIFY IN FIELD |
| J | 6+11 | UNK UTILITY | T/P 8.43 | VERIFY IN FIELD |
| K | 6+13 | UNK ELECTRICAL | T/P 8.52 | VERIFY IN FIELD |

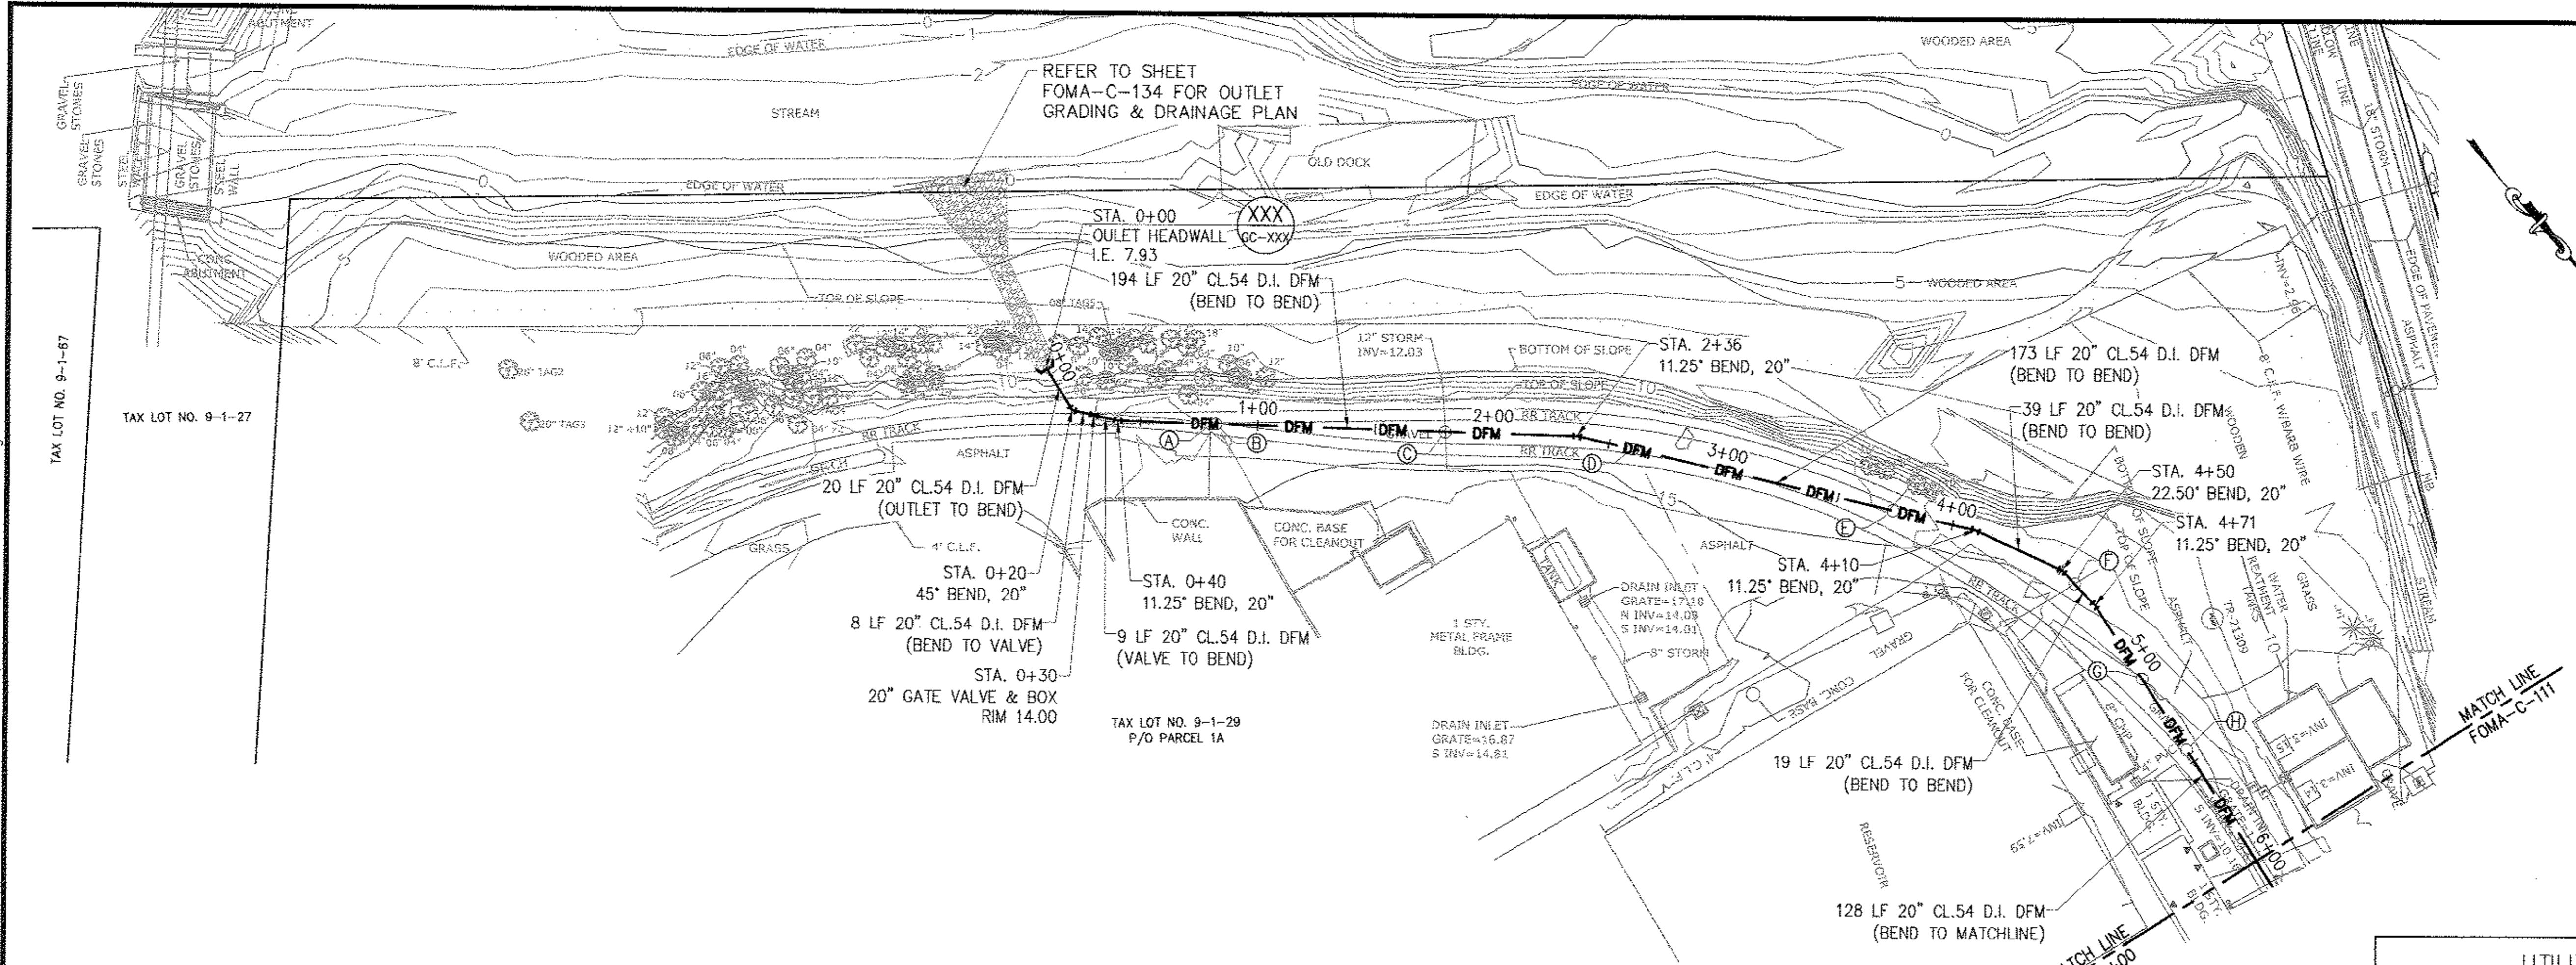

BELL PROPERTY SITE DESIGN

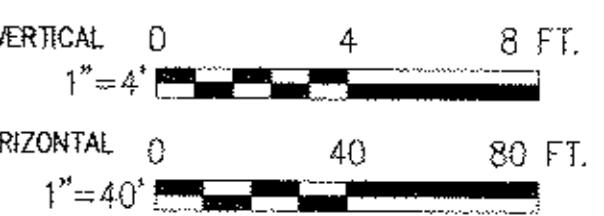DATE SUBMITTED: 02/10/2014

GRAPHIC SCALES
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RONDOUT WEST BRANCH BYPASS TUNNEL
CONSTRUCTION AND WAWARSING REPAIRS,
DELAWARE AQUEDUCT
FORCE MAIN
PIPING PLAN & PROFILE
P.O.B TO STA 6+00
FOMA-C-112.00

DATE: 11/22/2013


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SHEET NO:

1 OF 453


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GM
CHECKED BY:
FP
DESIGN LEAD:
GM
NO. DATE
DESCRIPTION APPR'D.
REVISIONS
SECTION CHIEF:
FP



DRAWN BY:
GM
NYC Water Future Environmental Protection

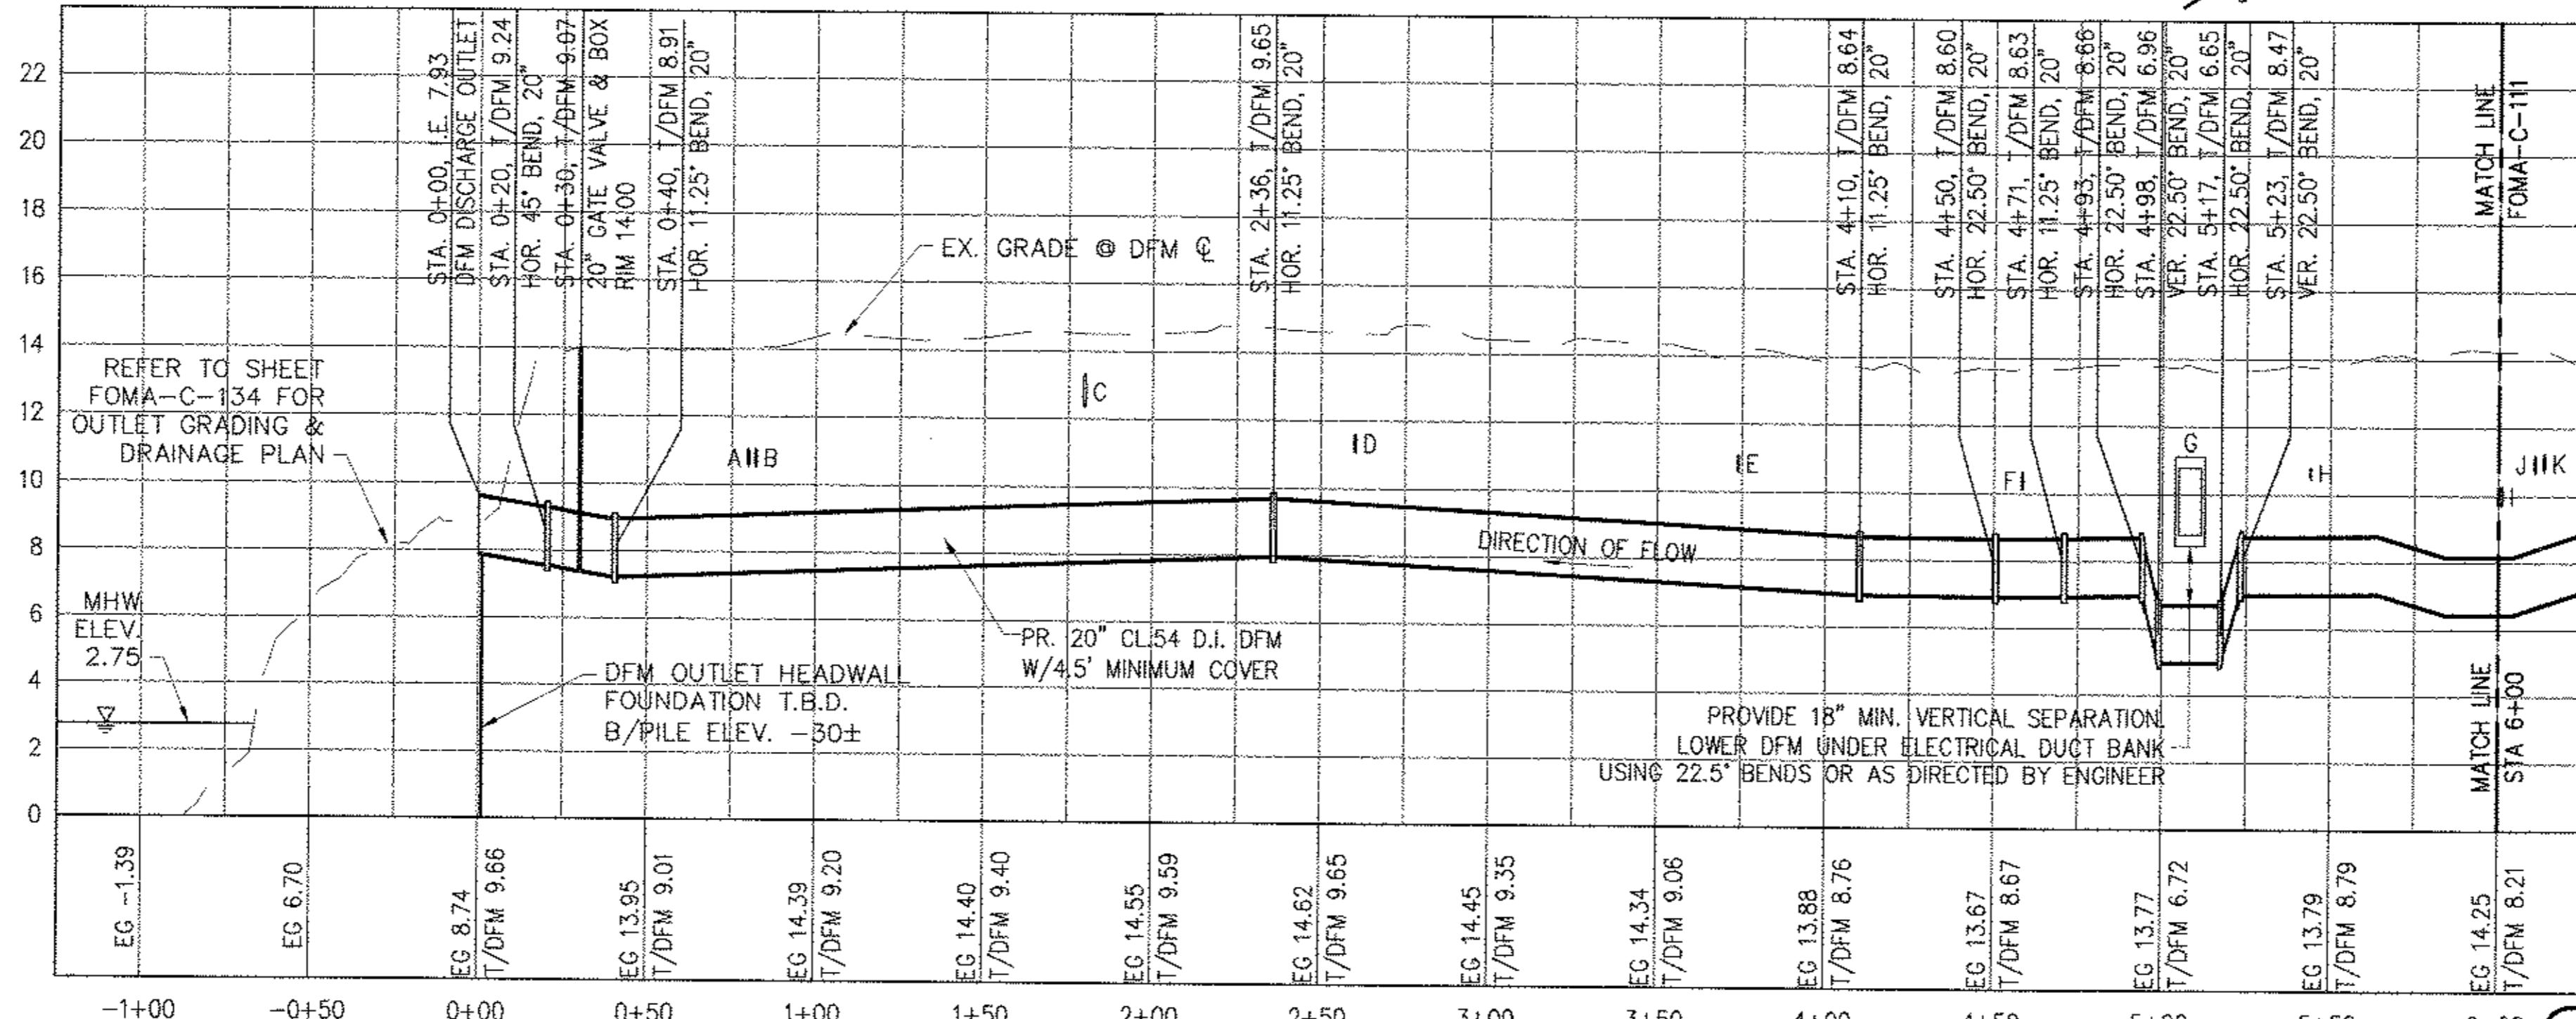

PROJECT MANAGER
TED DOWNEY
CHIEF, TUNNEL DESIGN
BURJAR KHARIVALA
DIRECTOR, IN-HOUSE DESIGN
PATRICK O'CONNOR

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| UTILITY CROSSING SCHEDULE | | | | |
|---------------------------|---------|-----------------|---------------|--------------------|
| NAME | STATION | DISCRIPTION | DFM ELEVATION | CROSSING ELEVATION |
| I | 6+01 | UNK WATER MAIN | T/P 8.21 | VERIFY IN FIELD |
| J | 6+11 | UNK UTILITY | T/P 8.43 | VERIFY IN FIELD |
| K | 6+13 | UNK ELECTRICAL | T/P 8.52 | VERIFY IN FIELD |
| L | 7+75 | 12" STORM DRAIN | T/P 9.52 | B/P 11.50± (VIF) |
| M | 8+66 | 6" STORM DRAIN | T/P 9.56 | B/P 12.84± (VIF) |
| N | 8+90 | 36" STORM DRAIN | B/P 7.82 | T/P 7.48± (VIF) |
| O | 11+94 | UNK WATER MAIN | T/P 7.74 | VERIFY IN FIELD |

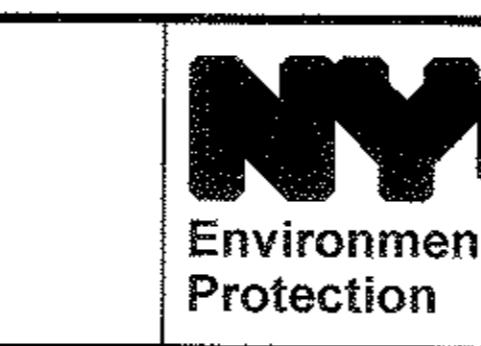VERTICAL 0 4 8 FT.
1"=4'
HORIZONTAL 0 40 80 FT.
1"=40'

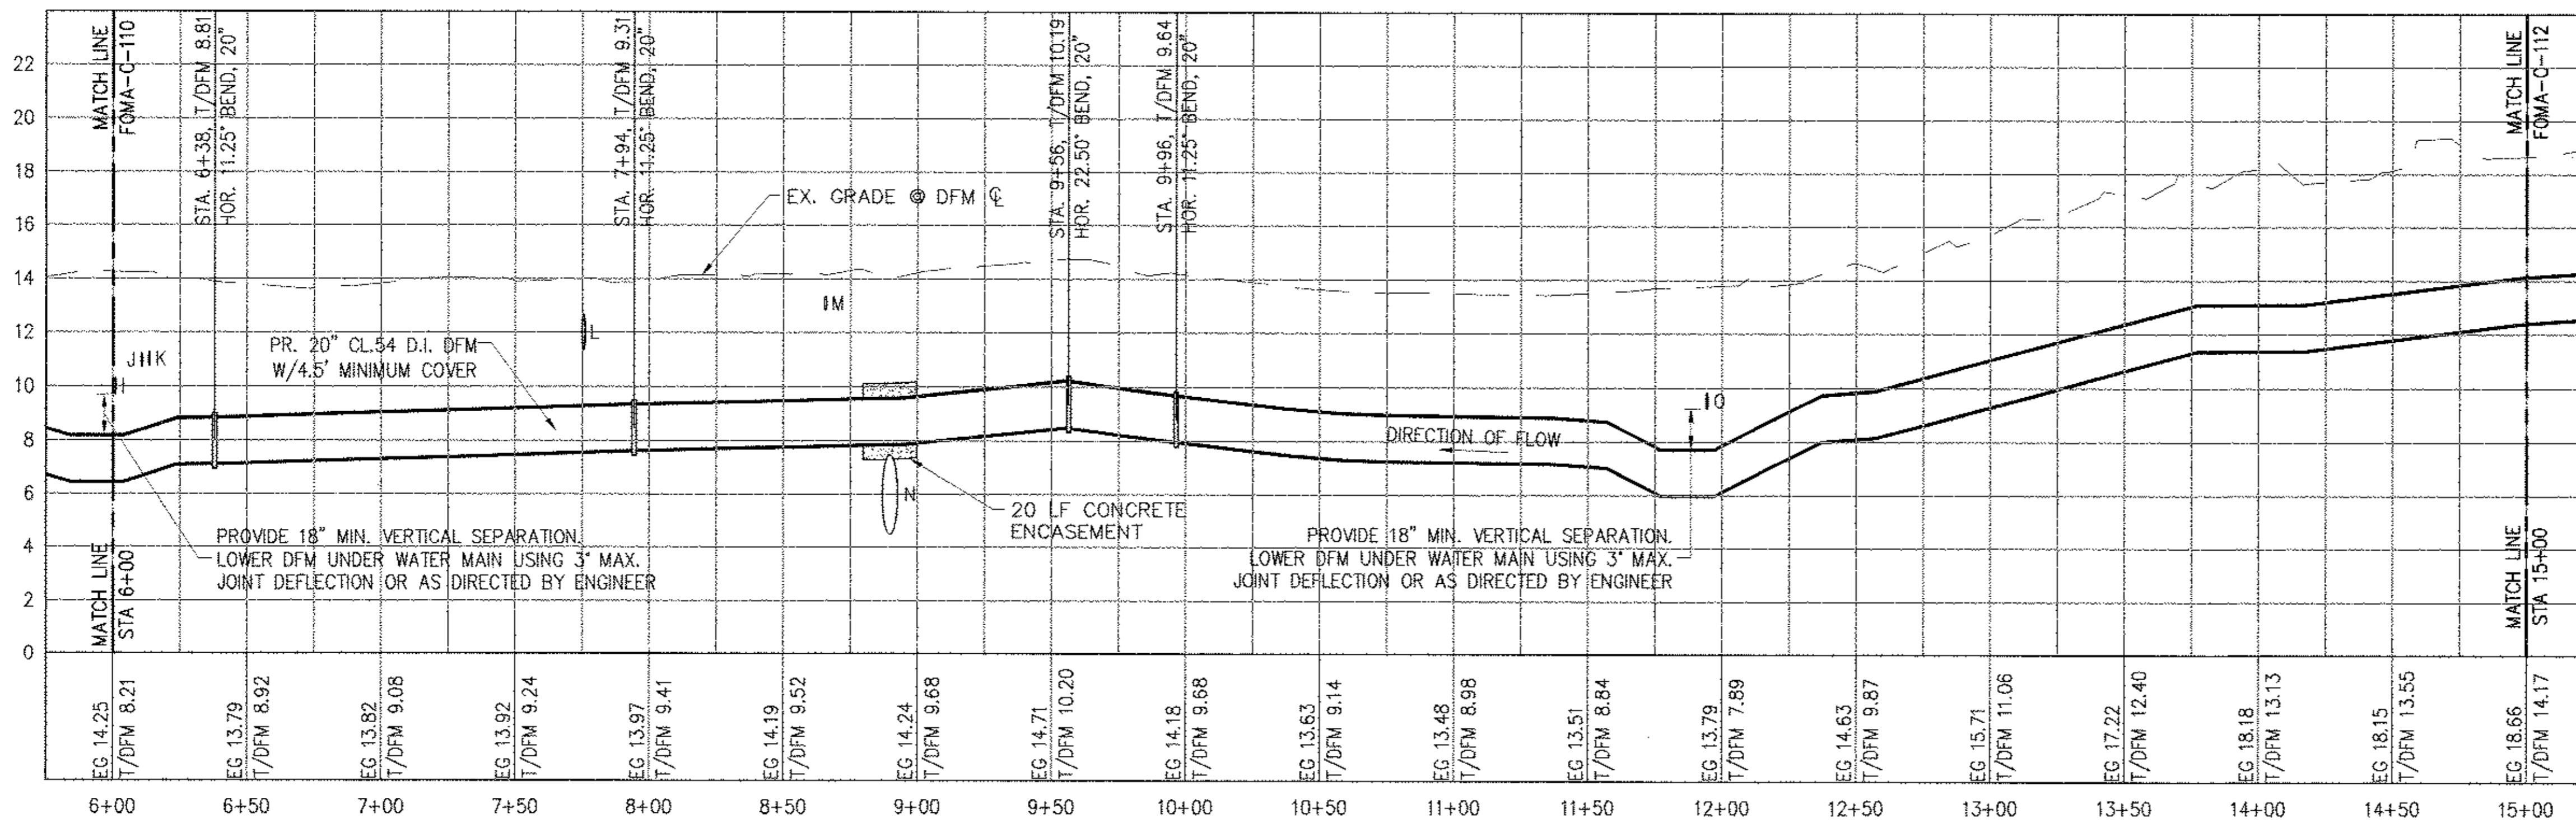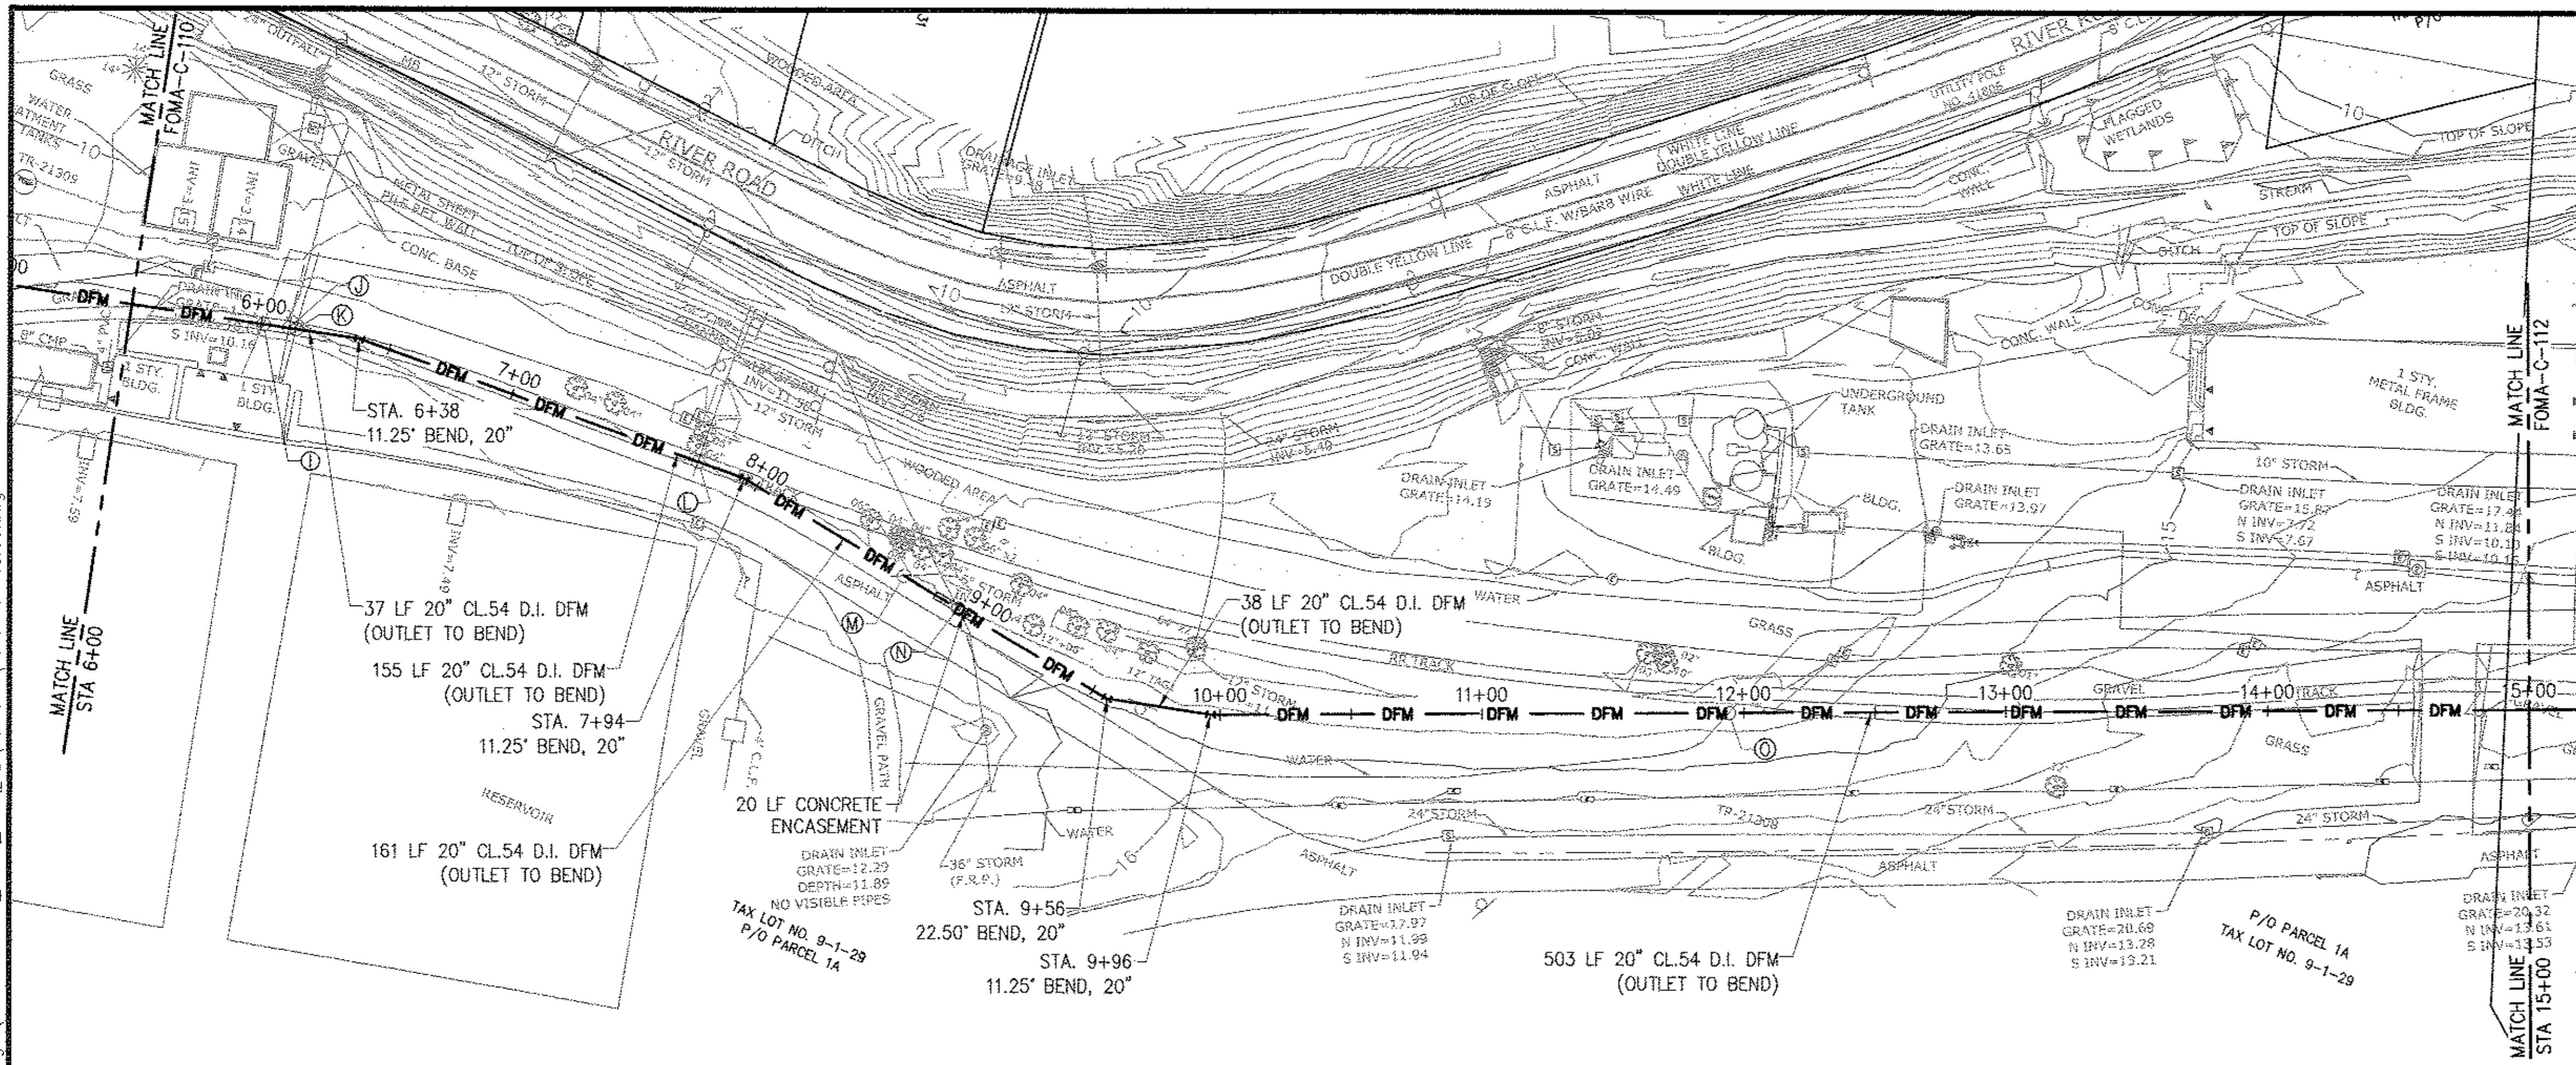BELL PROPERTY SITE DESIGN


DATE SUBMITTED: 02/10/2014

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SCALE ACCORDINGLY

| Last Saved By & Date | Paper Size: ANSI D (340mm x 470mm) | Drawing Name: & Location |
|----------------------|------------------------------------|--------------------------|
| NO. | DATE | DESCRIPTION |
| REVISIONS | | |

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| | DESIGNED |
| | GM |
| | CHECKED |
| | FP |
| | DESIGN LE |
| | GM |
| APPR'D. | SECTION C |
| | FP |

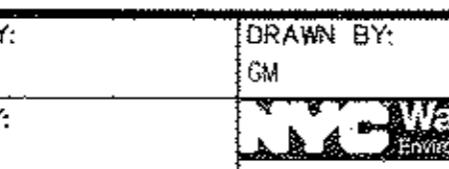


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|---|---|
|  | PROJECT MANAG TED DOWEY CHIEF, TUNNEL <hr/> BURJOR KHARIVALE <hr/> DIRECTOR, IN H <hr/> PATRICK O'CONNOR |
|---|---|

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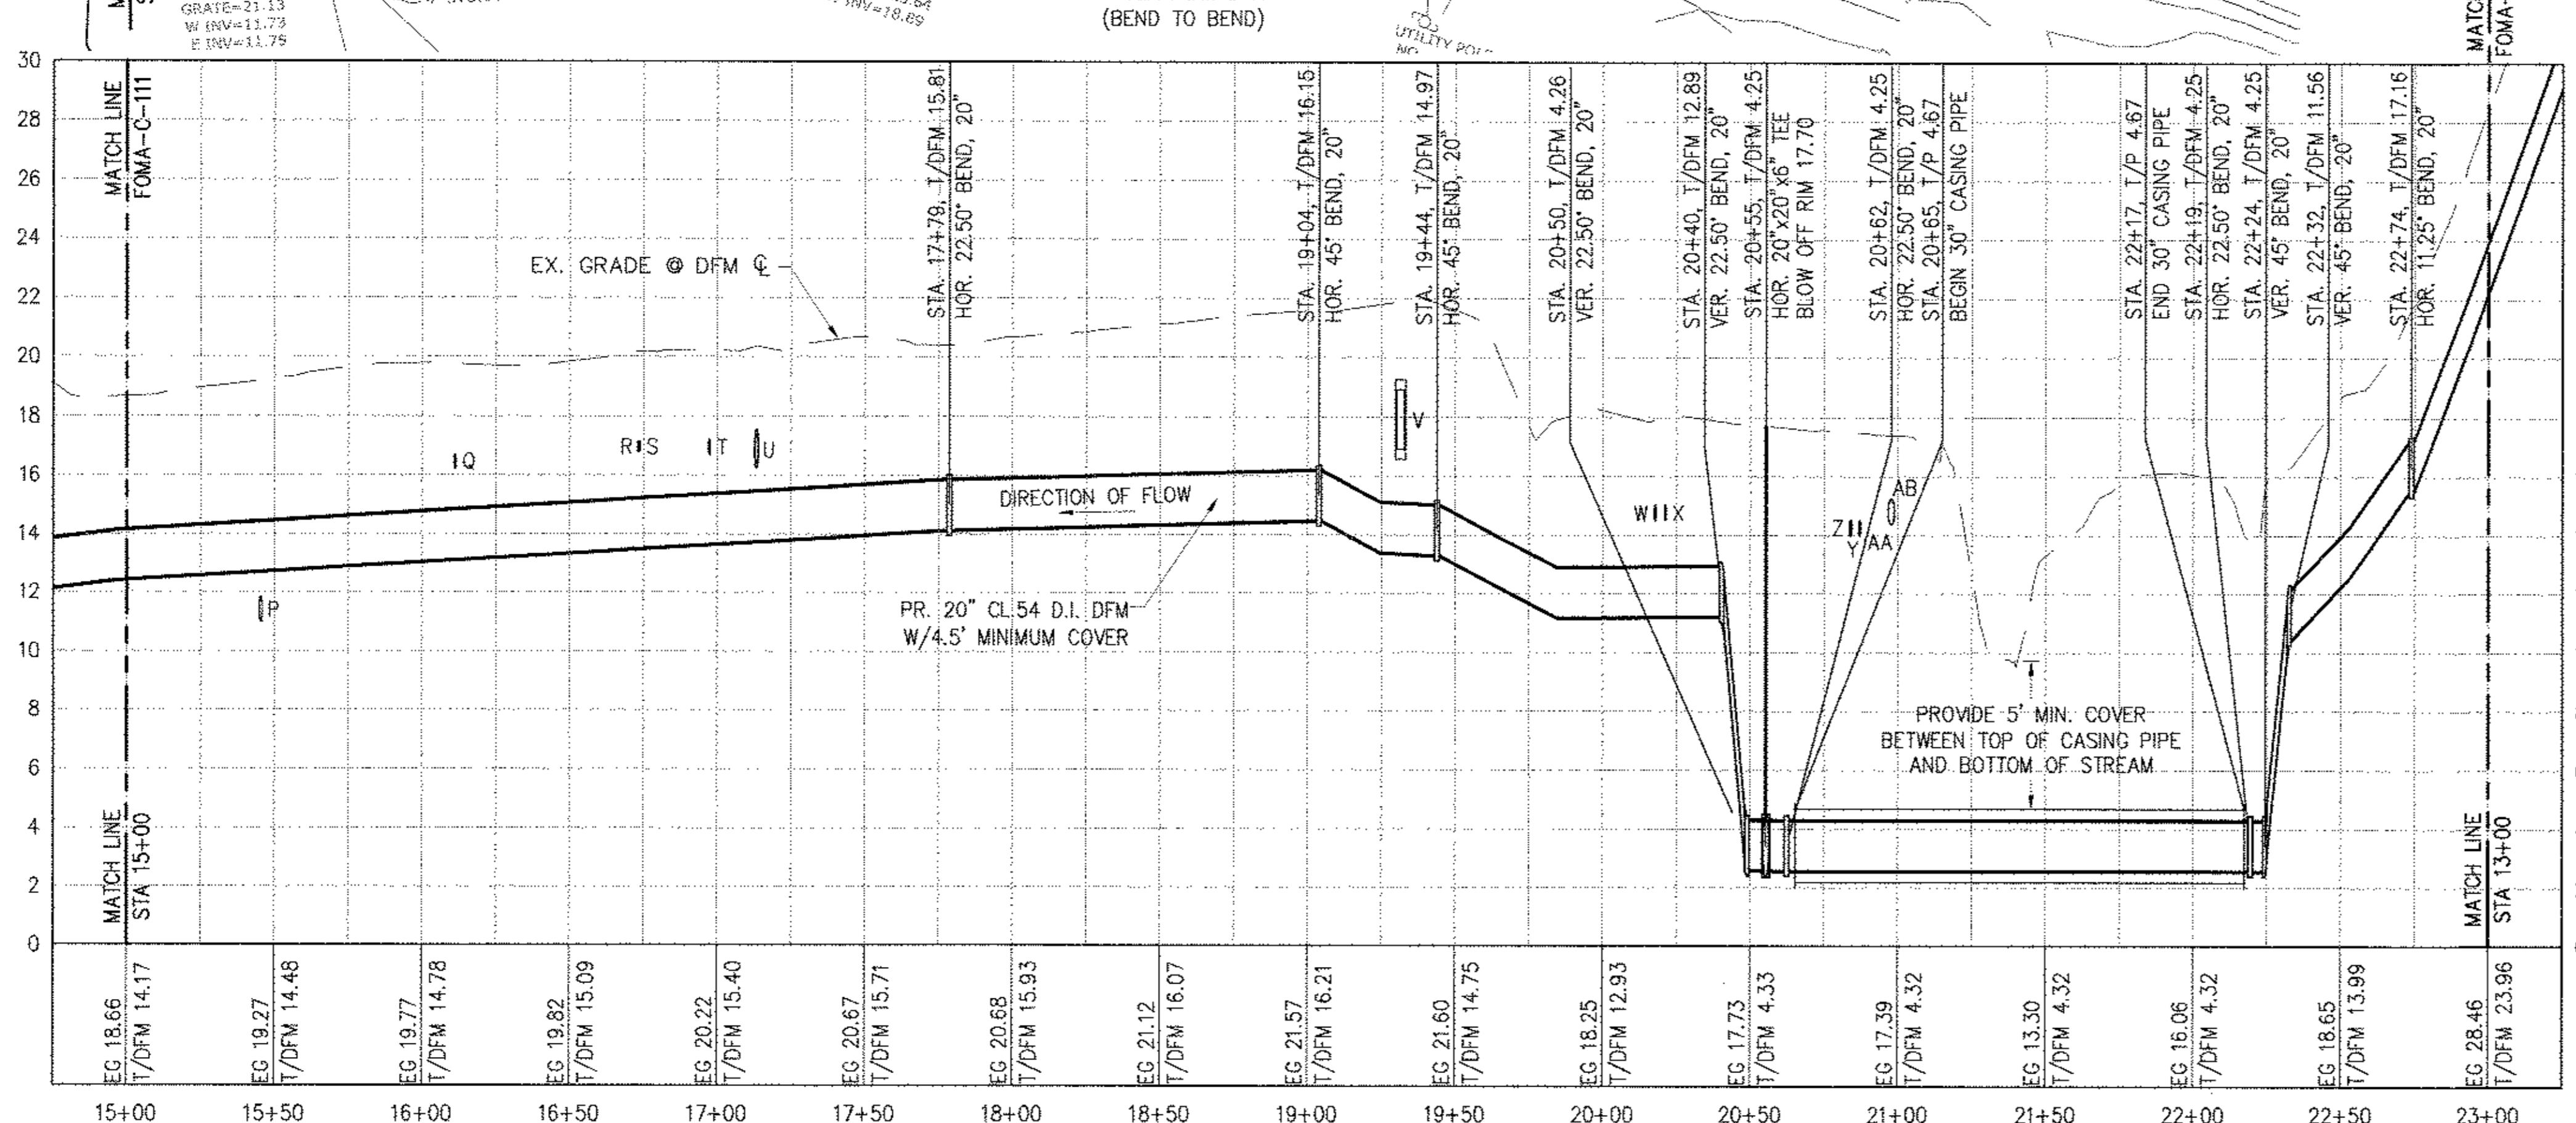
**NEW YORK CITY
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96-05 HORACE HARDING EXPRESSWAY 5th FLOOR
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www.nyc.gov/dep

**RONDOUT WEST BRANCH BYPASS TUNNEL
CONSTRUCTION AND WAWARSING REPAIRS,
DELAWARE AQUEDUCT
FORCE MAIN
PIPING PLAN & PROFILE
STA 6+00 TO STA 15+00**

DATE: 11/22/2013
SCALE: 1/8" = 1'-0"
SHEET NO.: 1 OF 453
DRAWING NO.: OMA-C-113.00

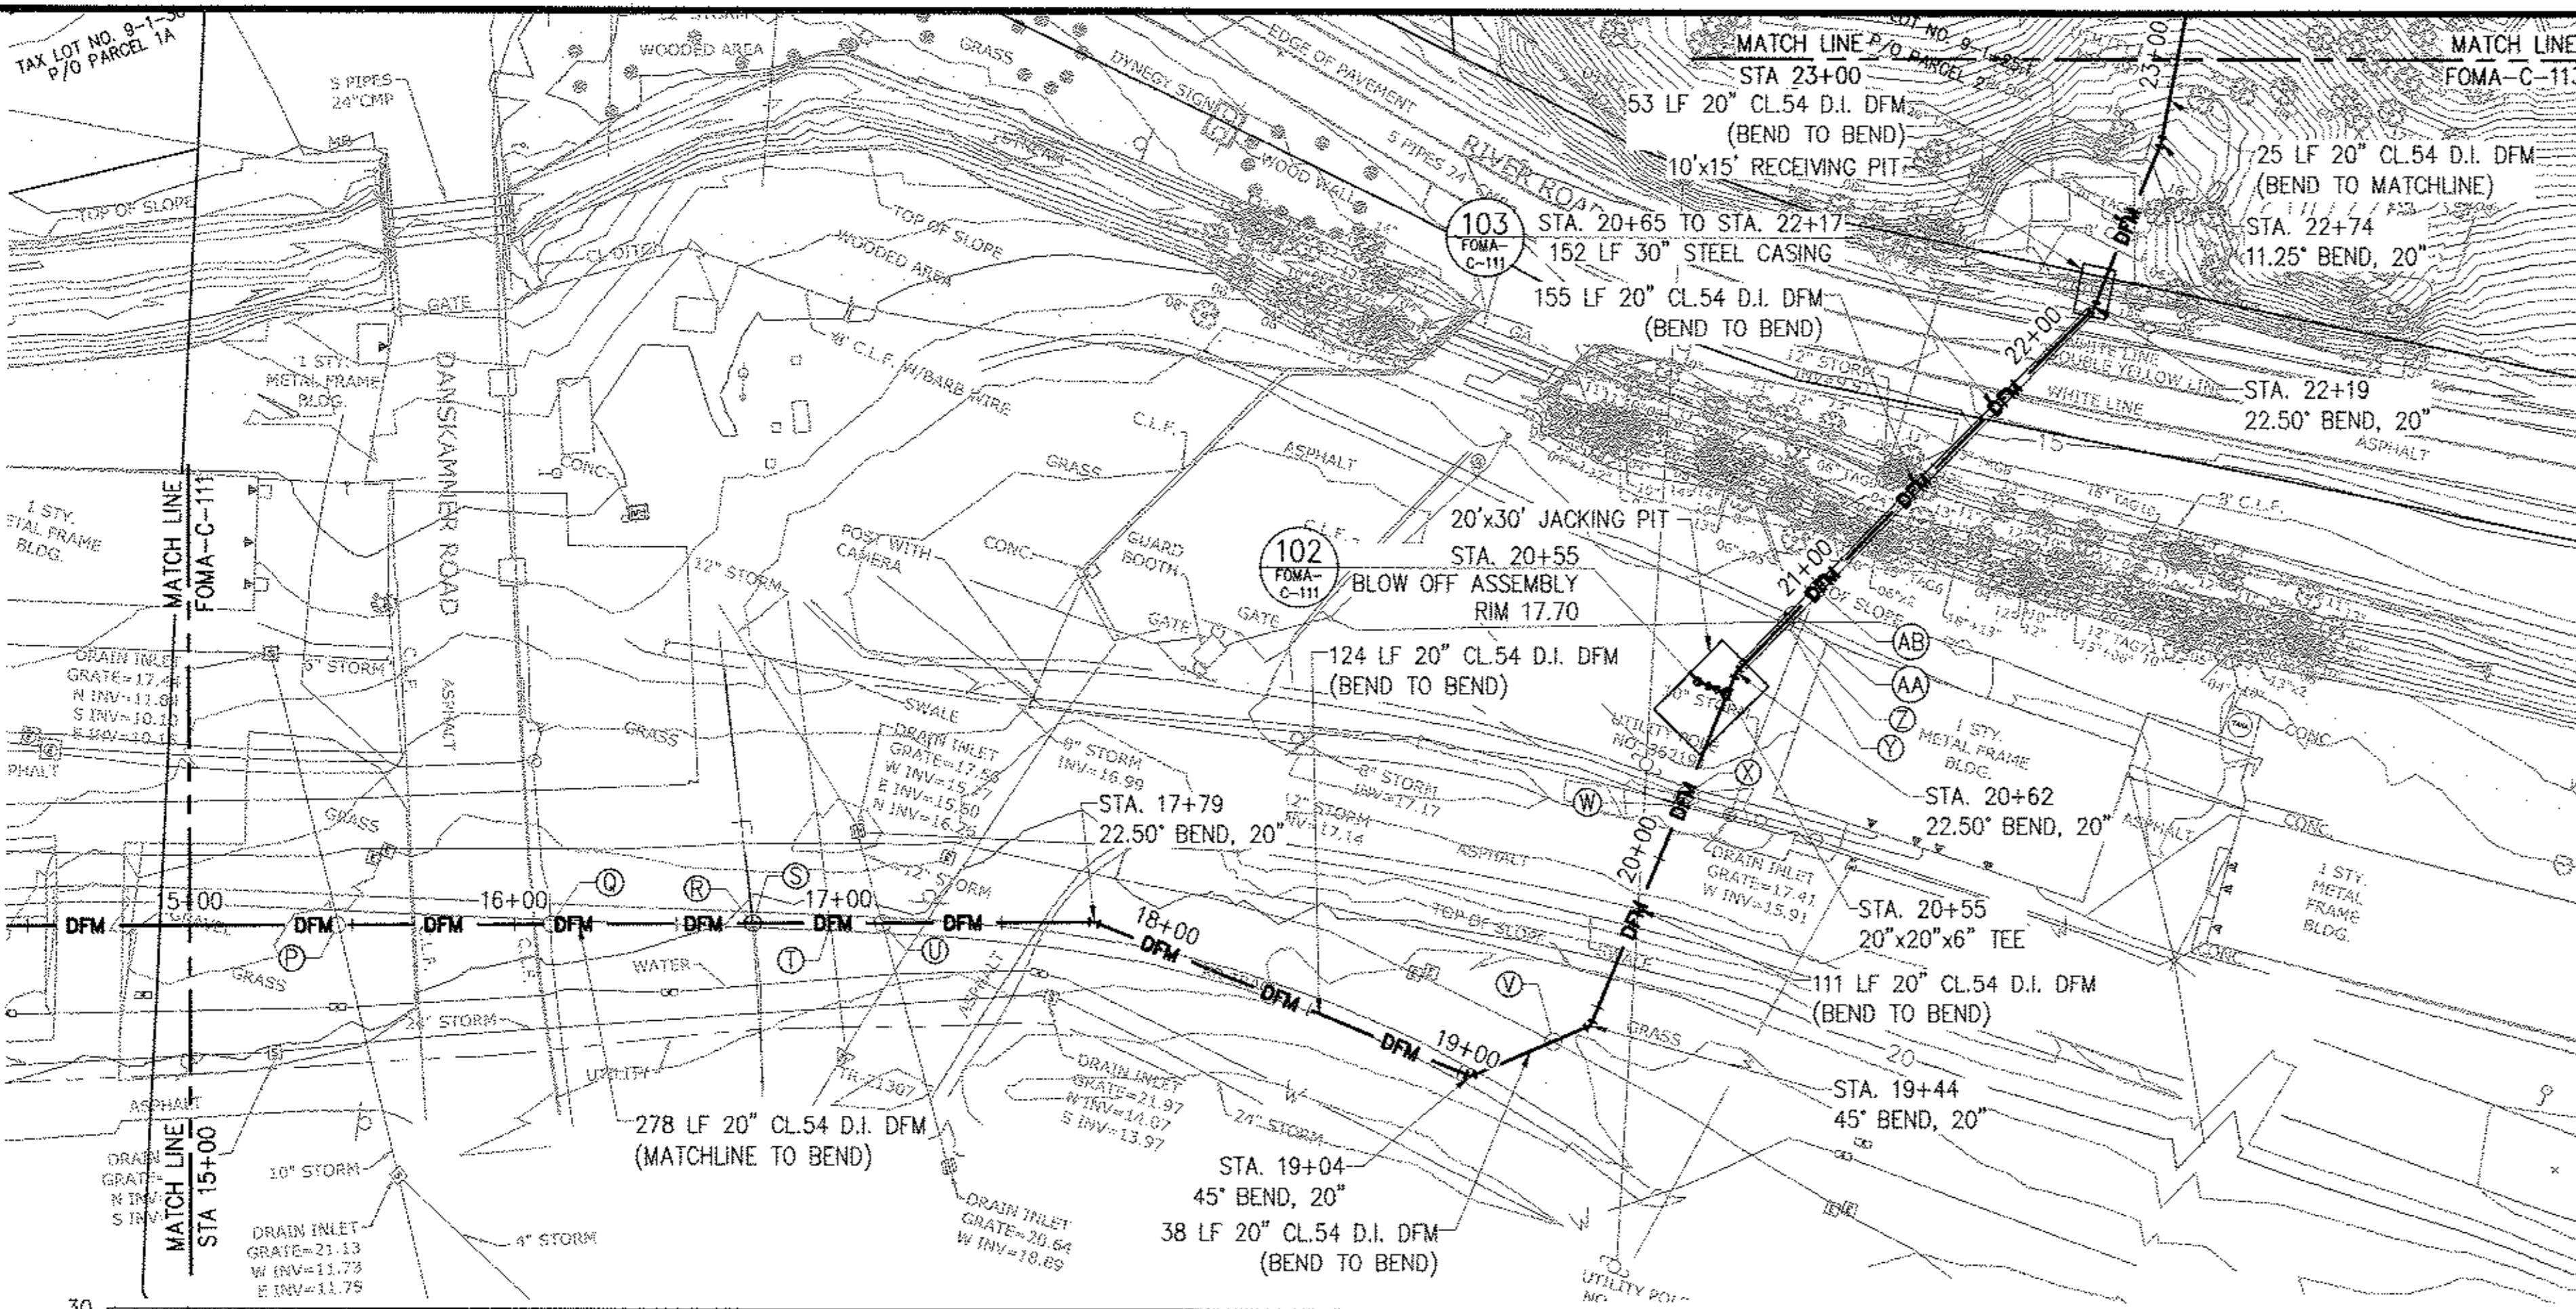


CONTRACT BT2



dwg

| UTILITY CROSSING SCHEDULE | | | | |
|---------------------------|---------|-----------------|---------------|--------------------|
| NAME | STATION | DESCRIPTION | DFM ELEVATION | CROSSING ELEVATION |
| P | 15+45 | 10" STORM DRAIN | B/P 12.65 | T/P 11.81± (VIF) |
| Q | 16+11 | UNK ELECTRICAL | T/P 14.85 | VERIFY IN FIELD |
| R | 16+73 | UNK ELECTRICAL | T/P 15.23 | VERIFY IN FIELD |
| S | 16+74 | UNK FIBER OPTIC | T/P 15.24 | VERIFY IN FIELD |
| T | 16+97 | UNK ELECTRICAL | T/P 15.38 | VERIFY IN FIELD |
| U | 17+13 | 12" STORM DRAIN | T/P 15.48 | B/P 16.40± (VIF) |
| V | 19+31 | UNK ELECTRICAL | T/P 15.10 | VERIFY IN FIELD |
| W | 20+18 | UNK ELECTRICAL | T/P 12.94 | VERIFY IN FIELD |
| X | 20+21 | UNK ELECTRICAL | T/P 12.95 | VERIFY IN FIELD |
| Z | 20+84 | UNK ELECTRICAL | T/P 4.25 | VERIFY IN FIELD |
| Y | 20+84 | UNK ELECTRICAL | T/P 4.25 | VERIFY IN FIELD |
| AA | 20+87 | UNK ELECTRICAL | T/P 4.25 | VERIFY IN FIELD |
| AB | 20+98 | 10" STORM DRAIN | T/P 4.25 | B/P 14.38± (VIF) |

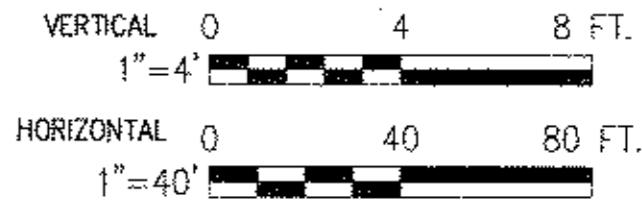

BELL PROPERTY
SITE DESIGN
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RONDOU WEST BRANCH BYPASS TUNNEL
CONSTRUCTION AND WAWARSING REPAIRS,
DELAWARE AQUEDUCT
FORCE MAIN
PIPING PLAN & PROFILE
STA 15+00 TO STA 24+00

DATE: 11/22/2013
SCALE: 1/8"=1'-0"
SHEET NO:
1 OF 453
DRAWING NO.
FOMA-C-114.00



PROJECT MANAGER
TED DONENY
CHIEF, TUNNEL DESIGN
BURJOR KHARIVALA
DIRECTOR, IN-HOUSE DESIGN
PATRICK O'CONNOR

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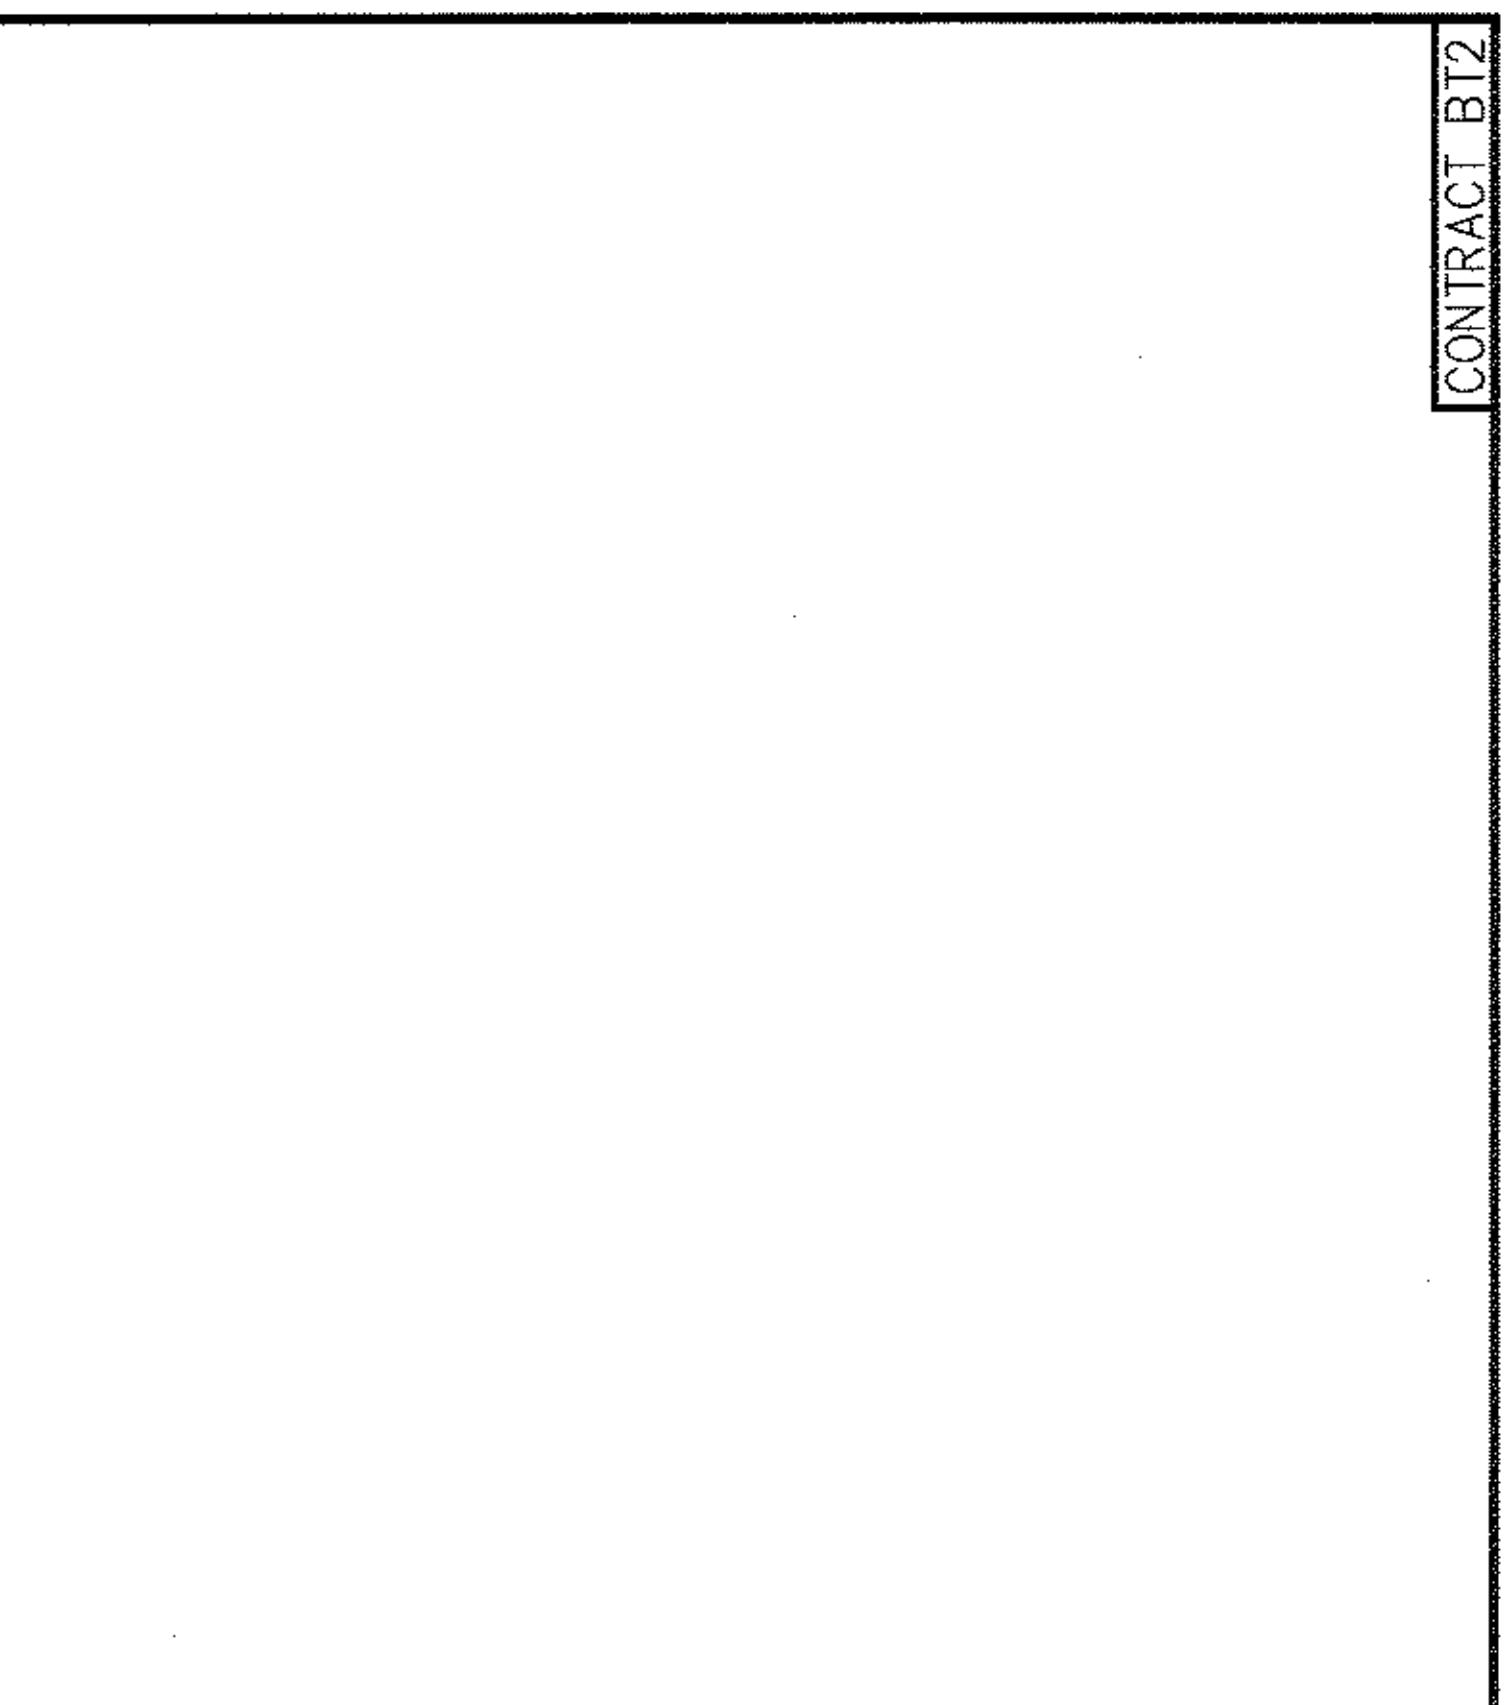
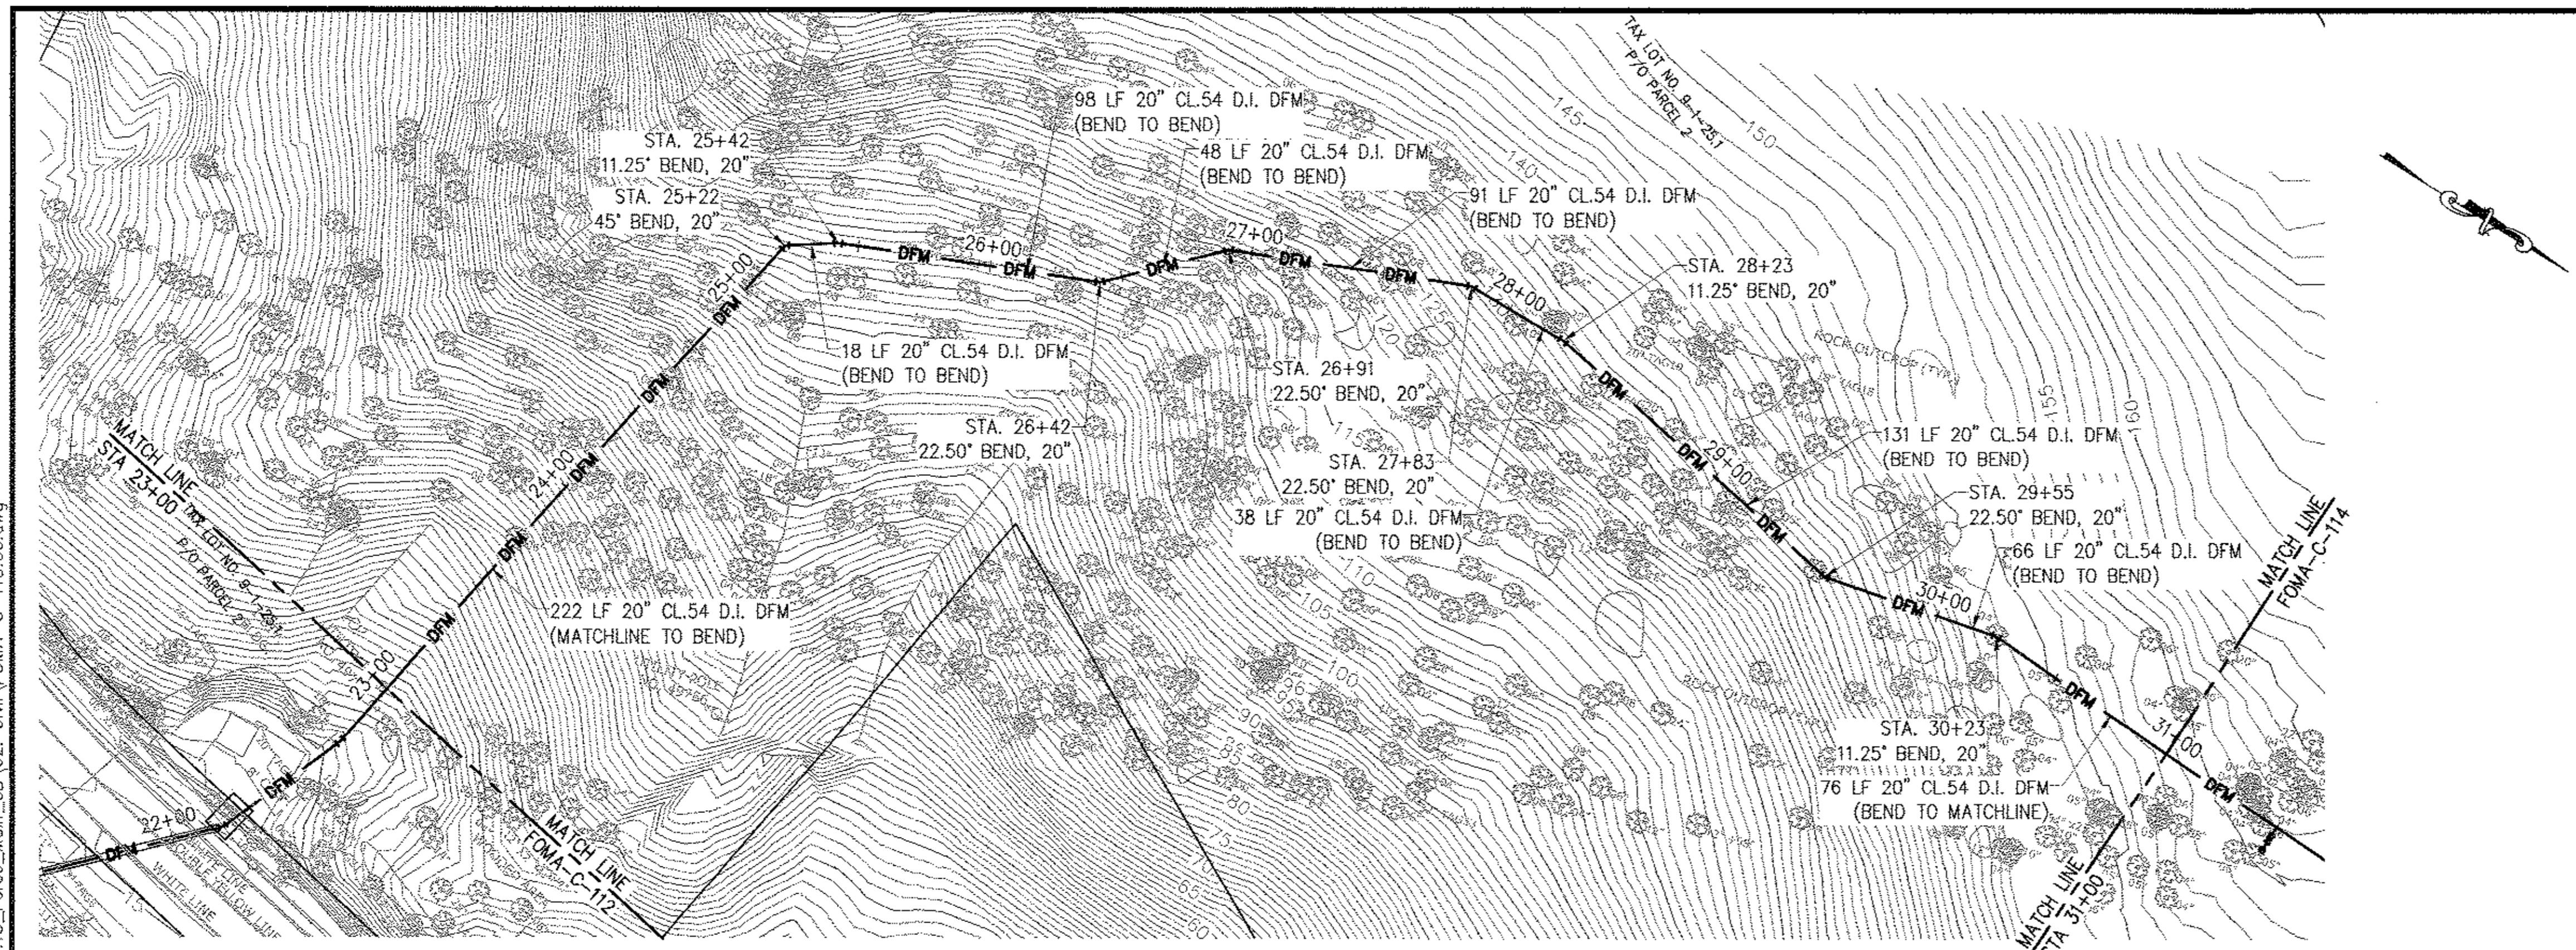
NO. DATE DESCRIPTION APPR'D.
REVISIONS

DESIGNED BY:
GM
CHECKED BY:
FP
DESIGN LEAD:
GM
SECTION CHIEF:
FP


DRAWN BY:
GM
Water Future
Environmental Protection

Environmental Protection

CONTRACT BT2



CONTRACT BT2

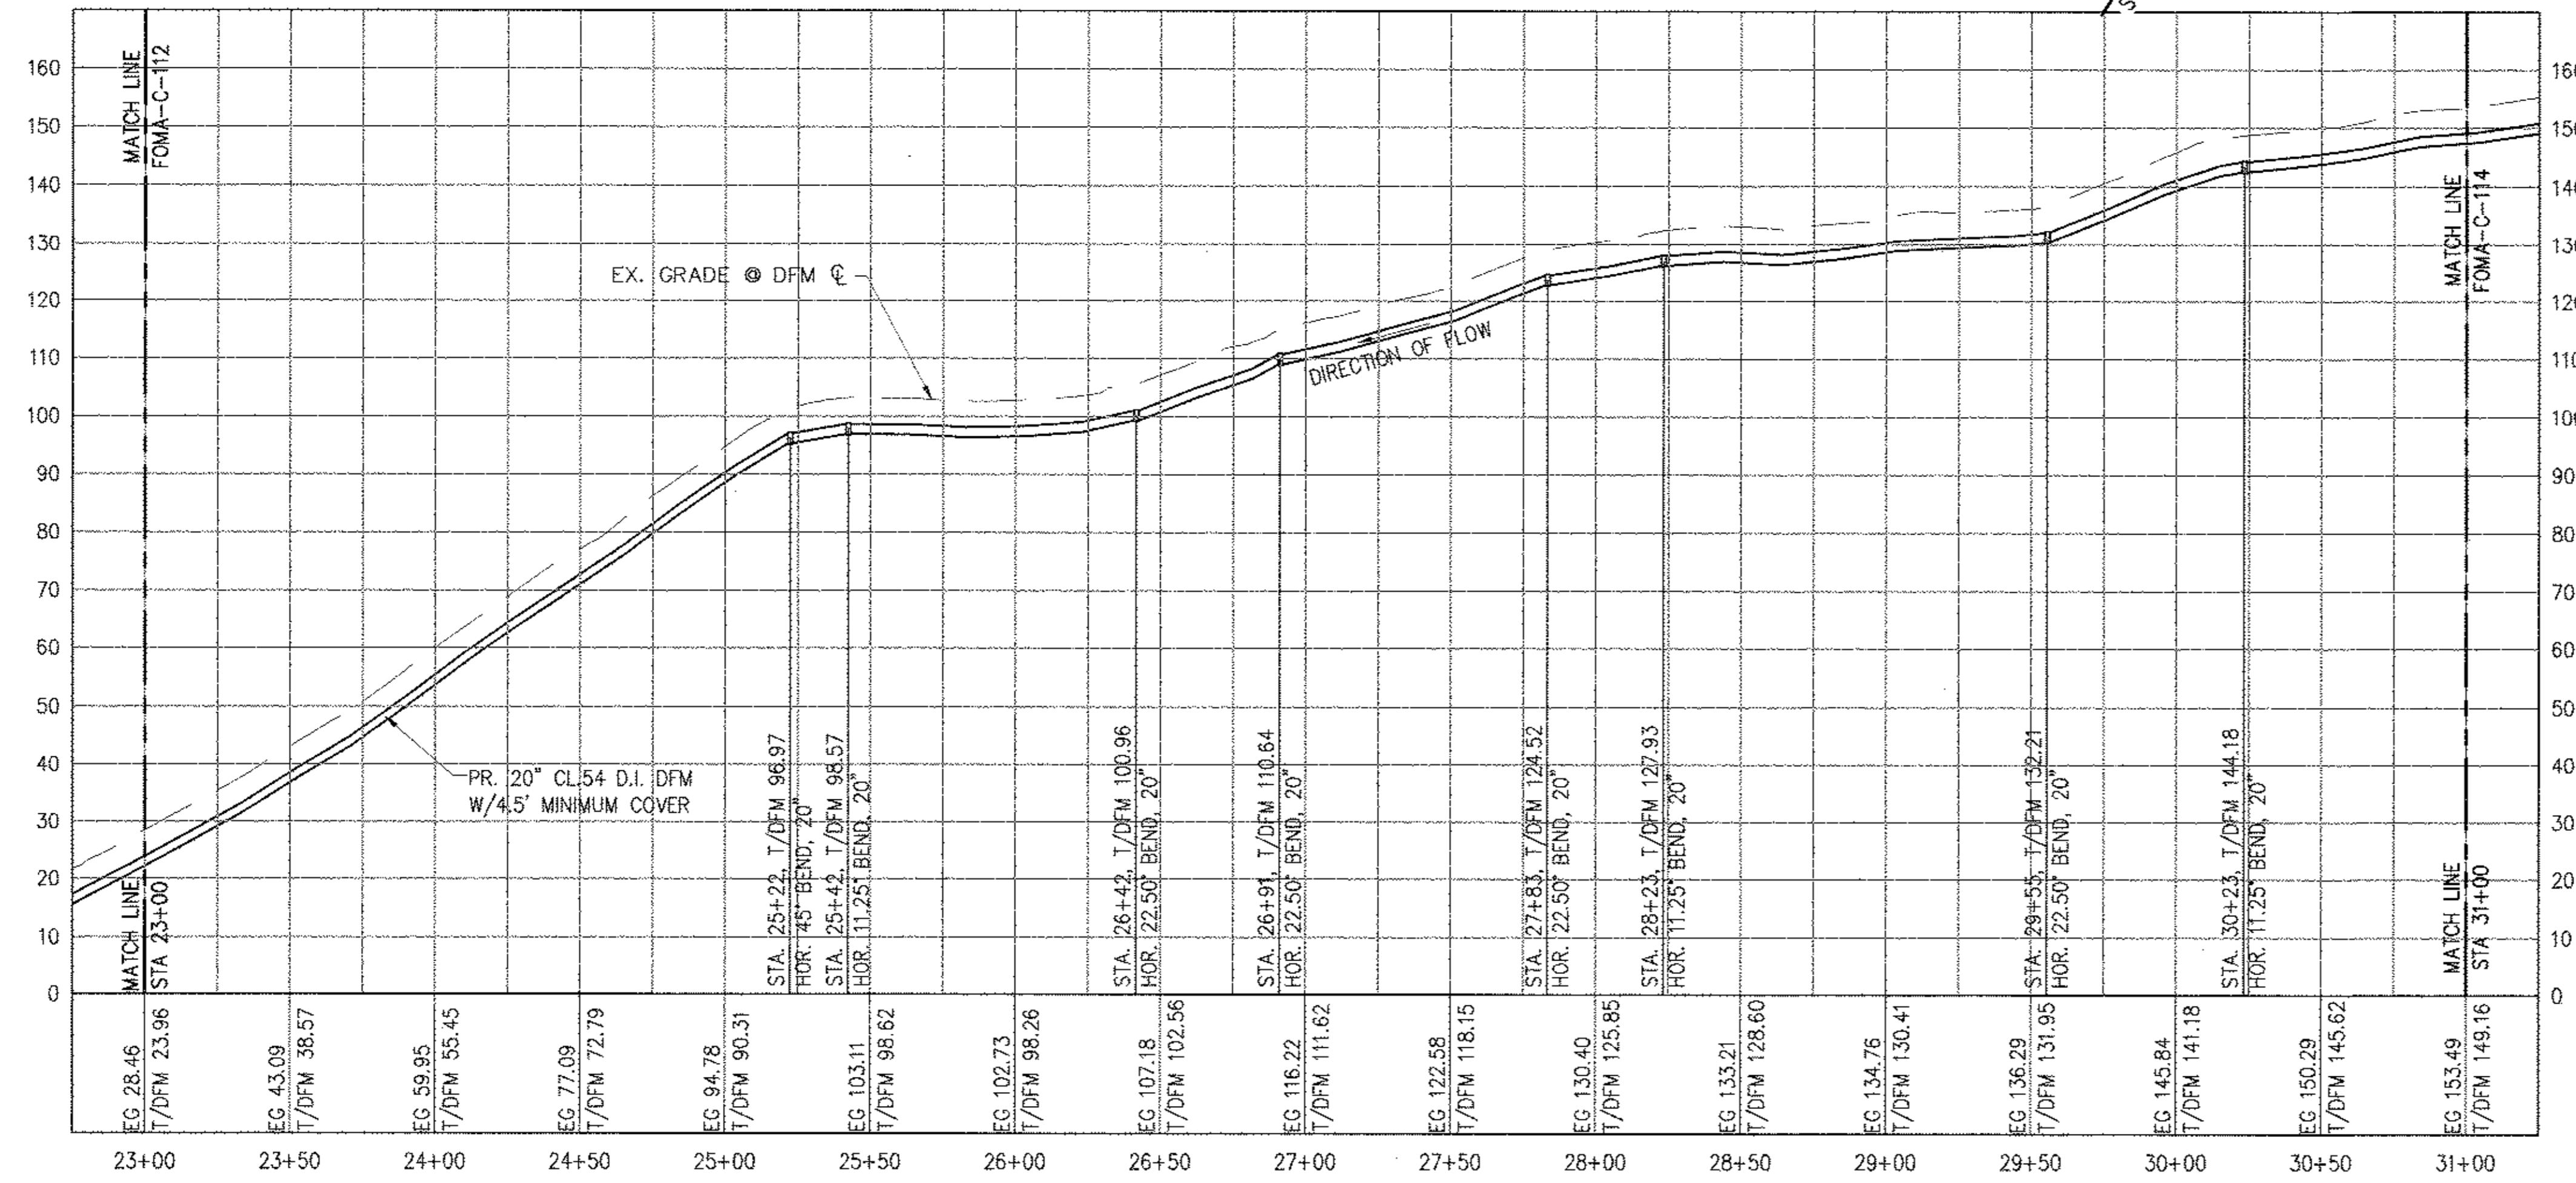

VERTICAL 0 20 40 FT.
1"=20'
HORIZONTAL 0 40 80 FT.
1"=40'

BELL PROPERTY
SITE DESIGN
DATE SUBMITTED: 02/10/2014

GRAPHIC SCALES
CHECK BEFORE USE

IF SHEET IS LESS THAN 22" X 34"
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SCALE ACCORDINGLY.


| | | | | |
|-----------------------|--|---|--|--|
| DESIGNED BY: GM | DRAWN BY: GM | PROJECT MANAGER TED DOWNEY | NEW YORK CITY ENVIRONMENTAL PROTECTION BUREAU OF ENGINEERING DESIGN & CONSTRUCTION 96-05 HORACE HARDING EXPRESSWAY 5th FLOOR CORONA, NEW YORK 11368 www.nyc.gov/dep | RONDOUT WEST BRANCH BYPASS TUNNEL CONSTRUCTION AND WAWARSING REPAIRS, DELAWARE AQUEDUCT FORCE MAIN PIPING PLAN & PROFILE STA 24+00 TO STA 32+00 |
| CHECKED BY: FP | NYC Water for Future Environmental Protection | CHIEF, TUNNEL DESIGN BURJAR KHARIVALA | | DATE: 11/22/2013 SCALE: 1/8"=1'-0" SHEET NO: 1 OF 453 |
| DESIGN LEAD: GM | | DIRECTOR, IN-HOUSE DESIGN PATRICK O'CONNOR | | DRAWING NO. FOMA-C-115.00 |
| NO. DATE REVISIONS | DESCRIPTION APPR'D. SECTION CHIEF: FP | | | |

Last Saved By & Date: CCumberbatch, Tuesday, February 04, 2014 and Date Plotted: Thursday, February 06, 2014
Paper Size: ANSI D (34.00 x 22.00 inches) Plot Scale: 1:1 Plot Style Table: BEDC_22x34_Full_Size.ctb
Drawing Name: & Location: B:\BWS_RWBT-2\02_Design_Files\2.1_Deliverables\02_Archived_Dwg\06_Bell_Property_Permitting_Dwg's\Task No. 1.13_Force_Main_53\02_Civil\FCOMA-C-116.00.dwg


CONTRACT BT2

| DATE | DESCRIPTION | APPROVED |
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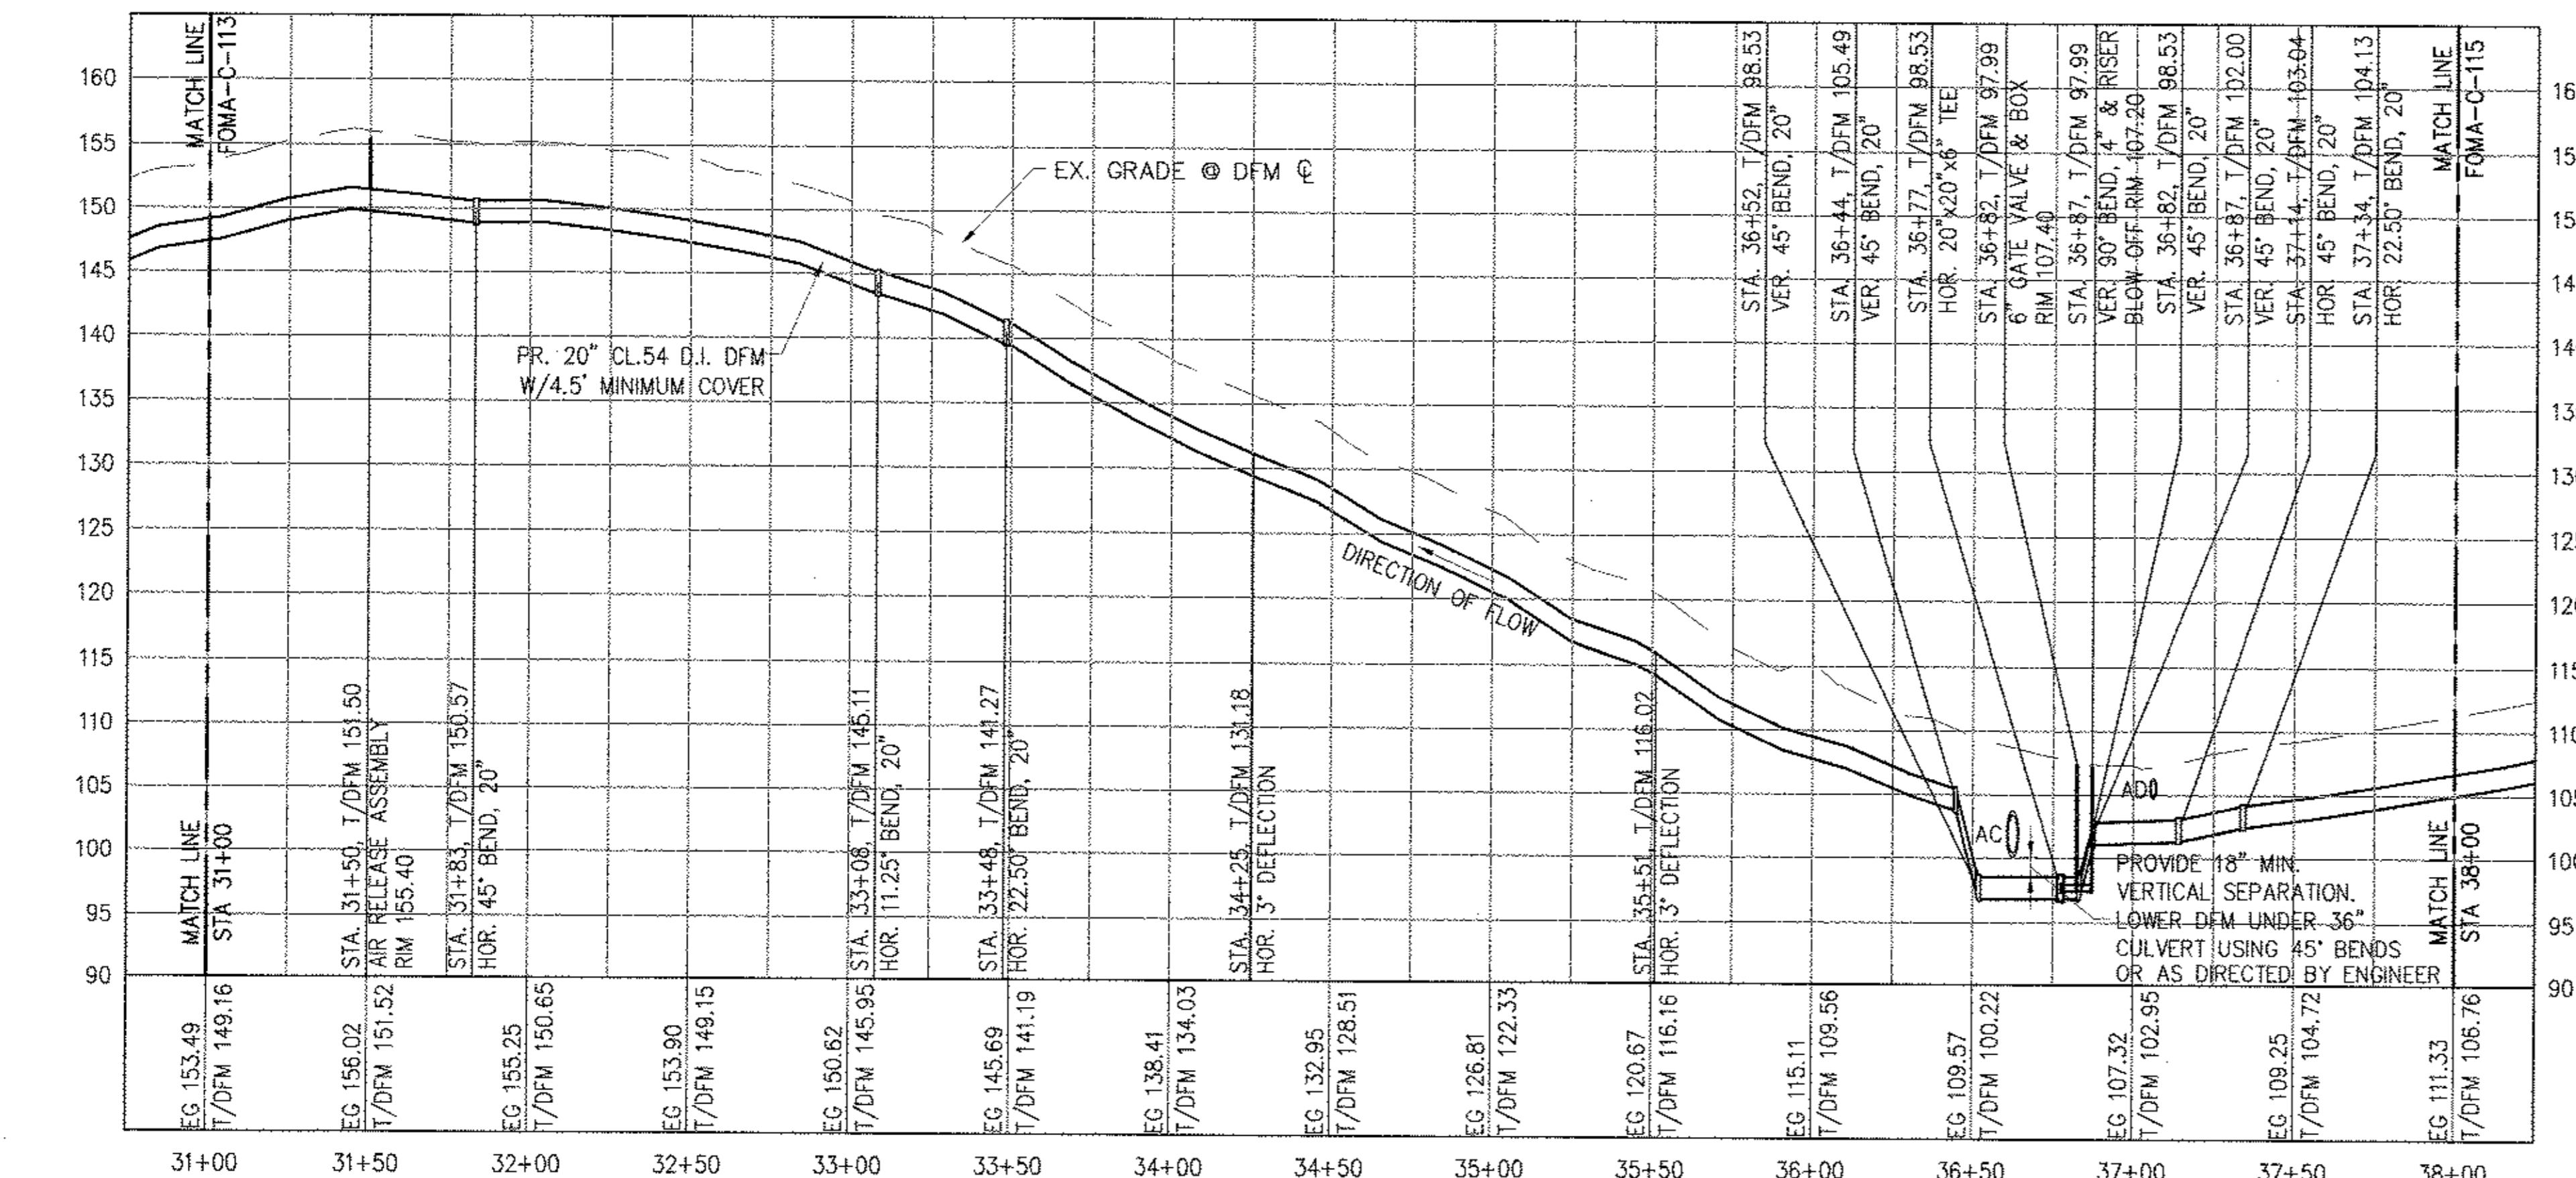
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|  PROJECT MANAGER TED DOWNEY | WARNING—IT IS A VIOLATION, OF NEW YORK STATE EDUCATION LAW, SEC 7209.2, FOR ANY PERSON, UNLESS ACTING UNDER THE DIRECTION OF LICENSED PROFESSIONAL ENGINEER, TO ALTER THIS DOCUMENT IN ANY WAY. IF A THE ALTERING PERSON SHALL COMPLY WITH THE REQUIREMENTS OF NEW YORK EDUCATION LAW, SECTION, 7209.2. |
| CHIEF, TUNNEL DESIGN SURJOD KHARIVALA | |
| DIRECTOR, IN HOUSE DESIGN PATRICK O'CONNOR | |

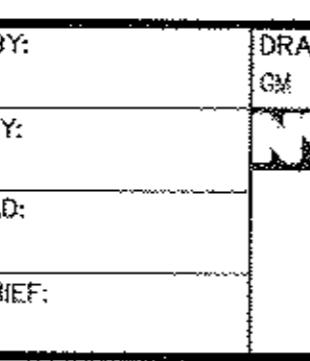

| UTILITY CROSSING SCHEDULE | | | | |
|---------------------------|---------|-----------------|---------------|--------------------|
| NAME | STATION | DISCRIPTION | DFM ELEVATION | CROSSING ELEVATION |
| AC | 36+62 | 36" STORM DRAIN | T/P 98.60 | B/P 100.10± (VIF) |
| AD | 37+06 | 15" STORM DRAIN | T/P 103.30 | B/P 104.95± (VIF) |

| DFM CURVE SCHEDULE | | | | | | | | |
|--------------------|---------------|-------------|----------|--------------|-----------------------|---------------|----------------------------------|-------------------------|
| CURVE # | START STATION | END STATION | RADIUS | CURVE LENGTH | TOTAL ANGLE, Δ | LAYING LENGTH | JOINT DEFLECTION ANGLE, θ | JOINT DEFLECTION OFFSET |
| C1 | 37+34 | 39+06 | 1408.00' | 171.82' | 6°59'30" | 20' | 0°48'50" | 0.28' |

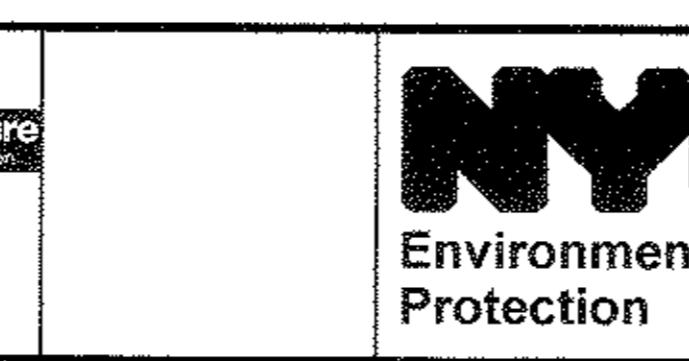The image shows two scale bars. The top bar is labeled 'VERTICAL' and '1"=10'. The bottom bar is labeled 'HORIZONTAL' and '1"=40'. Both bars have markings at 0, 10, 20, 40, and 80 feet.

BELL PROPERTY
SITE DESIGN


DATE SUBMITTED:02/10/2014

GRAPHIC SCALES
CHECK BEFORE USE


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SCALE ACCORDINGLY

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| EL IRS, | DATE: 11/22/2013 |
| | SCALE: 1/8"=1'-0" |
| | SHEET NO: |
| | 1 OF 453 |
| | DRAWING NO. |
| | FOMA-C-116.00 |

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96-05 HORACE HARDING EXPRESSWAY 5th FLOOR
CORONA, NEW YORK 11368
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| DFM CURVE SCHEDULE | | | | | | | | |
|--------------------|---------------|-------------|----------|--------------|-----------------------|---------------|----------------------------------|-------------------------|
| CURVE # | START STATION | END STATION | RADIUS | CURVE LENGTH | TOTAL ANGLE, Δ | LAYING LENGTH | JOINT DEFLECTION ANGLE, Θ | JOINT DEFLECTION OFFSET |
| C1 | 37+34 | 39+06 | 1408.00' | 171.82' | 6°59'30" | 20' | 0°48'50" | 0.28' |
| C2 | 39+30 | 41+08 | 942.00' | 177.71' | 10°48'33" | 20' | 1°12'59" | 0.42' |
| C3 | 45+86 | 46+72 | 538.00' | 86.35' | 9°11'45" | 20' | 2°07'47" | 0.74' |

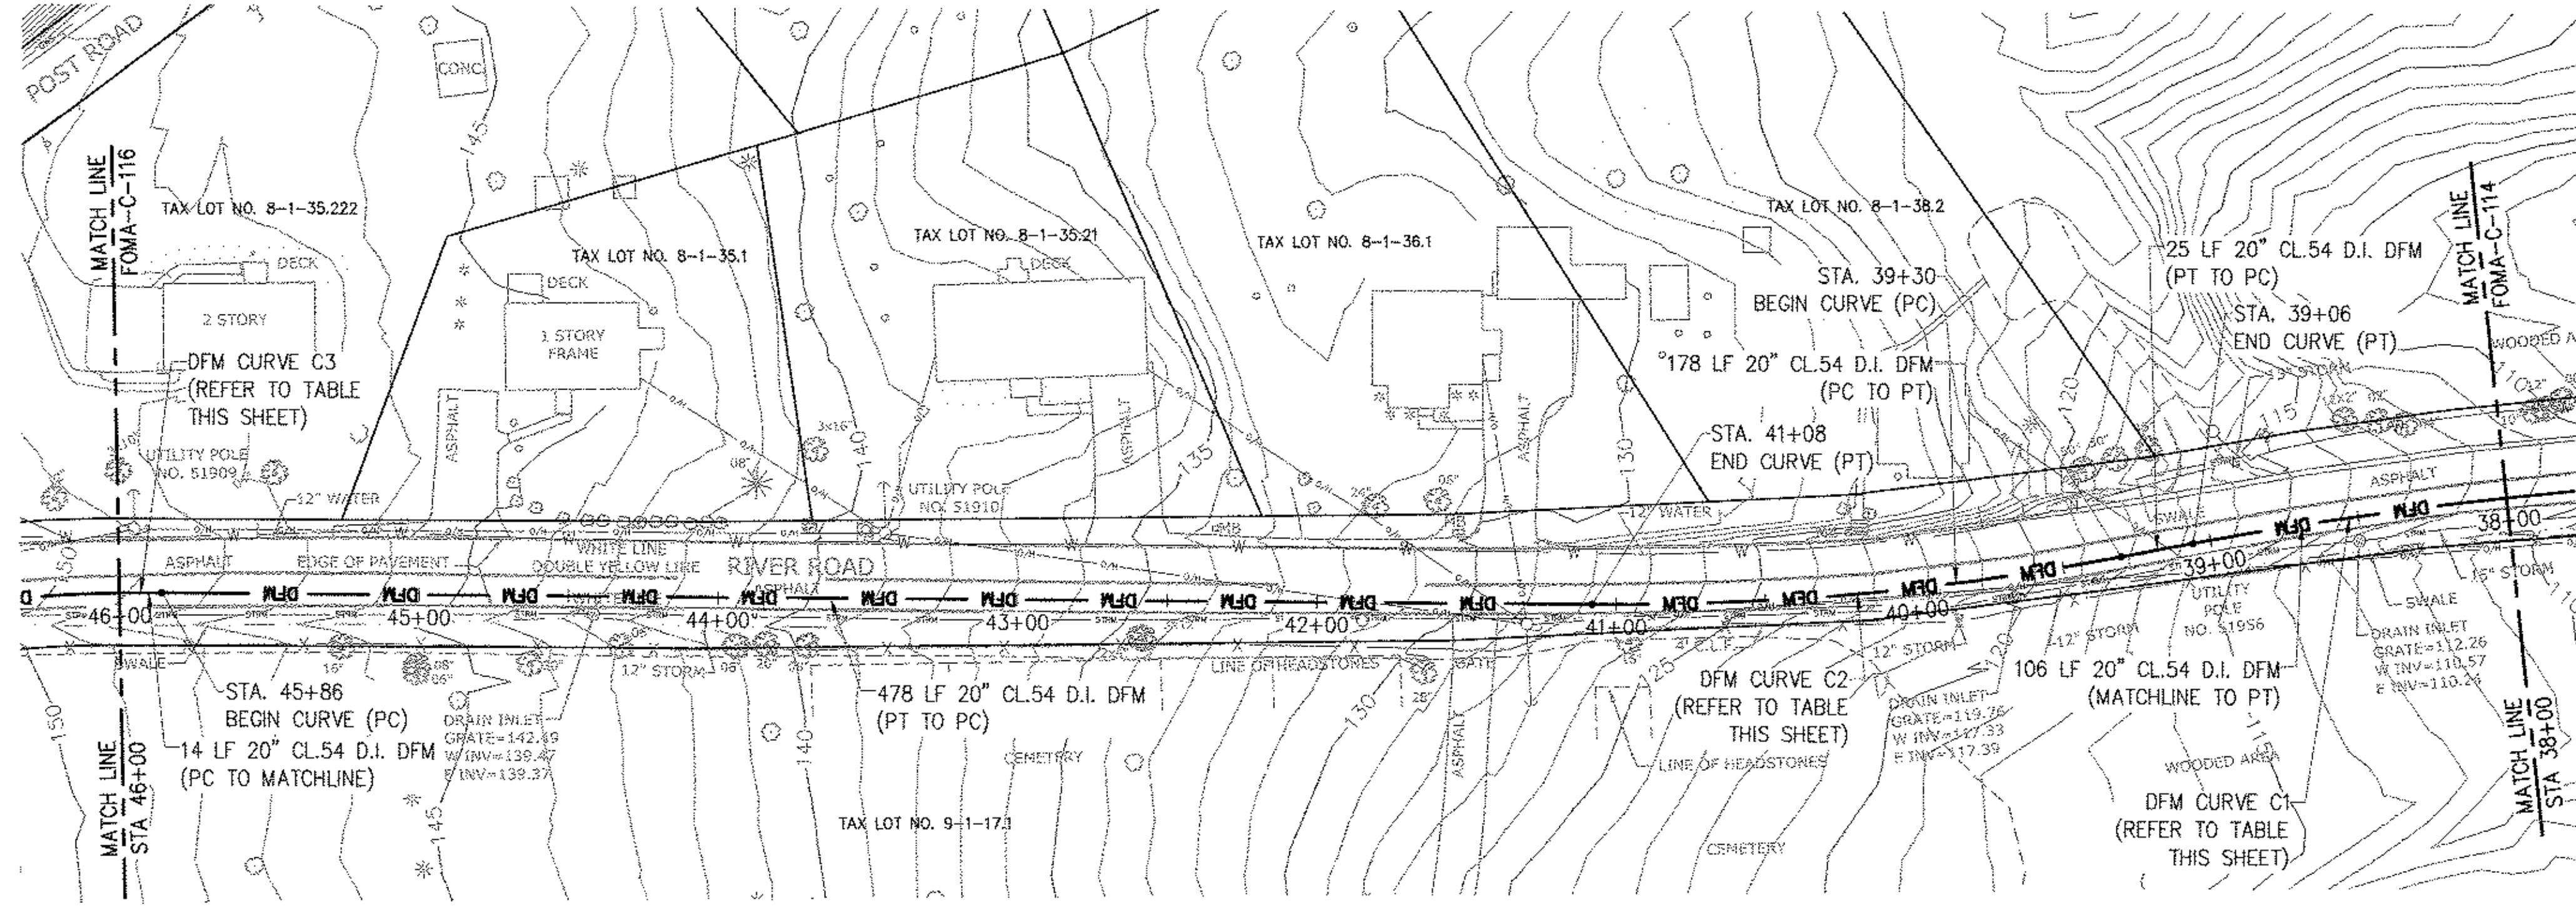The scale bar markings are as follows:

- Vertical Scale:** 0, 10, 20 FT. Below it, the text $1'' = 10'$ is written.
- Horizontal Scale:** 0, 40, 80 FT. Below it, the text $1'' = 40'$ is written.

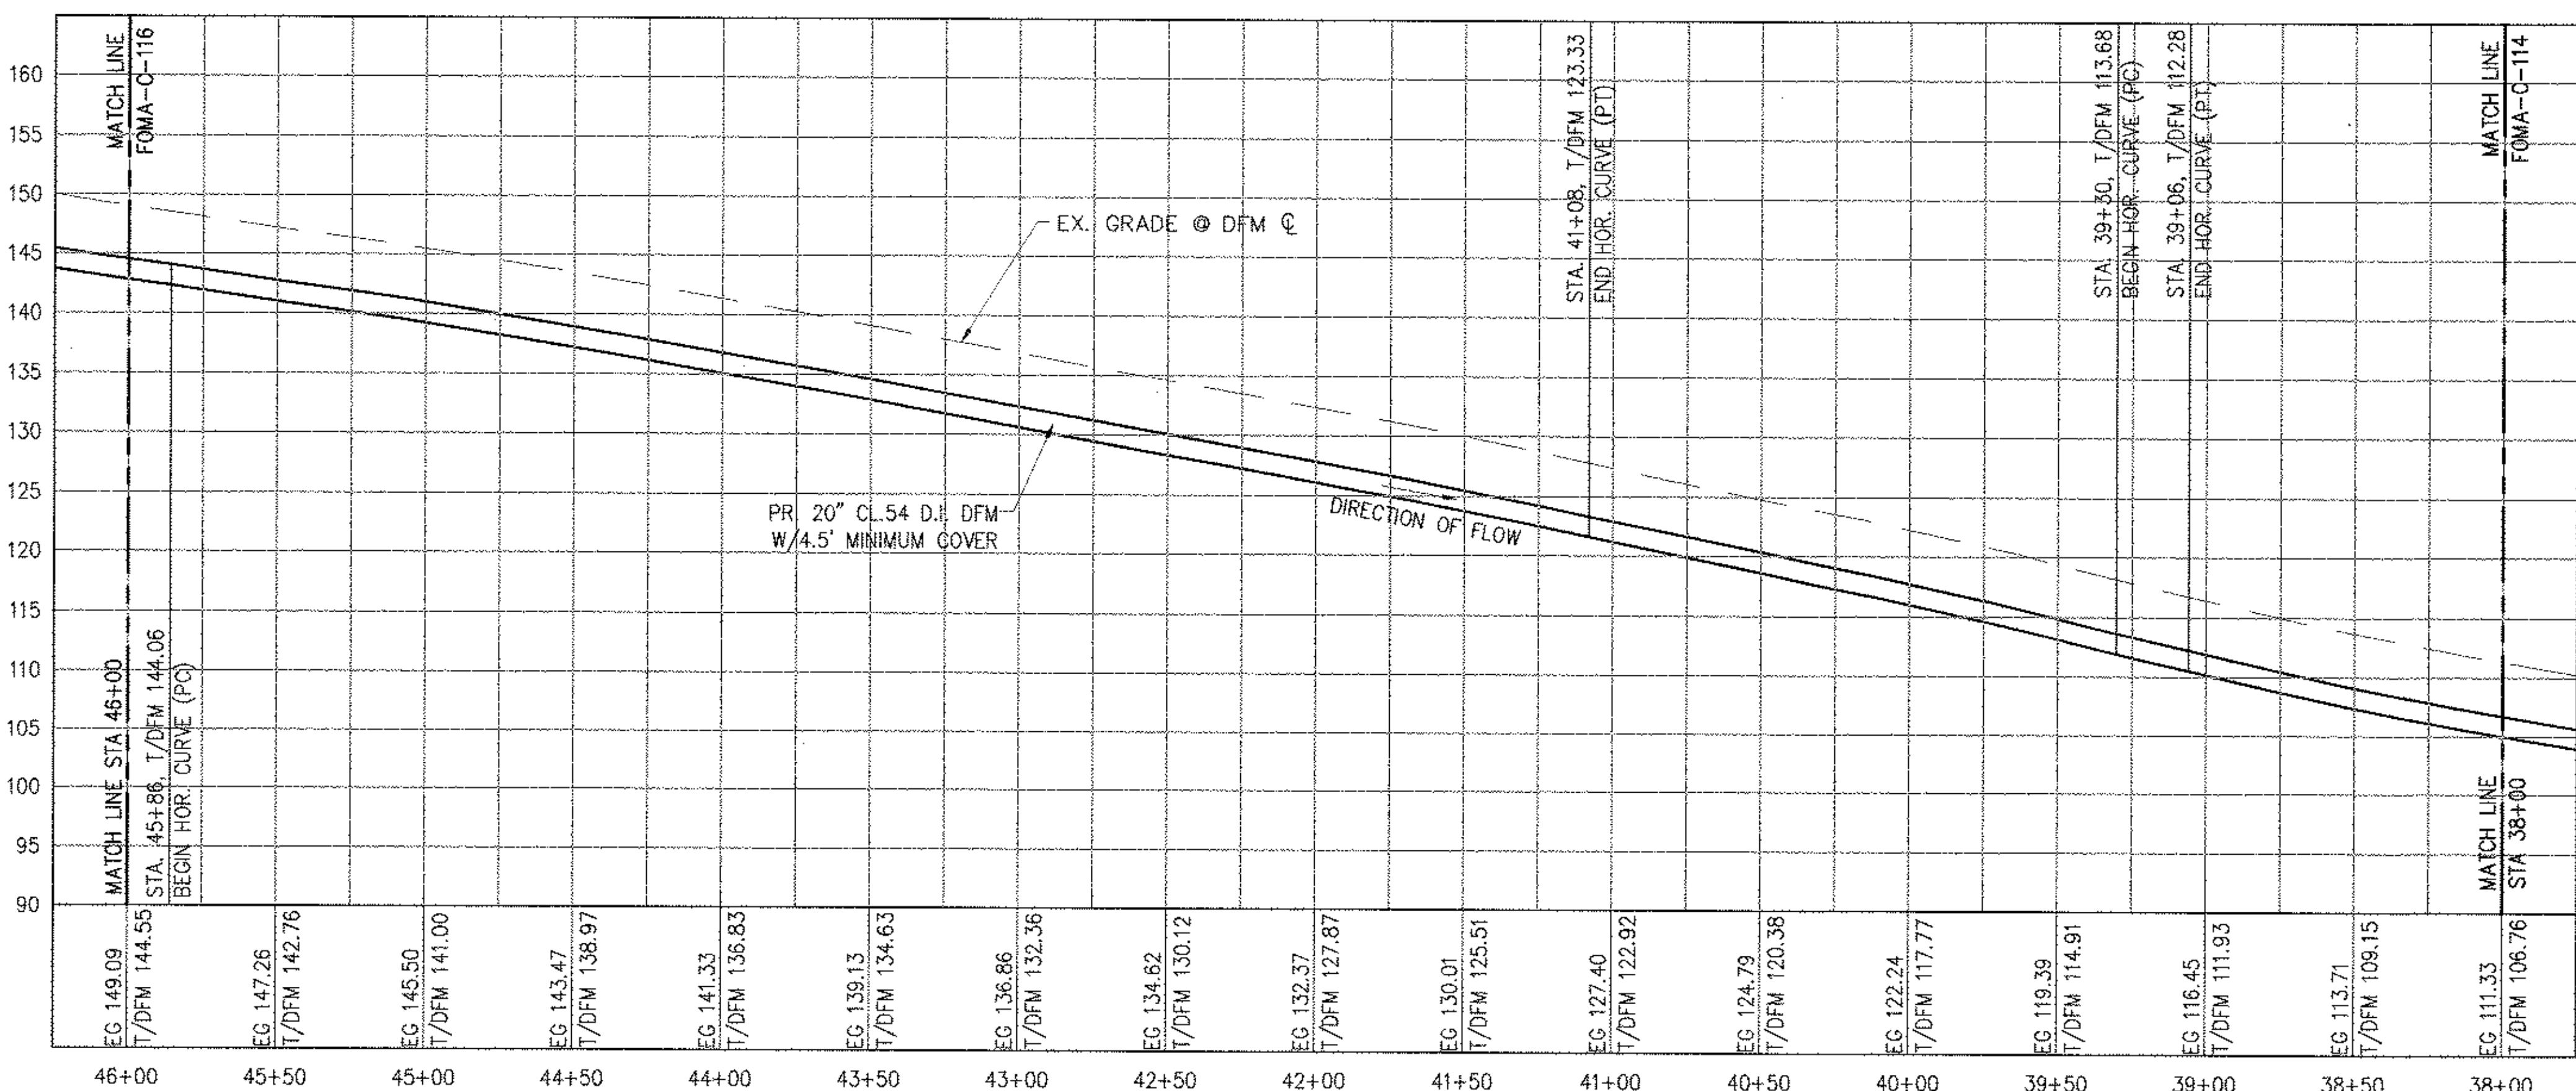BELL PROPERTY
SITE DESIGN

DATE SUBMITTED: 02/10/2014

**GRAPHIC SCALES
CHECK BEFORE USE**

IF SHEET IS LESS THAN 22" X 34"
IT IS A REDUCED PRINT.
SCALE ACCORDINGLY

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| DATE: 11/22/2013 |
| SCALE: AS NOTED |
| SHEET NO: |
| 1 OF 453 |
| DRAWING NO. |
| FOMA-C-117.00 |

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|-----------|------|-------------|--------------------|---|
| | | | DESIGNED BY: GM | DRAWN BY: GM |
| | | | CHECKED BY: FP |  |
| | | | DESIGN LEAD: GM | |
| NO. | DATE | DESCRIPTION | APPR'D. | SECTION CHIEF: FP |
| REVISIONS | | | | |



G® PROJECT MANAGER
TED DOWEY

CHIEF, TUNNEL DESIGN
BURJOR KHARIVALA

DIRECTOR, IN-HOUSE DESIGN
PATRICK O'CONNOR

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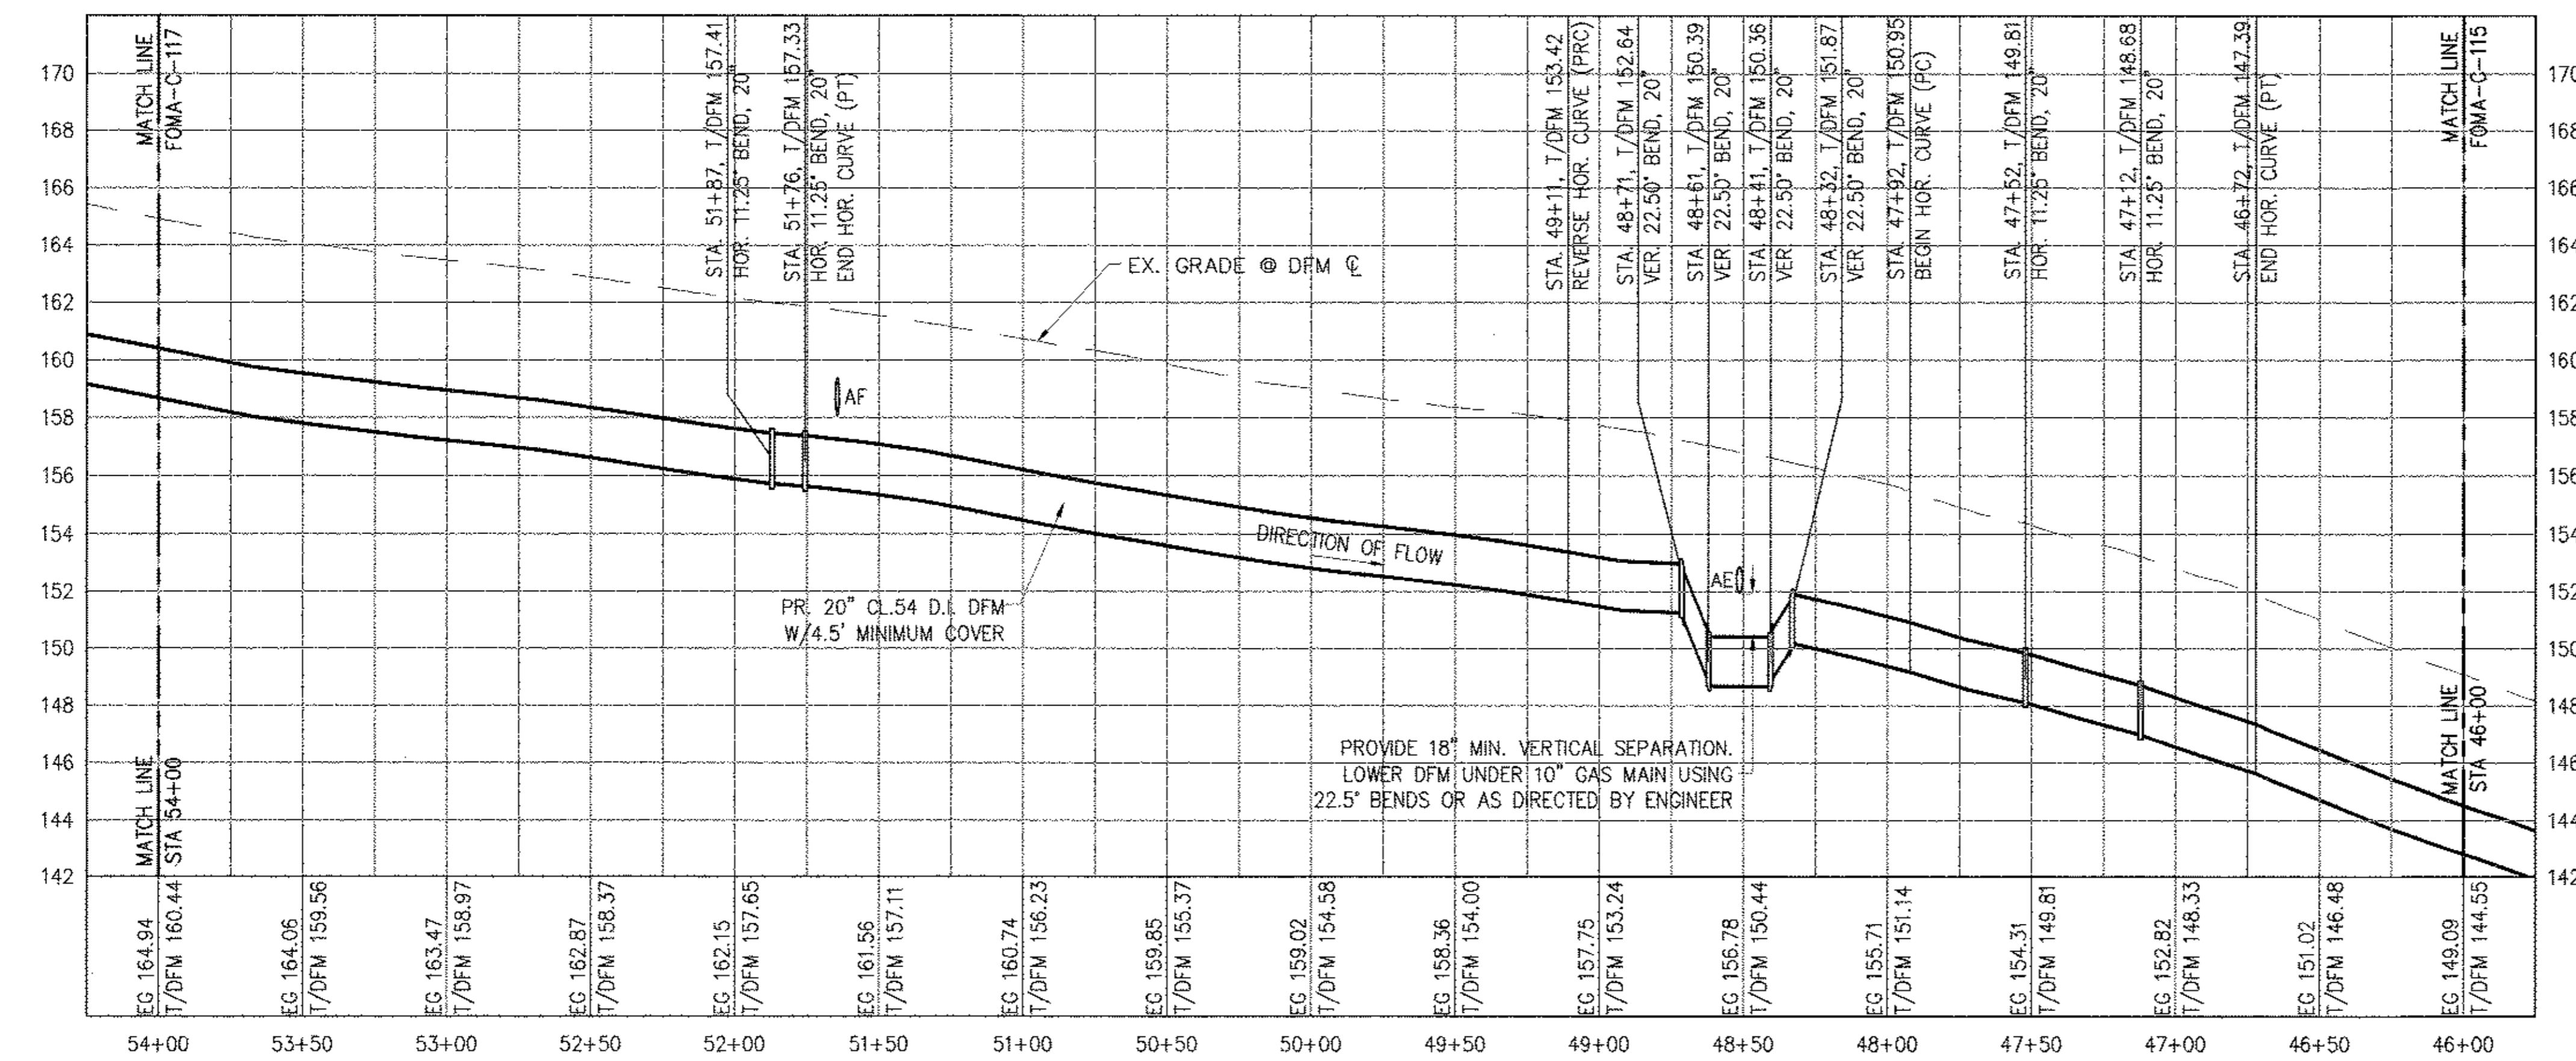
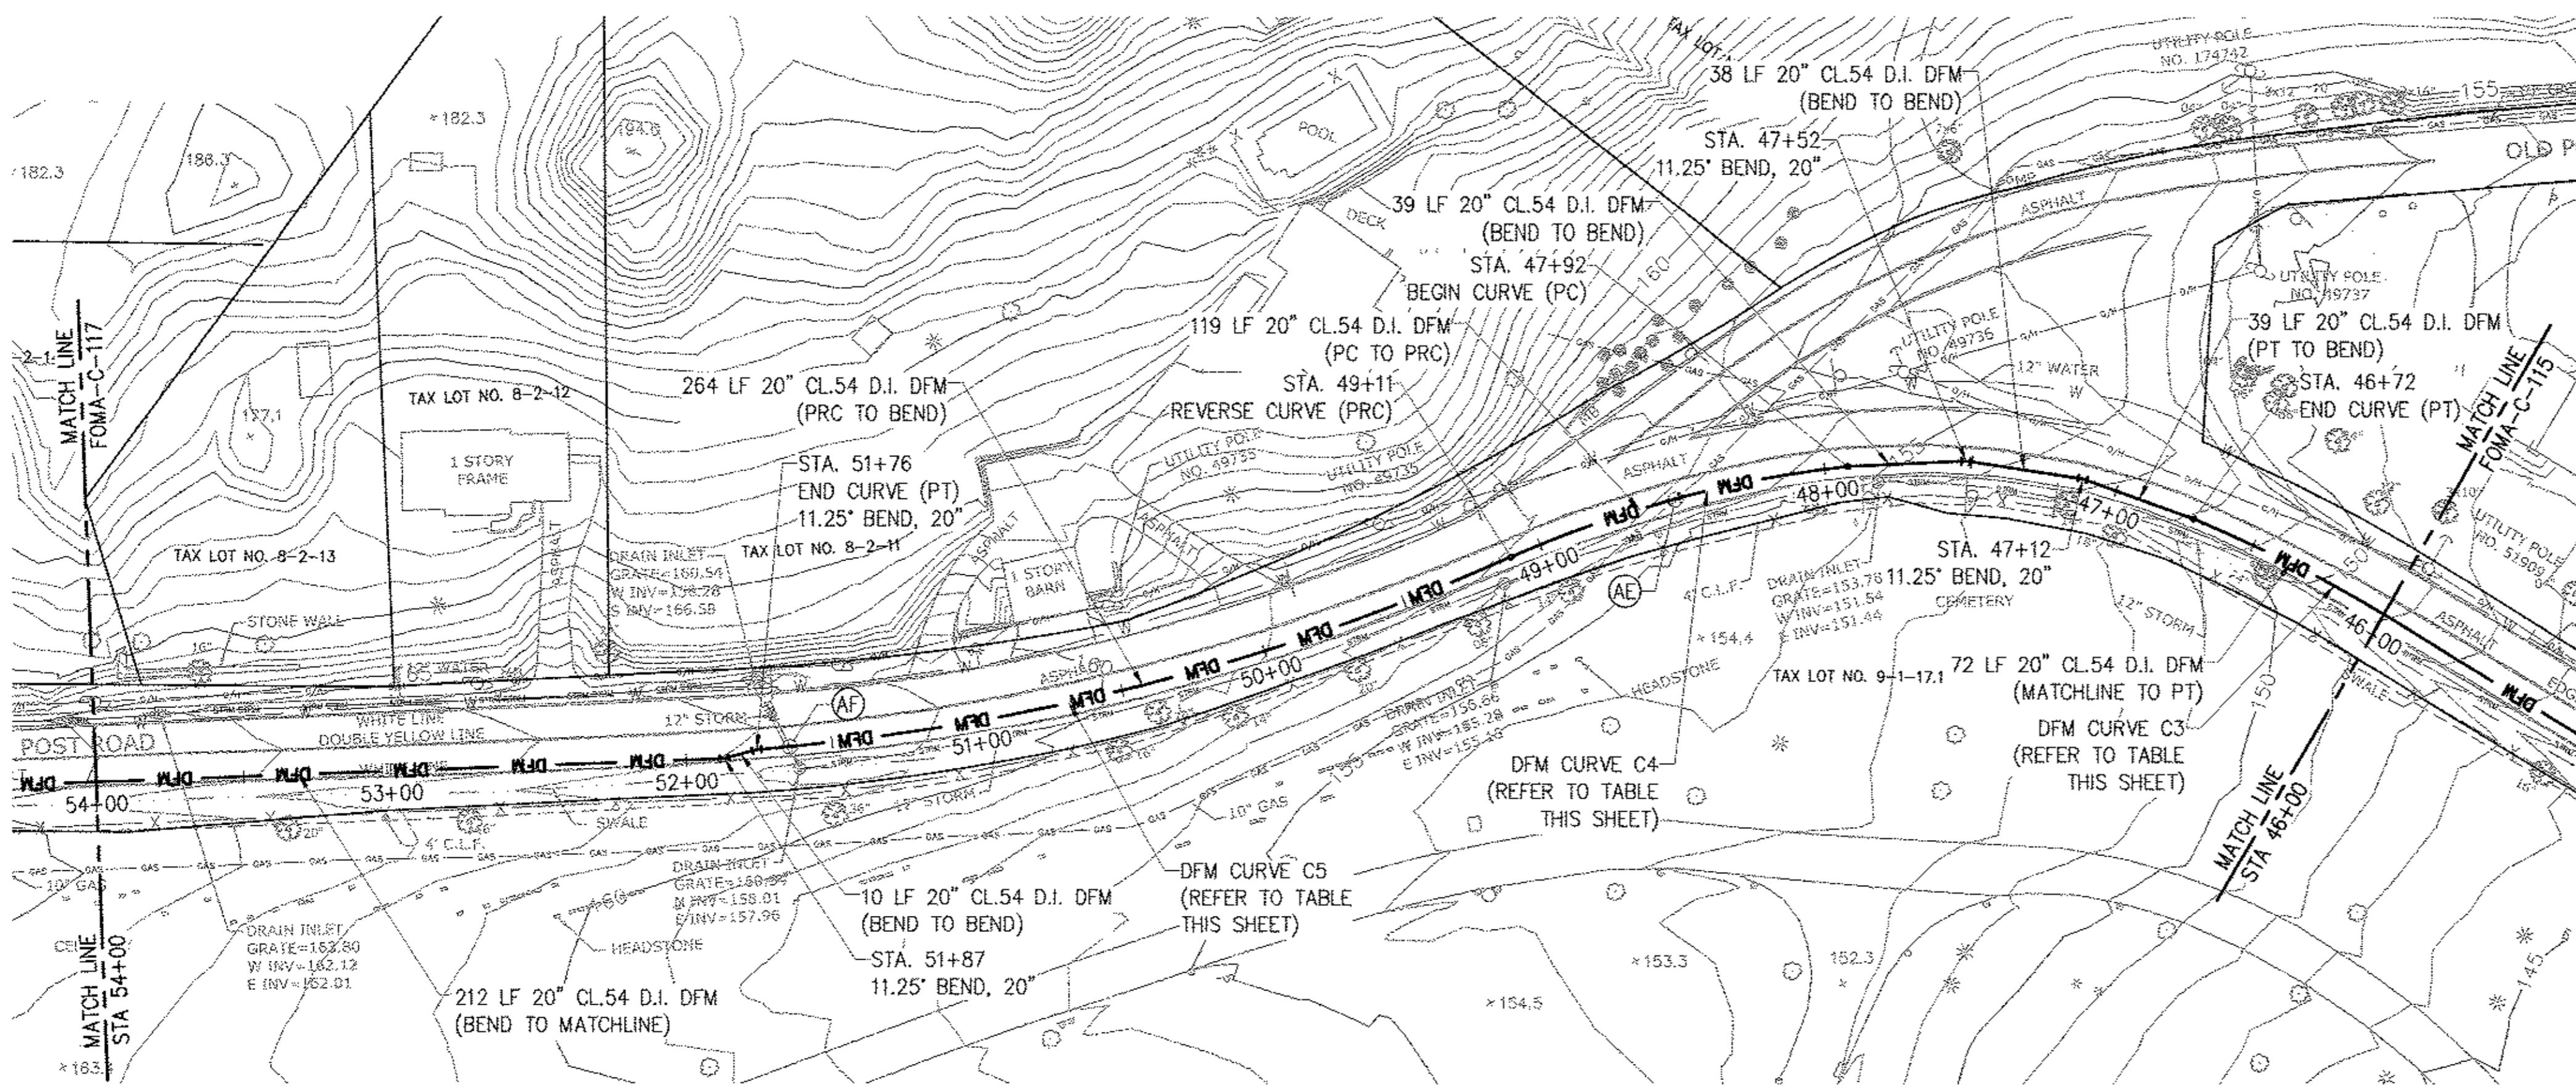
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NEW YORK
ENVIRONMENTAL
BUREAU OF ENGINEERING DEPT.
96-05 HORACE HARDING EX.
CORONA, NEW YORK
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**URBAN
CITY
PROTECTION**
DESIGN & CONSTRUCTION
EXPRESSWAY 5th FLOOR
YORK 11368
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All inquirers regarding this drawing(s) or project should be made to NYC Environmental Protection, Bureau of Engineering Design and Construction, email Eugene Irving at eugenei@dep.nyc.gov

Last Saved By & Date: CGumberbatch, Tuesday, February 04, 2014 and Date Plotted: Thursday, February 06, 2014
Paper Size: ANSI D (34.00 x 22.00 Inches) Plot Scale:1:1 Plot Style Table: BREDC_22x34_Full_Size.ctb
Drawing Name: & Location:B:\BWS\RWBT-2\02_Design_Files\2.1_Deliverables\02_Archived_Dwg\06_Bell_Property_Permitting_Dwg's\Task No. 113_Force_Main_5B\02_Civil\TOMA~C~118.00.dwg



| UTILITY CROSSING SCHEDULE | | | | |
|---------------------------|---------|-----------------|---------------|--------------------|
| NAME | STATION | DISCRIPTION | DFM ELEVATION | CROSSING ELEVATION |
| AE | 48+51 | 10" HP GAS MAIN | T/P 150.45 | B/P 152.00± (VIF) |
| AF | 51+64 | 12" STORM DRAIN | T/P 157.28 | B/P 158.22± (VIF) |

| DFM CURVE SCHEDULE | | | | | | | | |
|--------------------|---------------|-------------|---------|--------------|-----------------------|---------------|----------------------------------|-------------------------|
| CURVE # | START STATION | END STATION | RADIUS | CURVE LENGTH | TOTAL ANGLE, Δ | LAYING LENGTH | JOINT DEFLECTION ANGLE, Θ | JOINT DEFLECTION OFFSET |
| C3 | 45+86 | 46+72 | 538.00' | 86.35' | 9°11'45" | 20' | 2°07'47" | 0.74' |
| C4 | 47+92 | 49+11 | 383.00' | 118.69' | 17°45'18" | 20' | 2°59'29" | 1.04' |
| C5 | 49+11 | 51+76 | 787.00' | 264.81' | 19°16'45" | 20' | 1°27'22" | 0.51' |

VERTICAL 0 4 8 FT.
1" = 4'
HORIZONTAL 0 40 80 FT.
1" = 40'

BELL PROPERTY
SITE DESIGN

DATE SUBMITTED: 02/10/2014

GRAPHIC SCALES
CHECK BEFORE USE

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SCALE ACCORDINGLY

| | | |
|--------------------|---------------|------------|
| JUNNEL REPAIRS, | DATE: | 11/22/2013 |
| | SCALE: | AS NOTED |
| | SHEET NO: | |
| | 1 OF 453 | |
| | DRAWING NO. | |
| | FOMA-C-118.00 | |

| | | |
|---------|----------------------|-----------------|
| | DESIGNED BY: GM | DRAWN BY: GM |
| | CHECKED BY: FP | |
| | DESIGN LEAD: GM | |
| APPR'D. | SECTION CHIEF: FP | |



PROJECT MANAGER
TED DOWEY

CHIEF, TUNNEL DESIGN
BURJOR KHARIVALA


DIRECTOR, IN-HOUSE DES.
PATRICK O'CONNOR

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BUREAU OF ENGINEERING DESIGN & CONSTRUCTION
96-05 HORACE HARDING EXPRESSWAY 5th FLOOR
CORONA, NEW YORK 11368
www.nyc.gov/dep**

**ONDOUT WEST BRANCH BYPASS TUNNEL
CONSTRUCTION AND WAWARSING REPAIRS,
DELAWARE AQUEDUCT
FORCE MAIN
PIPING PLAN & PROFILE
STA 47+00 TO STA 55+00**

CONTRACT BT2

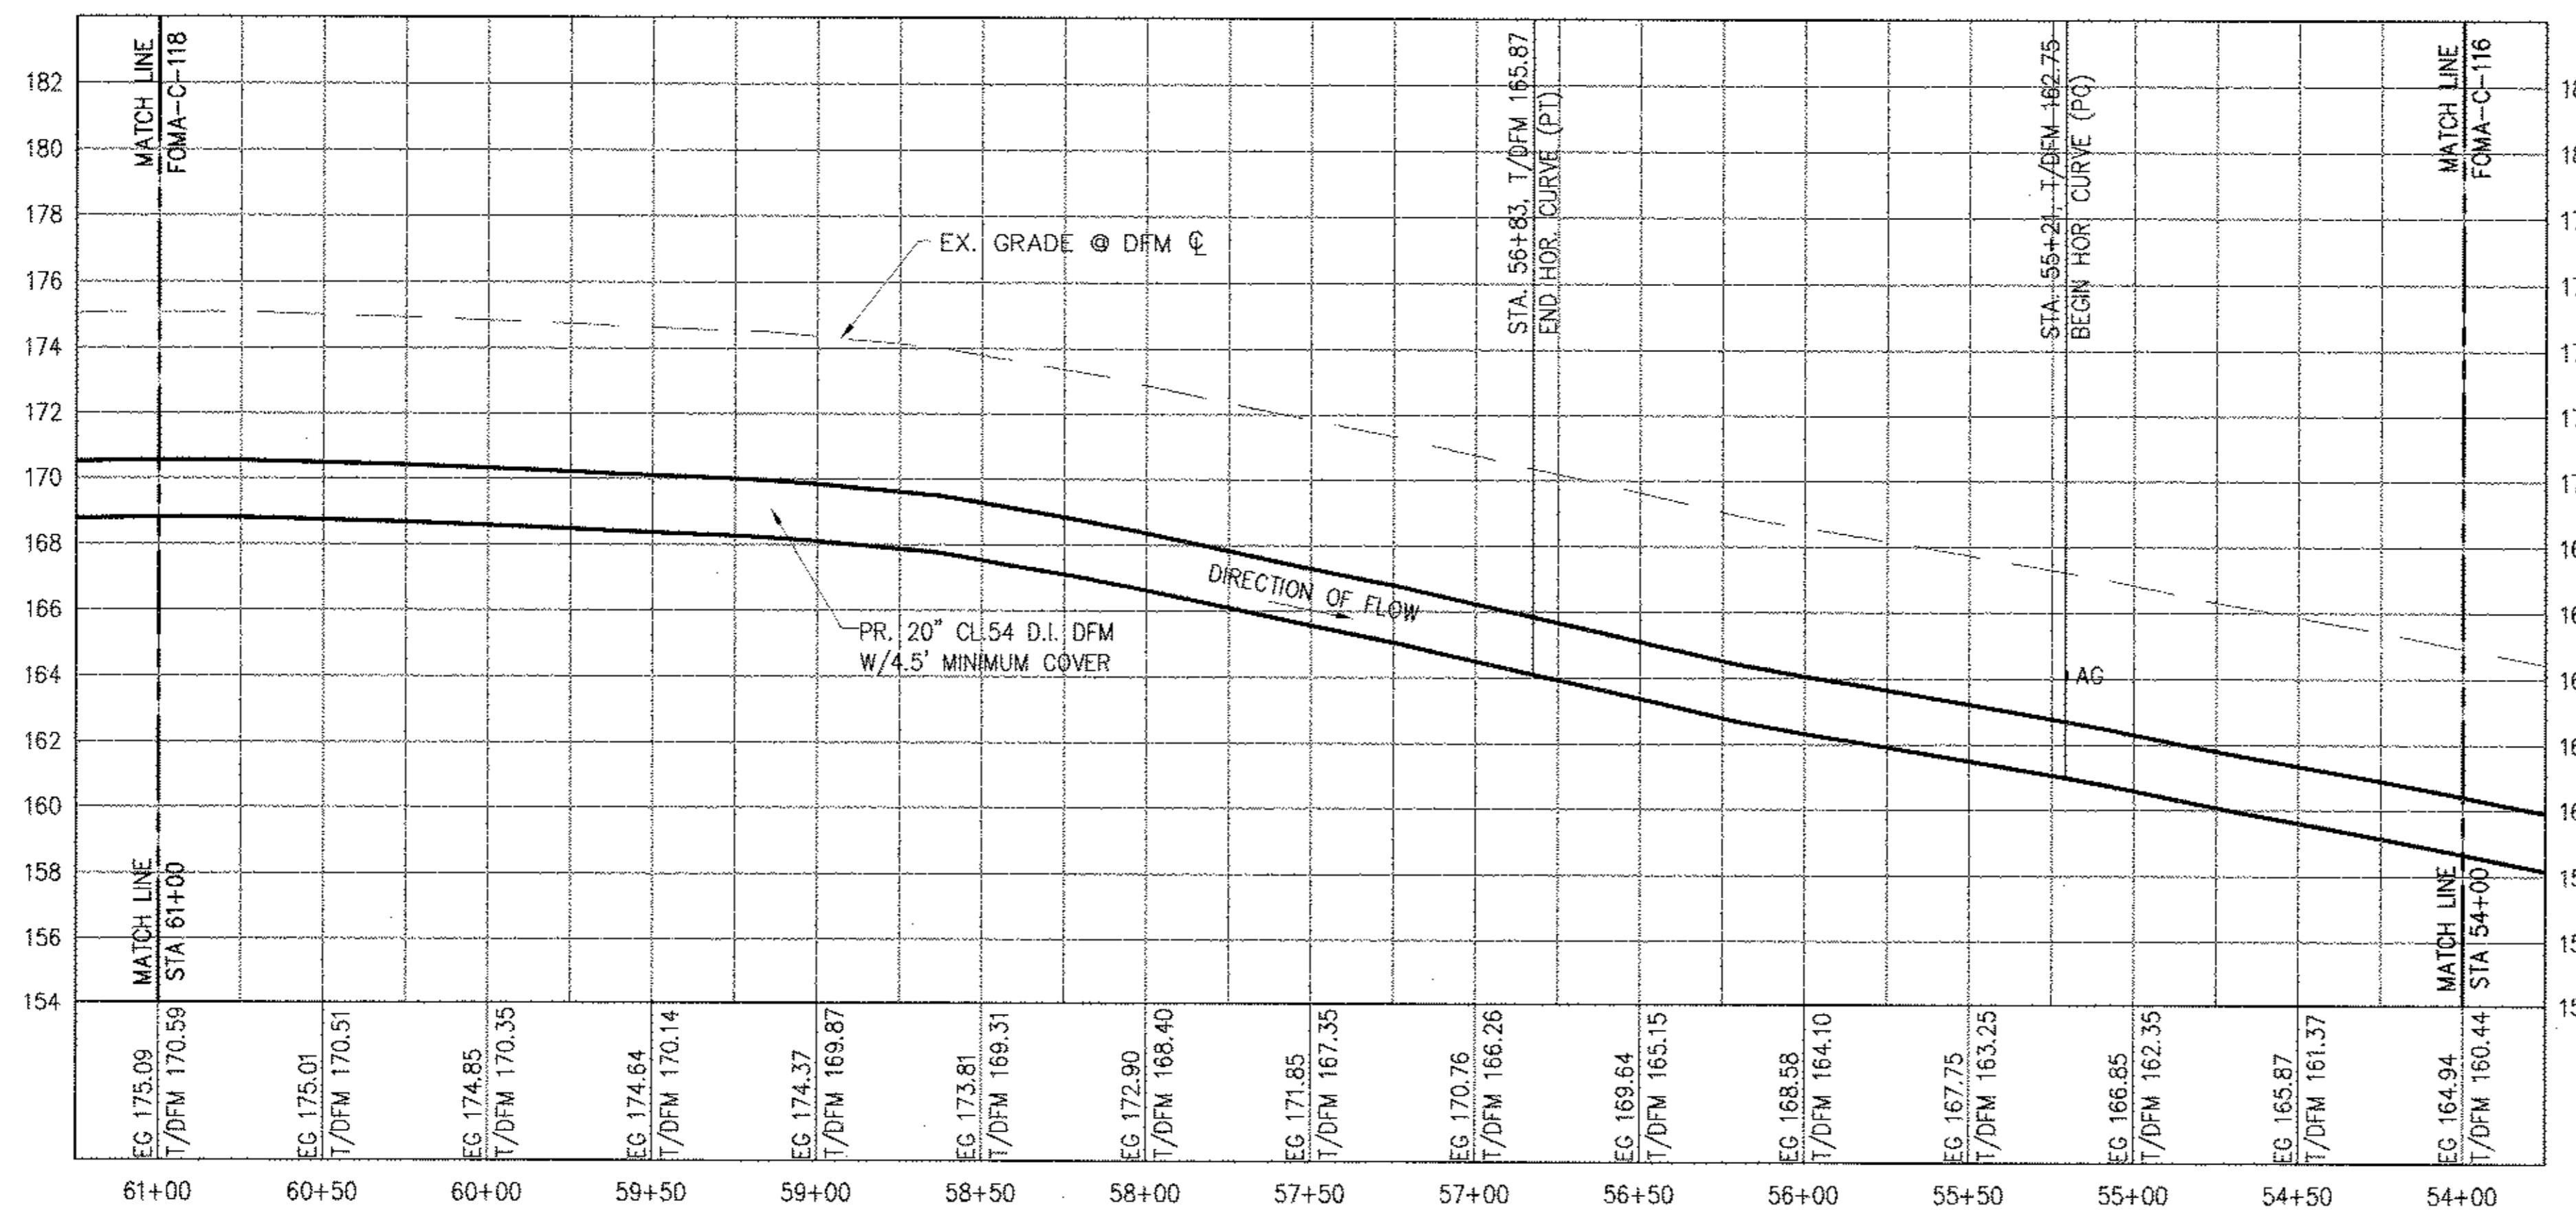

| UTILITY CROSSING SCHEDULE | | | | |
|---------------------------|---------|--------------|---------------|--------------------|
| NAME | STATION | DISCRIPTION | DFM ELEVATION | CROSSING ELEVATION |
| AG | 55+20 | UNK GAS MAIN | T/P 162.74 | VERIFY IN FIELD |

| DFM CURVE SCHEDULE | | | | | | | | |
|--------------------|---------------|-------------|----------|--------------|-----------------------|---------------|----------------------------------|-------------------------|
| CURVE # | START STATION | END STATION | RADIUS | CURVE LENGTH | TOTAL ANGLE, Δ | LAYING LENGTH | JOINT DEFLECTION ANGLE, Θ | JOINT DEFLECTION OFFSET |
| C6 | 55+21 | 56+83 | 2909.00' | 161.70' | 3'11'06" | 20' | 0'23'38" | 0.14' |

The scale bar markings are as follows:

- Vertical:** 0, 4, 8 FT. Below it, 1" = 4'.
- Horizontal:** 0, 40, 80 FT. Below it, 1" = 40'.

**BELL PROPERTY
SITE DESIGN**

GRAPHIC SCALES
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BUREAU OF ENGINEERING DESIGN & CONSTRUCTION
96-05 HORACE HARDING EXPRESSWAY 5th FLOOR
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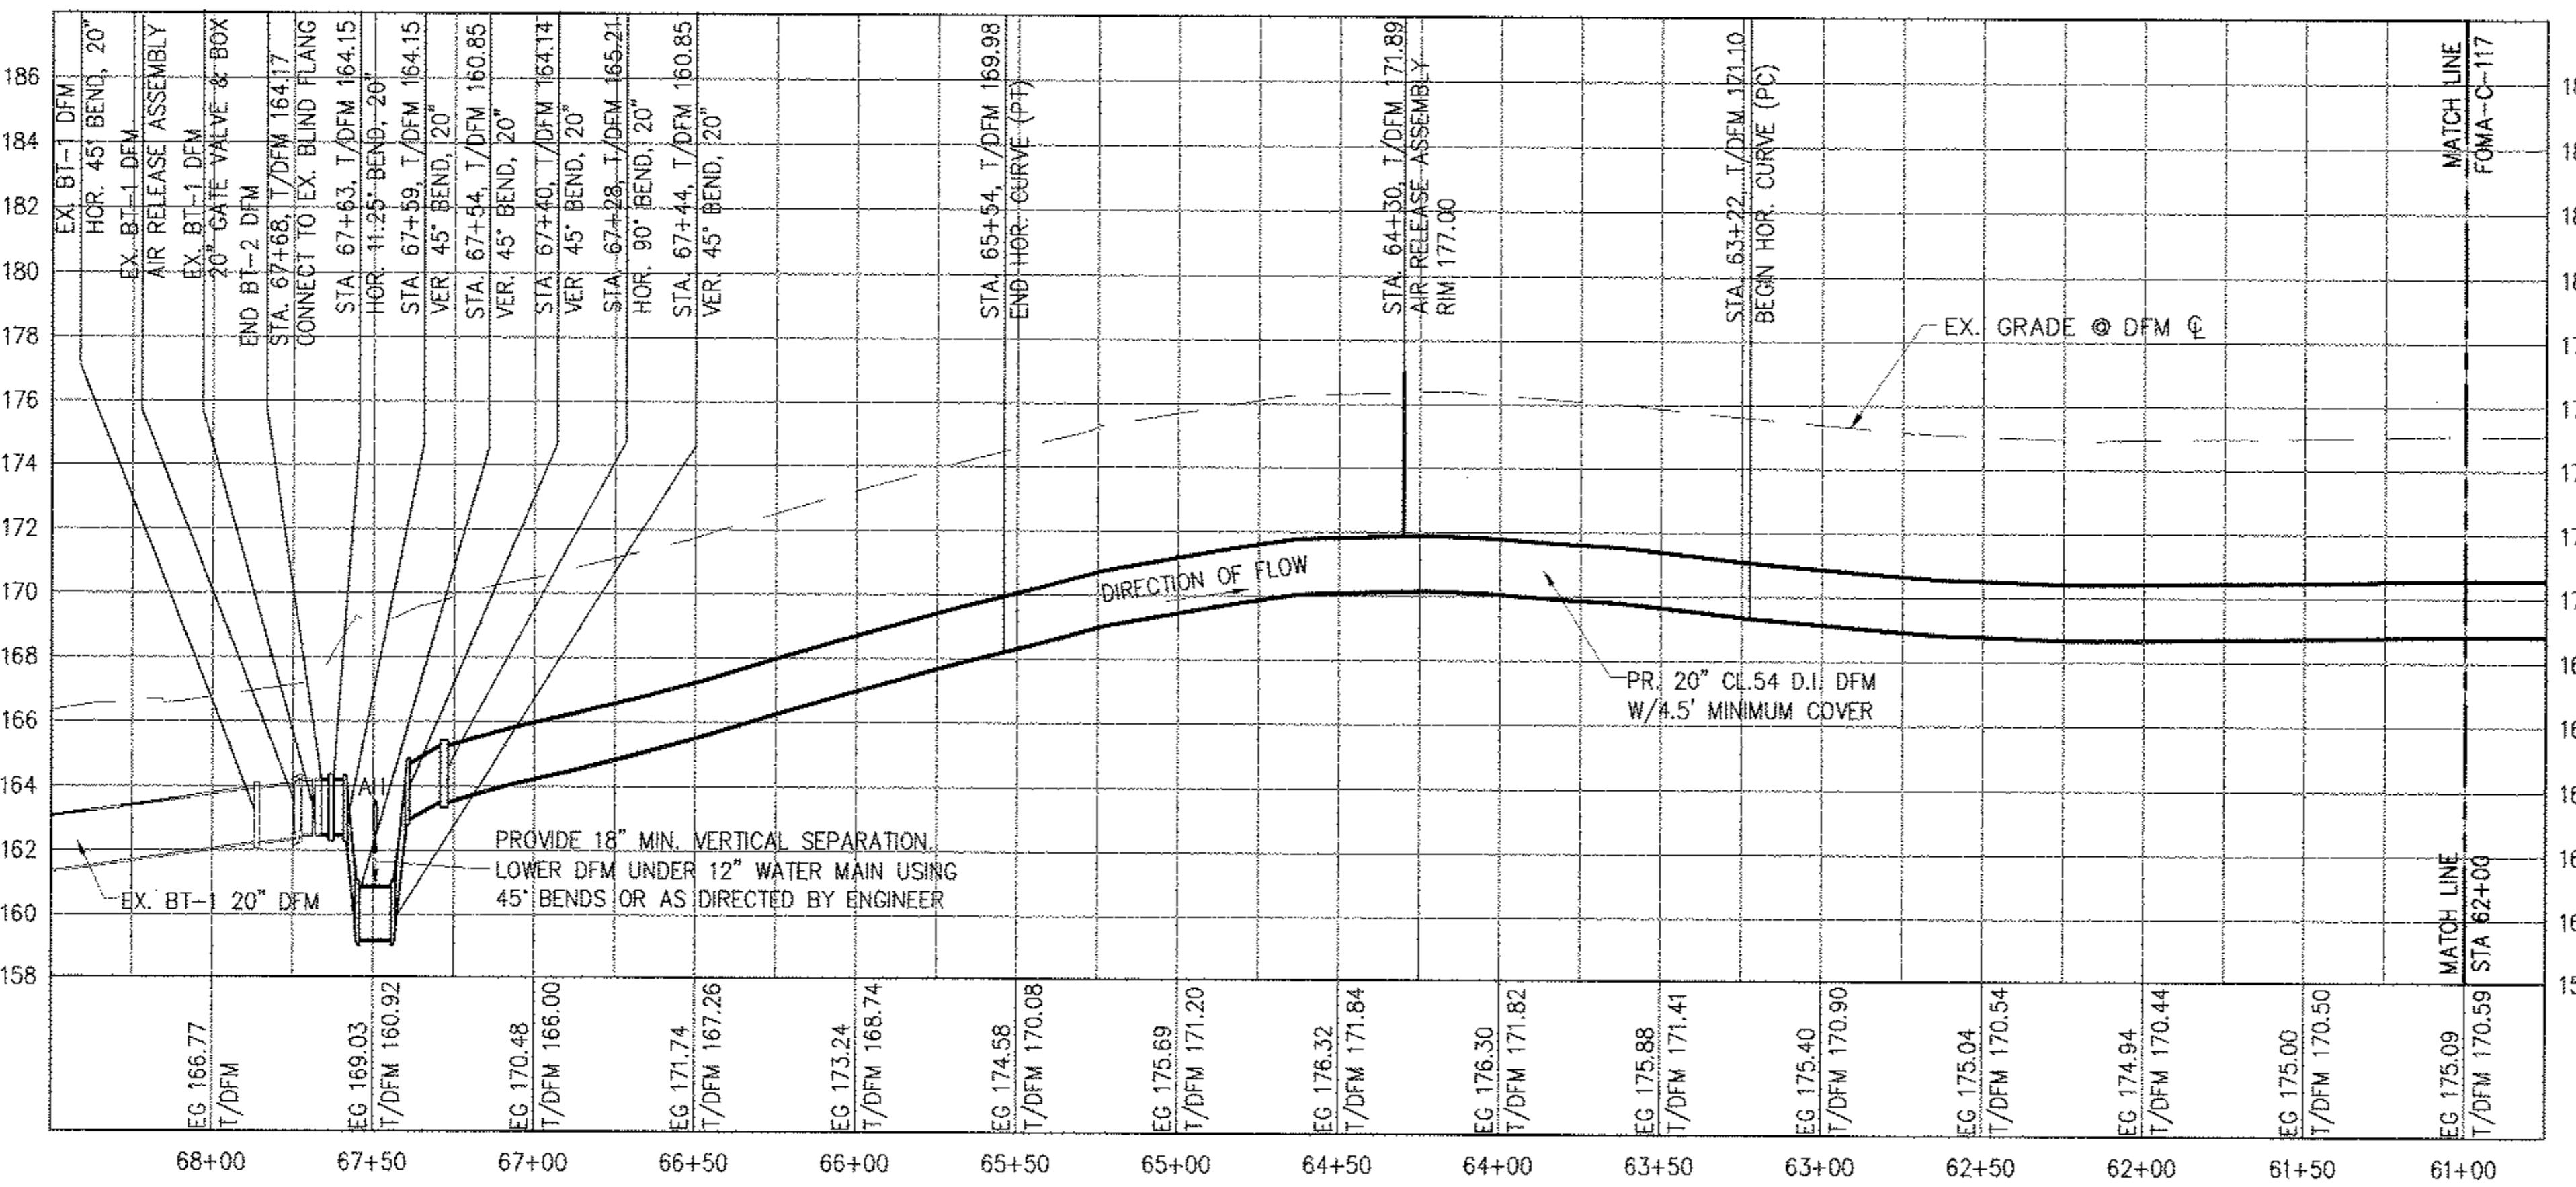
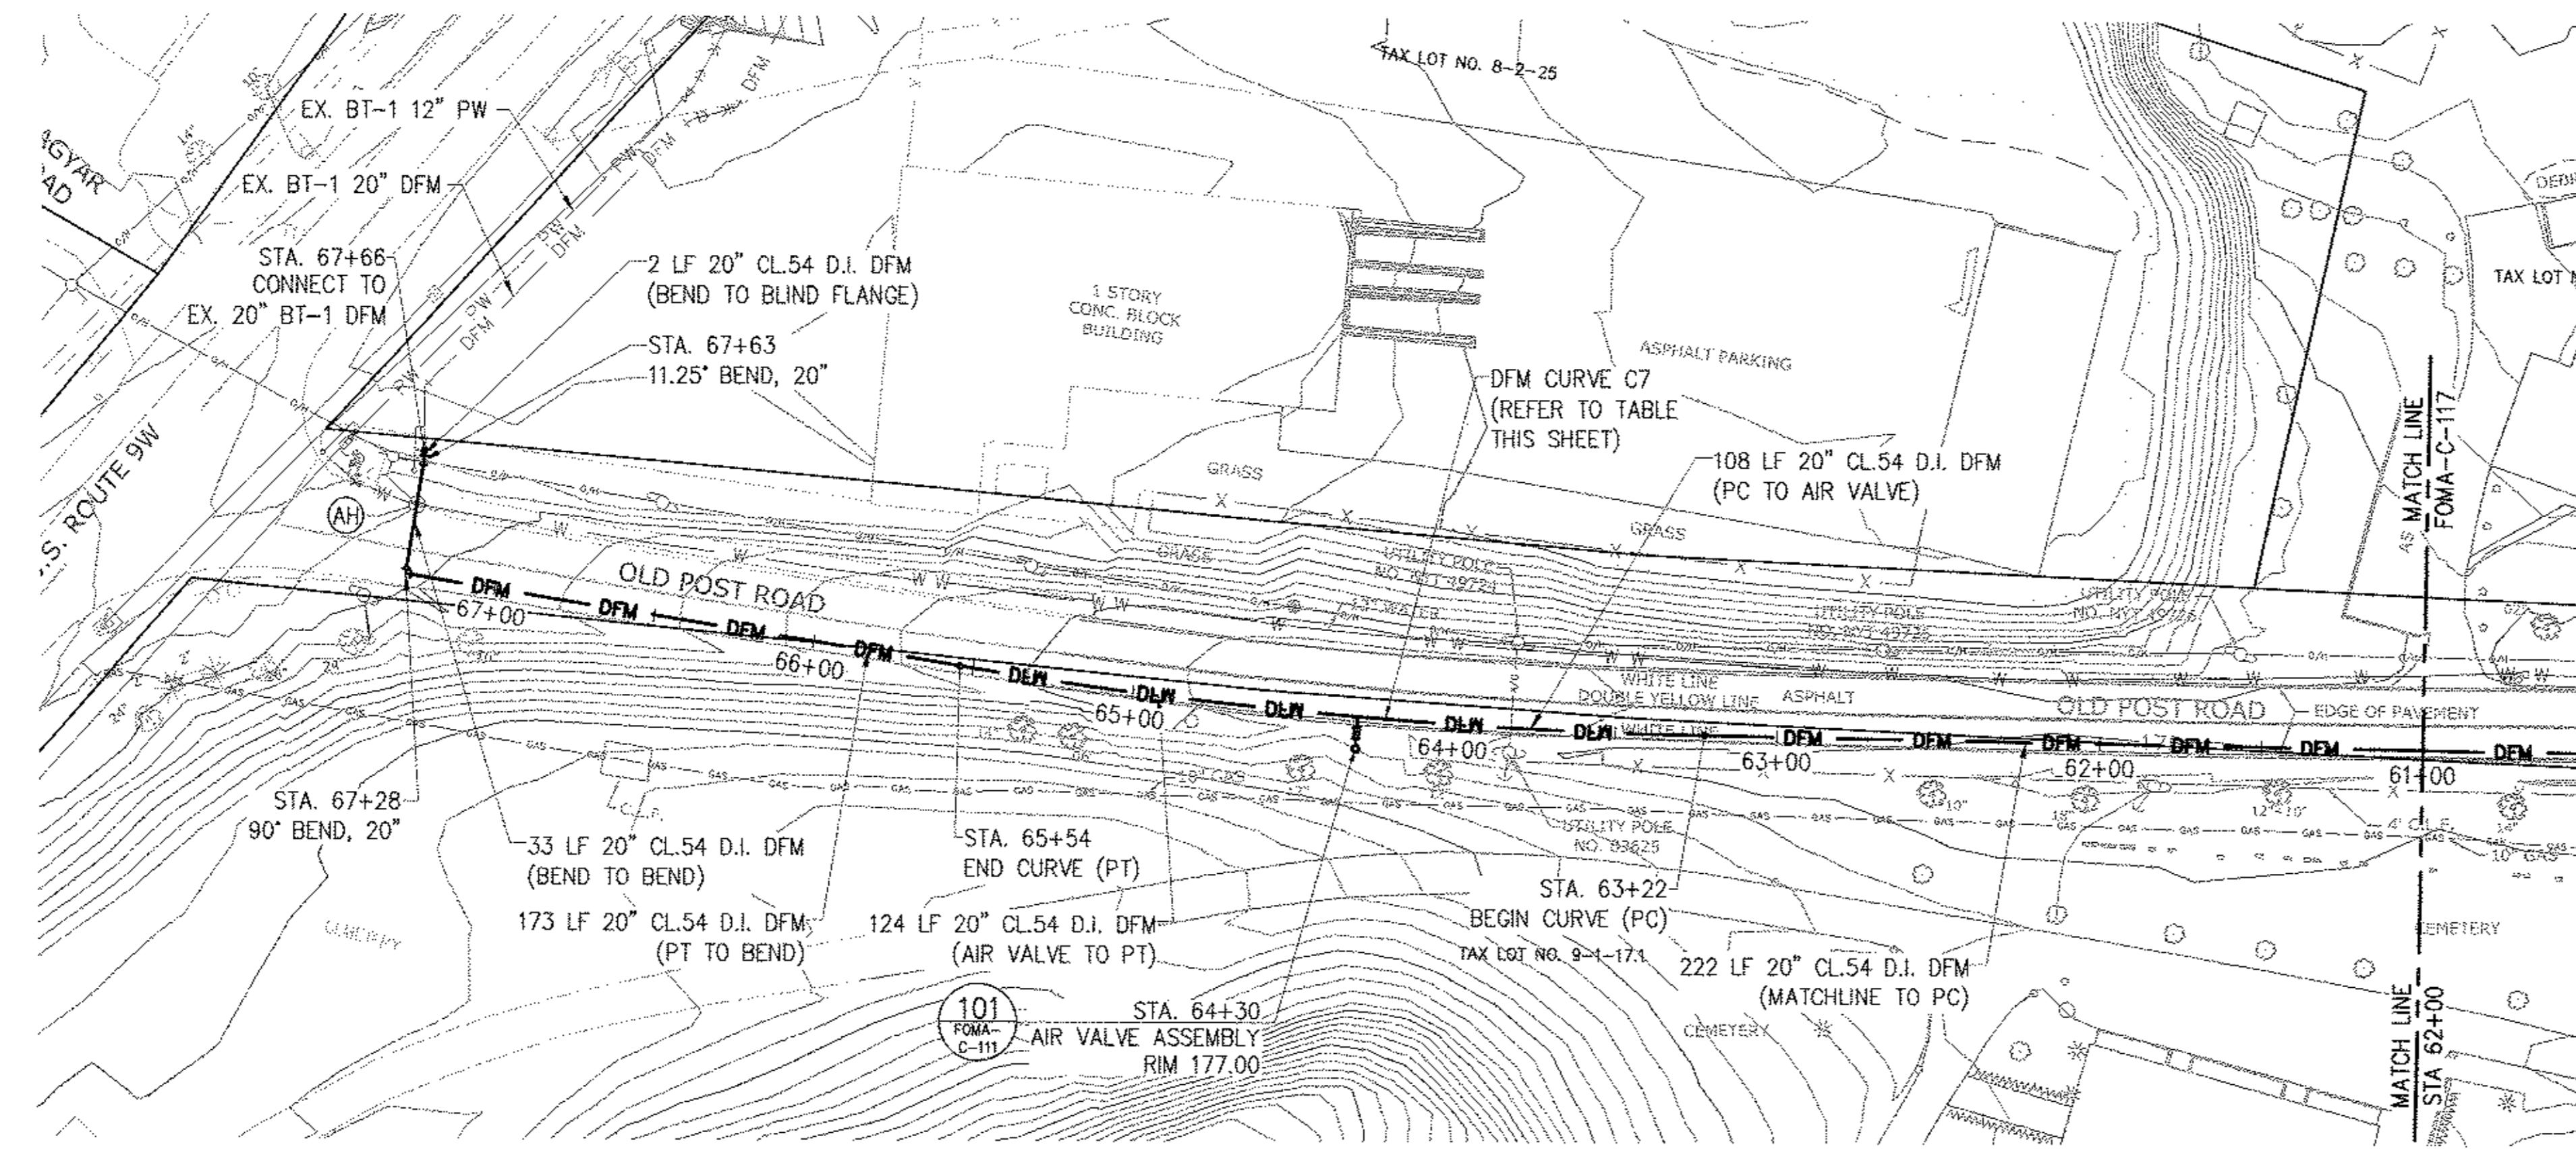
**RONDOUT WEST BRANCH BYPASS TUNNEL
CONSTRUCTION AND WAWARSING REPAIRS,
DELAWARE AQUEDUCT
FORCE MAIN
PIPING PLAN & PROFILE
STA 55+00 TO STA 62+00**

DATE: 11/22/2013
TITLE: AS NOTED
STREET NO:
1 OF 453
DRAWING NO.
DMA-C-119.00



| | |
|--------------------|--|
| DESIGNED BY: GM | DRAWN BY: GM |
| CHECKED BY: FP | NYC Water & Future <small>Environmental Protection</small> |
| DESIGN LEAD: GM | |
| PPR'D. | |
| SECTION CHIEF: | |

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Last Saved By & Date: EugeneL Tuesday, February 04, 2014 and Date Plotted: Thursday, February 06, 2014
 Paper Size: ANSI D (34.00 x 22.00 Inches) Plot Scale: 1:1 Plot Style Table: BDC_22x34_Fill_Size.ctb
 Drawing Name & Location: B:\BVS\RM\2014\2014\Design_Files\02_Archived\02_Design\06_Bell_Property_Permitting_Dwg's\Task No. 1.13_Force_Main...5B\02_Civil\FOMA-C-120.00.dwg

CONTRACT BT2

| UTILITY CROSSING SCHEDULE | | | | |
|---------------------------|---------|----------------|---------------|--------------------|
| NAME | STATION | DESCRIPTION | DFM ELEVATION | CROSSING ELEVATION |
| AH | 67+49 | 12" WATER MAIN | T/P 160.92 | B/P 162.42± (VIF) |

| DFM CURVE SCHEDULE | | | | | | | | | |
|--------------------|---------------|-------------|----------|--------------|----------------|---------------|---------------------------|-------------------------|--|
| CURVE # | START STATION | END STATION | RADIUS | CURVE LENGTH | TOTAL ANGLE, Δ | LAYING LENGTH | JOINT DEFLECTION ANGLE, θ | JOINT DEFLECTION OFFSET | |
| C7 | 63+22 | 65+54 | 1629.00' | 231.67' | 8'08"54" | 20' | 0'42"12" | 0.25' | |

VERTICAL 0 4 8 FT.
 1"=4'
 HORIZONTAL 0 40 80 FT.
 1"=40'

BELL PROPERTY
SITE DESIGN
DATE SUBMITTED: 02/10/2014

GRAPHIC SCALES
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RONDOUT WEST BRANCH BYPASS TUNNEL
CONSTRUCTION AND WAWARSH REPAIRS,
DELAWARE AQUEDUCT
FORCE MAIN
PIPING PLAN & PROFILE
STA 62+00 TO P.O.E.


DATE: 1/22/2013
 SCALE: AS NOTED
 SHEET NO.
 1 OF 453
 DRAWING NO.
 FOMA-C-120.00

DESIGNED BY:
GM
DRAWN BY:
GM
CHECKED BY:
FP
NYC Water Future
Environmental Protection
DESIGN LEAD:
GM
SECTION CHIEF:
FP

NYC
Environmental
Protection

PROJECT MANAGER
TED DOWNEY
CHIEF, TUNNEL DESIGN
BURJAR KHARIVALA
DIRECTOR, IN-HOUSE DESIGN
PATRICK O'CONNOR

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SOIL BORING TABLE: DF
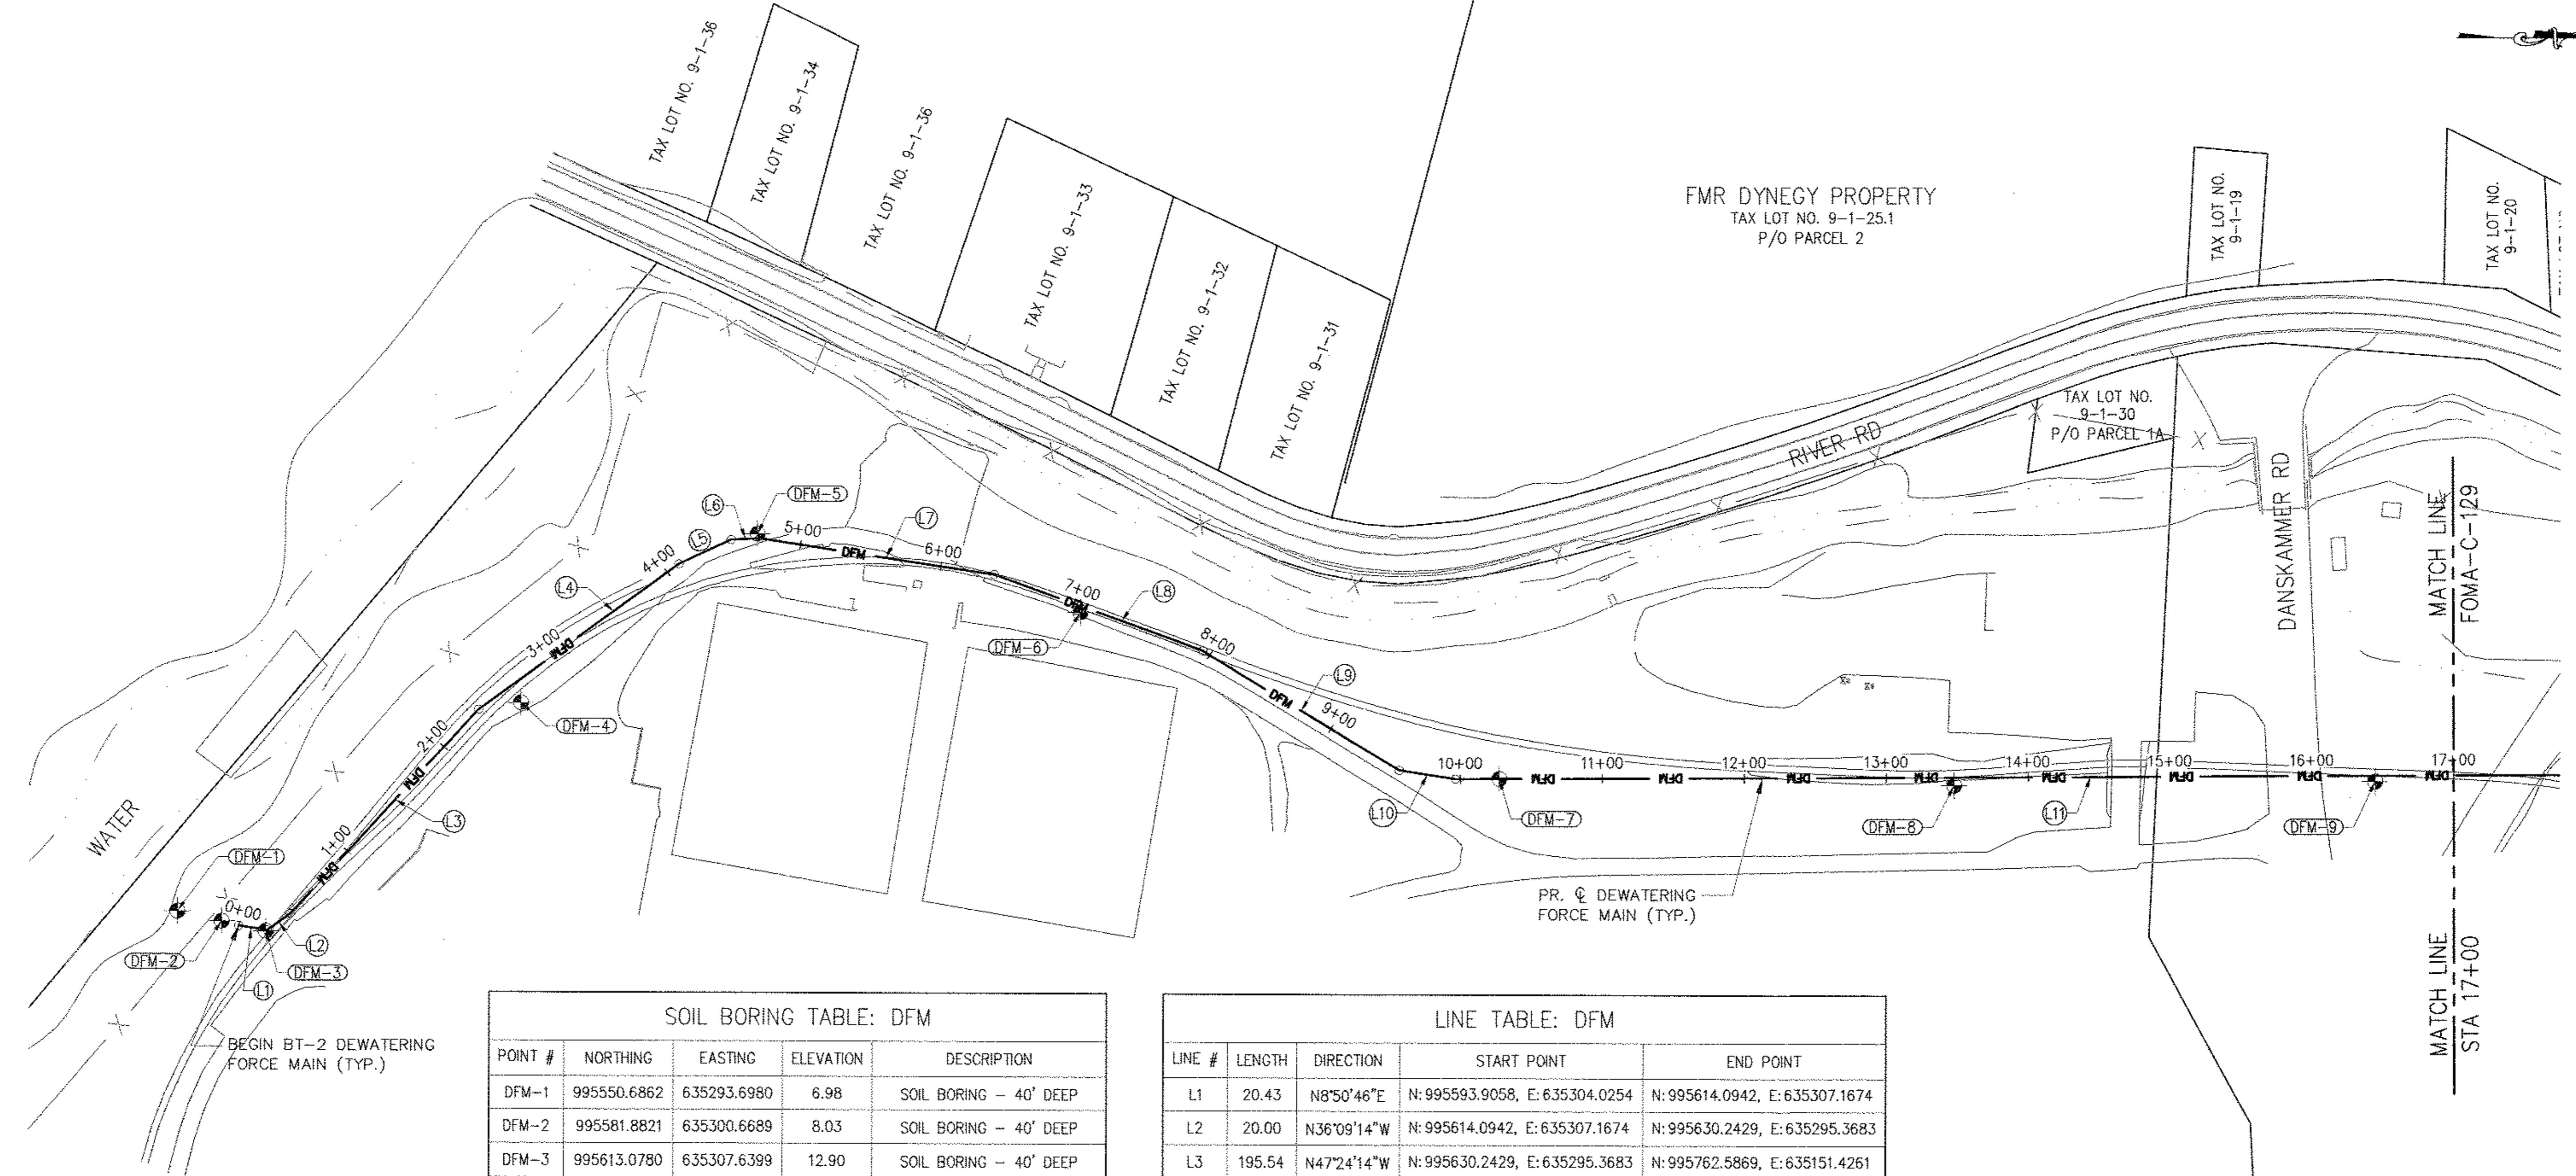
| SOIL BORING TABLE: DFM | | | | |
|------------------------|-------------|-------------|-----------|------------------------|
| POINT # | NORTHING | EASTING | ELEVATION | DESCRIPTION |
| DFM-1 | 995550.6862 | 635293.6980 | 6.98 | SOIL BORING - 40' DEEP |
| DFM-2 | 995581.8821 | 635300.6689 | 8.03 | SOIL BORING - 40' DEEP |
| DFM-3 | 995613.0780 | 635307.6399 | 12.90 | SOIL BORING - 40' DEEP |
| DFM-4 | 995792.3761 | 635146.2452 | 13.92 | SOIL BORING - 12' DEEP |
| DFM-5 | 995958.4961 | 635027.5271 | 12.71 | SOIL BORING - 12' DEEP |
| DFM-6 | 996186.3375 | 635081.9245 | 13.11 | SOIL BORING - 12' DEEP |
| DFM-7 | 996481.7674 | 635198.0870 | 12.98 | SOIL BORING - 12' DEEP |
| DFM-8 | 996802.2859 | 635201.9895 | 16.27 | SOIL BORING - 12' DEEP |
| DFM-9 | 997098.9993 | 635198.8075 | 19.03 | SOIL BORING - 12' DEEP |


LINE TABLE: DFM

LINE TABLE: DFM

| LINE # | LENGTH | DIRECTION | START POINT | END POINT |
|--------|--------|-------------|--------------------------------|--------------------------------|
| L1 | 20.43 | N8°50'46"E | N: 995593.9058, E: 635304.0254 | N: 995614.0942, E: 635307.1674 |
| L2 | 20.00 | N36°09'14"W | N: 995614.0942, E: 635307.1674 | N: 995630.2429, E: 635295.3683 |
| L3 | 195.54 | N47°24'14"W | N: 995630.2429, E: 635295.3683 | N: 995762.5869, E: 635151.4261 |
| L4 | 174.10 | N36°09'14"W | N: 995762.5869, E: 635151.4261 | N: 995903.1623, E: 635048.7144 |
| L5 | 40.40 | N24°54'14"W | N: 995903.1623, E: 635048.7144 | N: 995939.8057, E: 635031.7021 |
| L6 | 20.42 | N2°44'48"W | N: 995939.8057, E: 635031.7021 | N: 995960.2042, E: 635030.7235 |
| L7 | 167.07 | N8°30'12"E | N: 995960.2042, E: 635030.7235 | N: 996125.4394, E: 635055.4276 |
| L8 | 156.36 | N19°45'12"E | N: 996125.4394, E: 635055.4276 | N: 996272.5940, E: 635108.2709 |
| L9 | 162.10 | N31°11'21"E | N: 996272.5940, E: 635108.2709 | N: 996411.2636, E: 635192.2166 |
| L10 | 40.00 | N8°41'21"E | N: 996411.2636, E: 635192.2166 | N: 996450.8045, E: 635198.2596 |
| L11 | 782.19 | N0°19'10"W | N: 996450.8045, E: 635198.2596 | N: 997232.9842, E: 635193.9003 |

S OF BEARING:

1. HORIZONTAL DATUM IS NAD-83-96, NEW YORK STATE PLANE COORDINATE SYSTEM, ZONE 3101 (NEW YORK EAST).
 2. ALL BEARINGS ARE IN THE DIRECTION OF STATIONING.

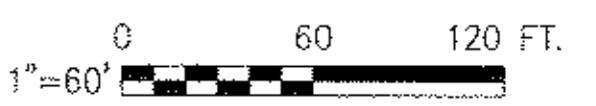



BELL PROPERTY SITE DESIGN

DATE SUBMITTED:02/10/2014

GRAPHIC SCALES
CHECK BEFORE USE

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SCALE ACCORDINGLY
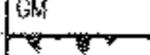
| | |
|-------------|--|
| SIGNED BY: | DRAWN BY: GM |
| CHECKED BY: |  WEC Water Environmental |
| SIGN LEAD: | |

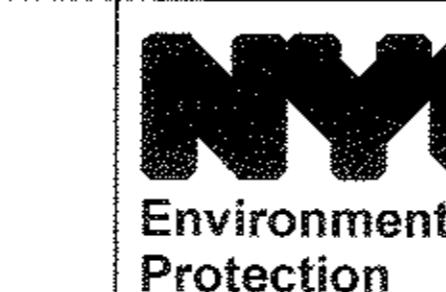

| | |
|---|--------------------|
|  | PROJECT MANAGER |
| | TED DOWEY |
| | CHIEF, TUNNEL DES. |
| | BURJAR KHARIVALA |
| DIRECTOR, IN-HOUSE | PATRICK O'CONNOR |


DESIGN

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96-05 HORACE HARDING EXPRESSWAY 5th FLOOR
CORONA, NEW YORK 11368
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**RONDOUT WEST BRANCH BYPASS TUNNEL
CONSTRUCTION AND WAWARSING REPAIRS,
DELAWARE AQUEDUCT
FORCE MAIN
HORIZONTAL CONTROL & BORING PLAN
P.O.B. TO STA 17+00**

DATE: 11/22/2013
SCALE: 1"=60'-0"
SHEET NO.:
1 OF 453
DRAWING NO.
DMA-C-125.00



| SOIL BORING TABLE: DFM | | | | |
|------------------------|-------------|-------------|-----------|------------------------|
| POINT # | NORTHING | EASTING | ELEVATION | DESCRIPTION |
| DFM-10 | 997408.3267 | 635194.9377 | 16.56 | SOIL BORING - 12' DEEP |
| DFM-11 | 997518.6475 | 635105.6415 | 16.58 | SOIL BORING - 20' DEEP |
| DFM-12 | 997531.6372 | 635048.1176 | 14.75 | SOIL BORING - 20' DEEP |
| DFM-13 | 997545.3927 | 634980.4867 | 16.90 | SOIL BORING - 20' DEEP |
| DFM-14 | 997612.7123 | 634705.5046 | 101.40 | SOIL BORING - 6' DEEP |
| DFM-15 | 997881.3723 | 634575.2810 | 134.11 | SOIL BORING - 6' DEEP |
| DFM-16 | 998123.0371 | 634599.4336 | 151.40 | SOIL BORING - 6' DEEP |
| DFM-17 | 998357.9292 | 634498.2833 | 144.86 | SOIL BORING - 6' DEEP |
| DFM-18 | 998645.6129 | 634437.5152 | 109.41 | SOIL BORING - 20' DEEP |

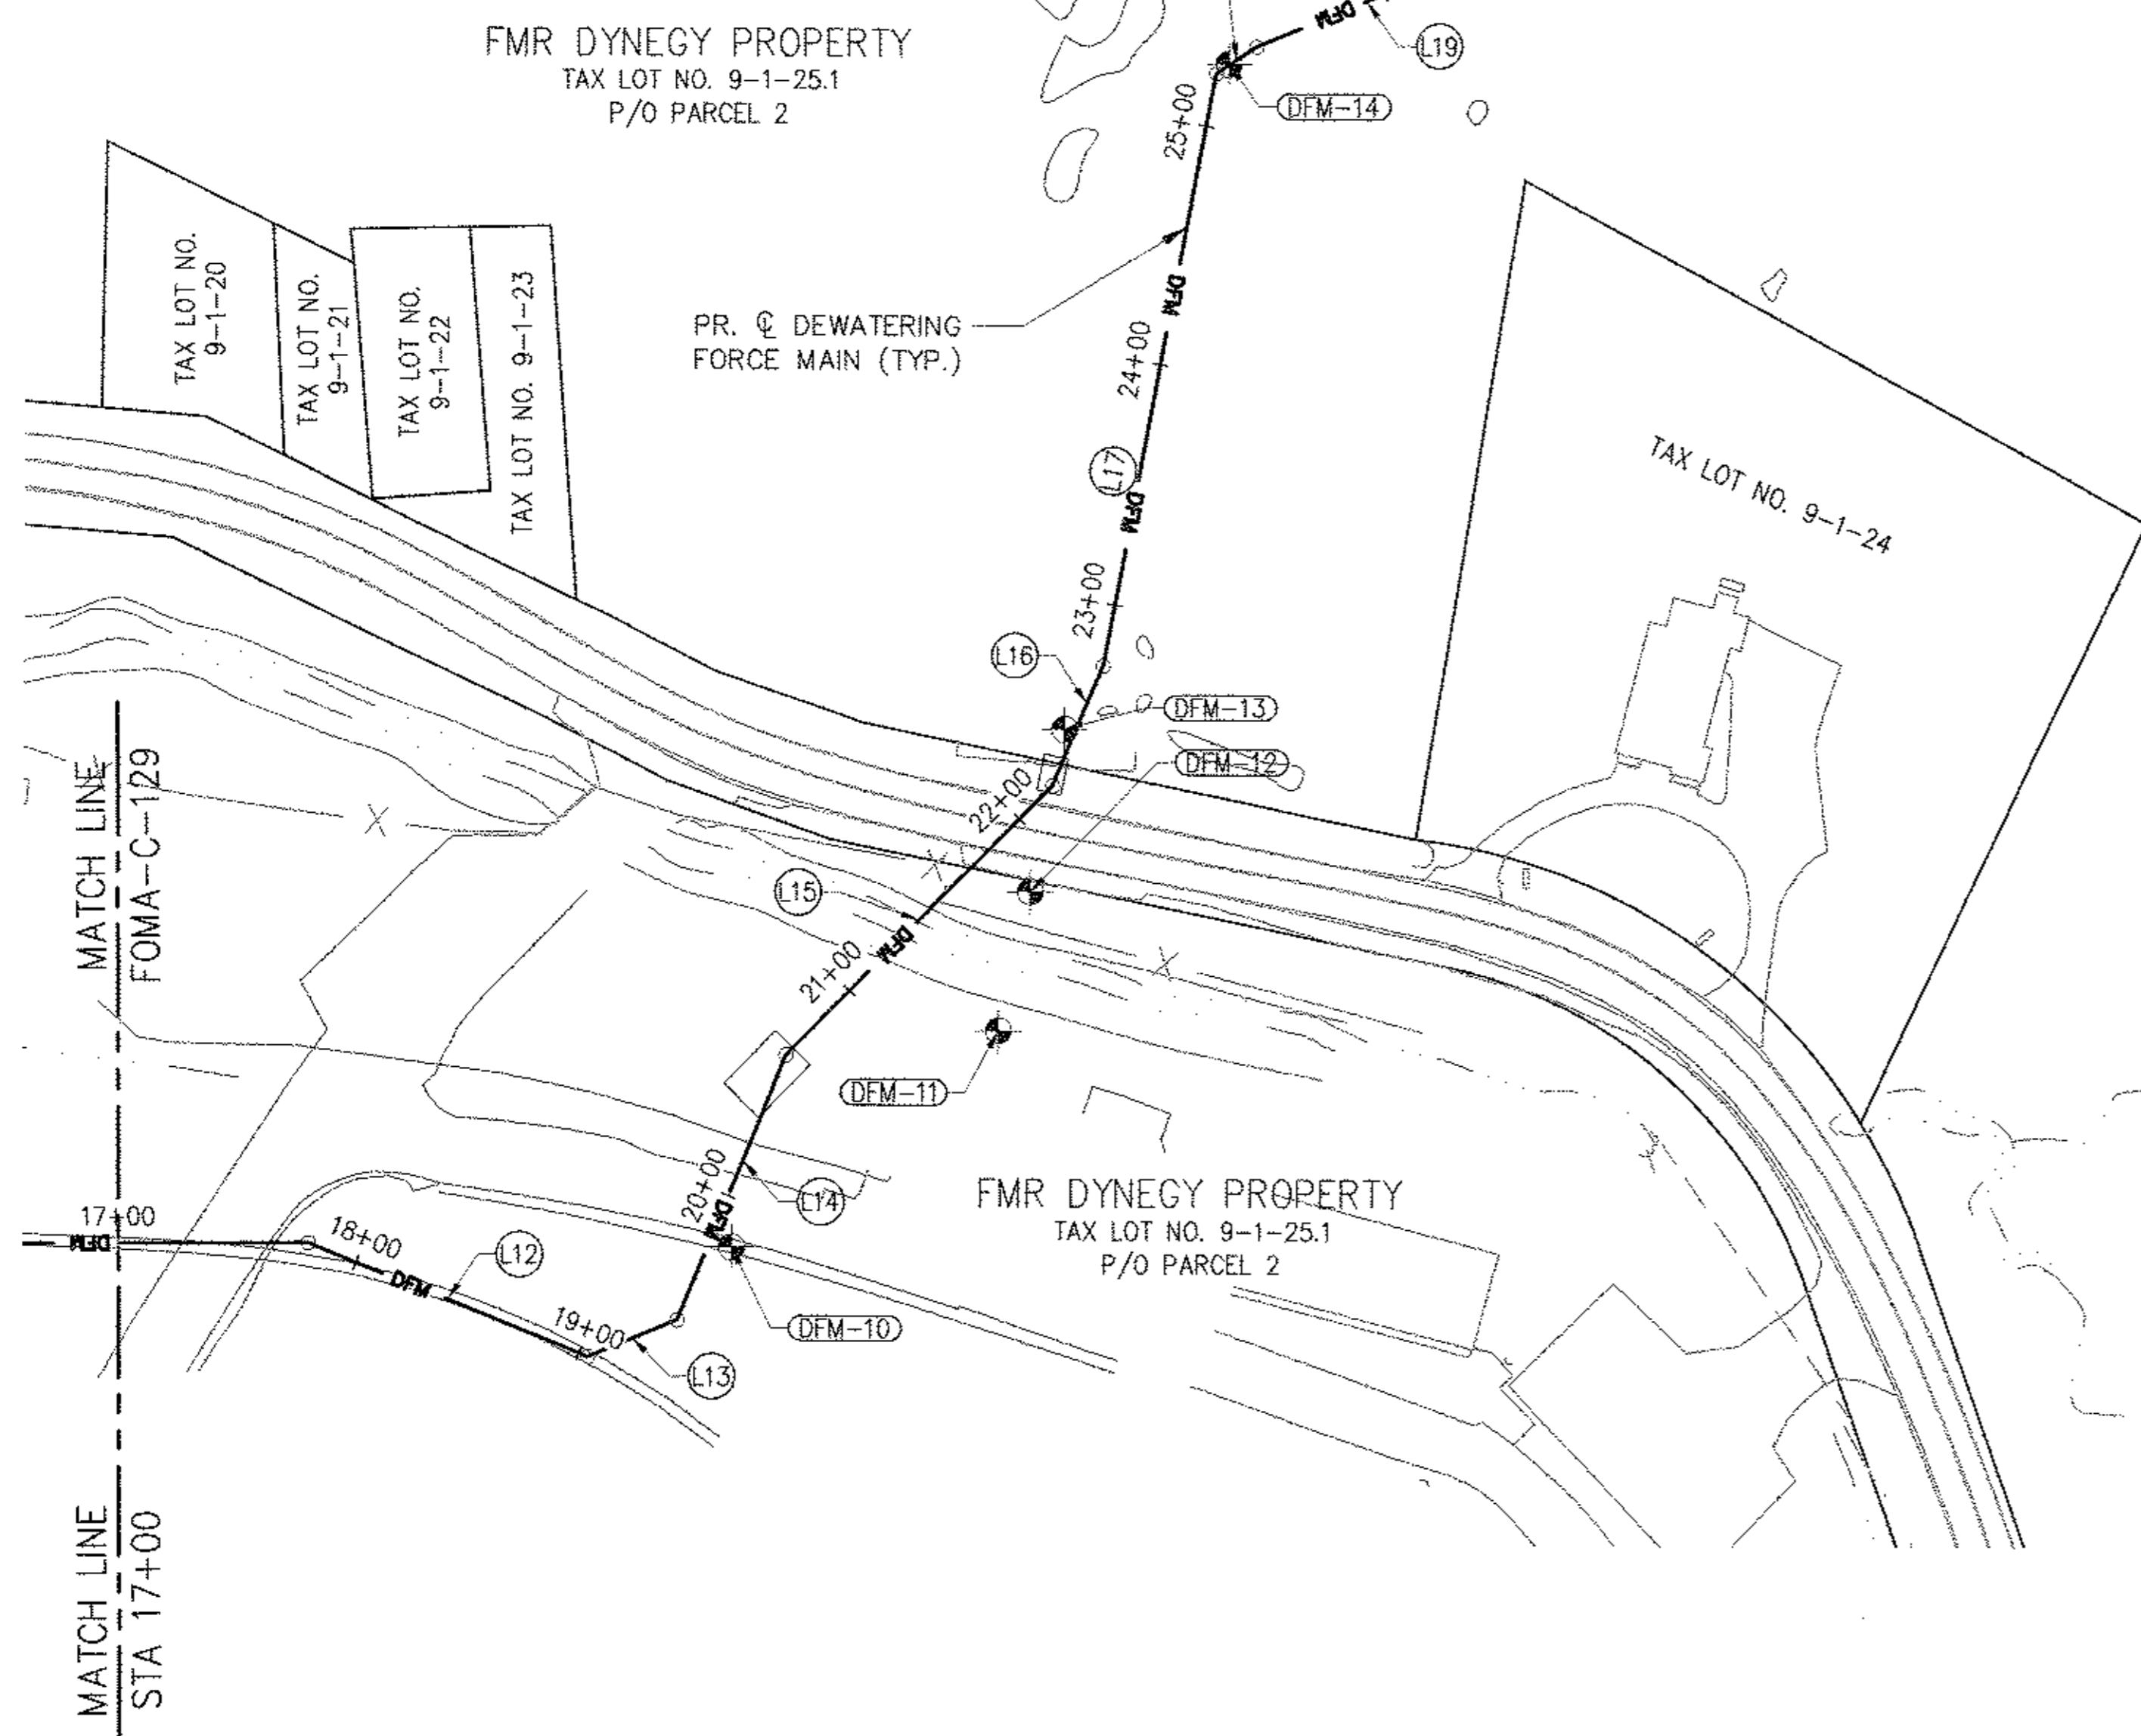BASIS OF BEARING:

1. HORIZONTAL DATUM IS NAD-83-96, NEW YORK STATE PLANE COORDINATE SYSTEM, ZONE 3101 (NEW YORK EAST).
2. ALL BEARINGS ARE IN THE DIRECTION OF STATIONING.

| LINE TABLE: DFM | | | | |
|-----------------|--------|-------------|--------------------------------|--------------------------------|
| LINE # | LENGTH | DIRECTION | START POINT | END POINT |
| L12 | 125.28 | N22°10'50"E | N: 997232.9842, E: 635193.9003 | N: 997348.9918, E: 635241.1965 |
| L13 | 40.00 | N22°49'10"W | N: 997348.9918, E: 635241.1965 | N: 997385.8611, E: 635225.6834 |
| L14 | 118.47 | N67°49'10"W | N: 997385.8611, E: 635225.6834 | N: 997430.5861, E: 635115.9825 |
| L15 | 157.05 | N45°31'10"W | N: 997430.5861, E: 635115.9825 | N: 997540.6246, E: 635003.9300 |
| L16 | 54.45 | N67°43'59"W | N: 997540.6246, E: 635003.9300 | N: 997561.2552, E: 634953.5447 |
| L17 | 248.45 | N79°17'06"W | N: 997561.2552, E: 634953.5447 | N: 997607.4475, E: 634709.4273 |
| L18 | 20.00 | N34°17'06"W | N: 997607.4475, E: 634709.4273 | N: 997623.9724, E: 634698.1611 |
| L19 | 99.21 | N23°02'06"W | N: 997623.9724, E: 634698.1611 | N: 997715.2676, E: 634659.3426 |
| L20 | 49.58 | N45°32'06"W | N: 997715.2676, E: 634659.3426 | N: 997749.9983, E: 634623.9571 |
| L21 | 92.23 | N23°02'06"W | N: 997749.9983, E: 634623.9571 | N: 997834.8781, E: 634587.8665 |
| L22 | 40.00 | N0°32'06"W | N: 997834.8781, E: 634587.8665 | N: 997874.8763, E: 634587.4929 |
| L23 | 132.10 | N10°42'54"E | N: 997874.8763, E: 634587.4929 | N: 998004.6718, E: 634612.0531 |
| L24 | 67.91 | N12°37'26"W | N: 998004.6718, E: 634612.0531 | N: 998070.9424, E: 634597.2109 |
| L25 | 159.59 | N2°26'35"E | N: 998070.9424, E: 634597.2109 | N: 998230.3922, E: 634604.0142 |
| L26 | 125.30 | N42°33'25"W | N: 998230.3922, E: 634604.0142 | N: 998322.6903, E: 634519.2700 |
| L27 | 40.00 | N31°18'25"W | N: 998322.6903, E: 634519.2700 | N: 998356.8661, E: 634498.4851 |
| L28 | 77.15 | N10°45'07"W | N: 998356.8661, E: 634498.4851 | N: 998432.6652, E: 634484.0915 |
| L29 | 125.65 | N13°30'12"W | N: 998432.6652, E: 634484.0915 | N: 998554.8391, E: 634454.7525 |
| L30 | 163.00 | N10°45'07"W | N: 998554.8391, E: 634454.7525 | N: 998714.9744, E: 634424.3440 |

0 60 120 FT.
1"=60'

BELL PROPERTY
SITE DESIGN
DATE SUBMITTED: 02/10/2014

GRAPHIC SCALES
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RONDOUT WEST BRANCH BYPASS TUNNEL
CONSTRUCTION AND WAWARSING REPAIRS,
DELAWARE AQUEDUCT
FORCE MAIN
HORIZONTAL CONTROL & BORING PLAN
STA. 17+00 TO STA. 37+00

DATE: 1/22/2013
SCALE: 1"=60'-0"
SHEET NO:
1 OF 453
DRAWING NO.
FOMA-C-126.00




PROJECT MANAGER
TED DOWNEY
CHIEF, TUNNEL DESIGN
BURJOR KHARIVALA
DIRECTOR, IN-HOUSE DESIGN
PATRICK O'CONNOR

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BUREAU OF ENGINEERING DESIGN & CONSTRUCTION
96-05 HORACE HARDING EXPRESSWAY 5th FLOOR
CORONA, NEW YORK 11368
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CONTRACT BT2

| NO. | DATE | DESCRIPTION | APPR'D. | SECTION CHIEF: | REVISIONS |
|-----|------|-------------|---------|----------------|-----------|
| | | | | FP | |



| SOIL BORING TABLE: DFM | | | | |
|------------------------|-------------|-------------|-----------|------------------------|
| POINT # | NORTHING | EASTING | ELEVATION | DESCRIPTION |
| DFM-19 | 998763.1133 | 634151.8769 | 121.82 | SOIL BORING - 12' DEEP |
| DFM-20 | 998839.4997 | 633856.6139 | 136.72 | SOIL BORING - 12' DEEP |
| DFM-21 | 998921.9471 | 633562.9707 | 149.11 | SOIL BORING - 12' DEEP |
| DFM-22 | 998870.0595 | 633292.0275 | 157.58 | SOIL BORING - 20' DEEP |
| DFM-23 | 998711.4768 | 633029.0849 | 161.46 | SOIL BORING - 12' DEEP |
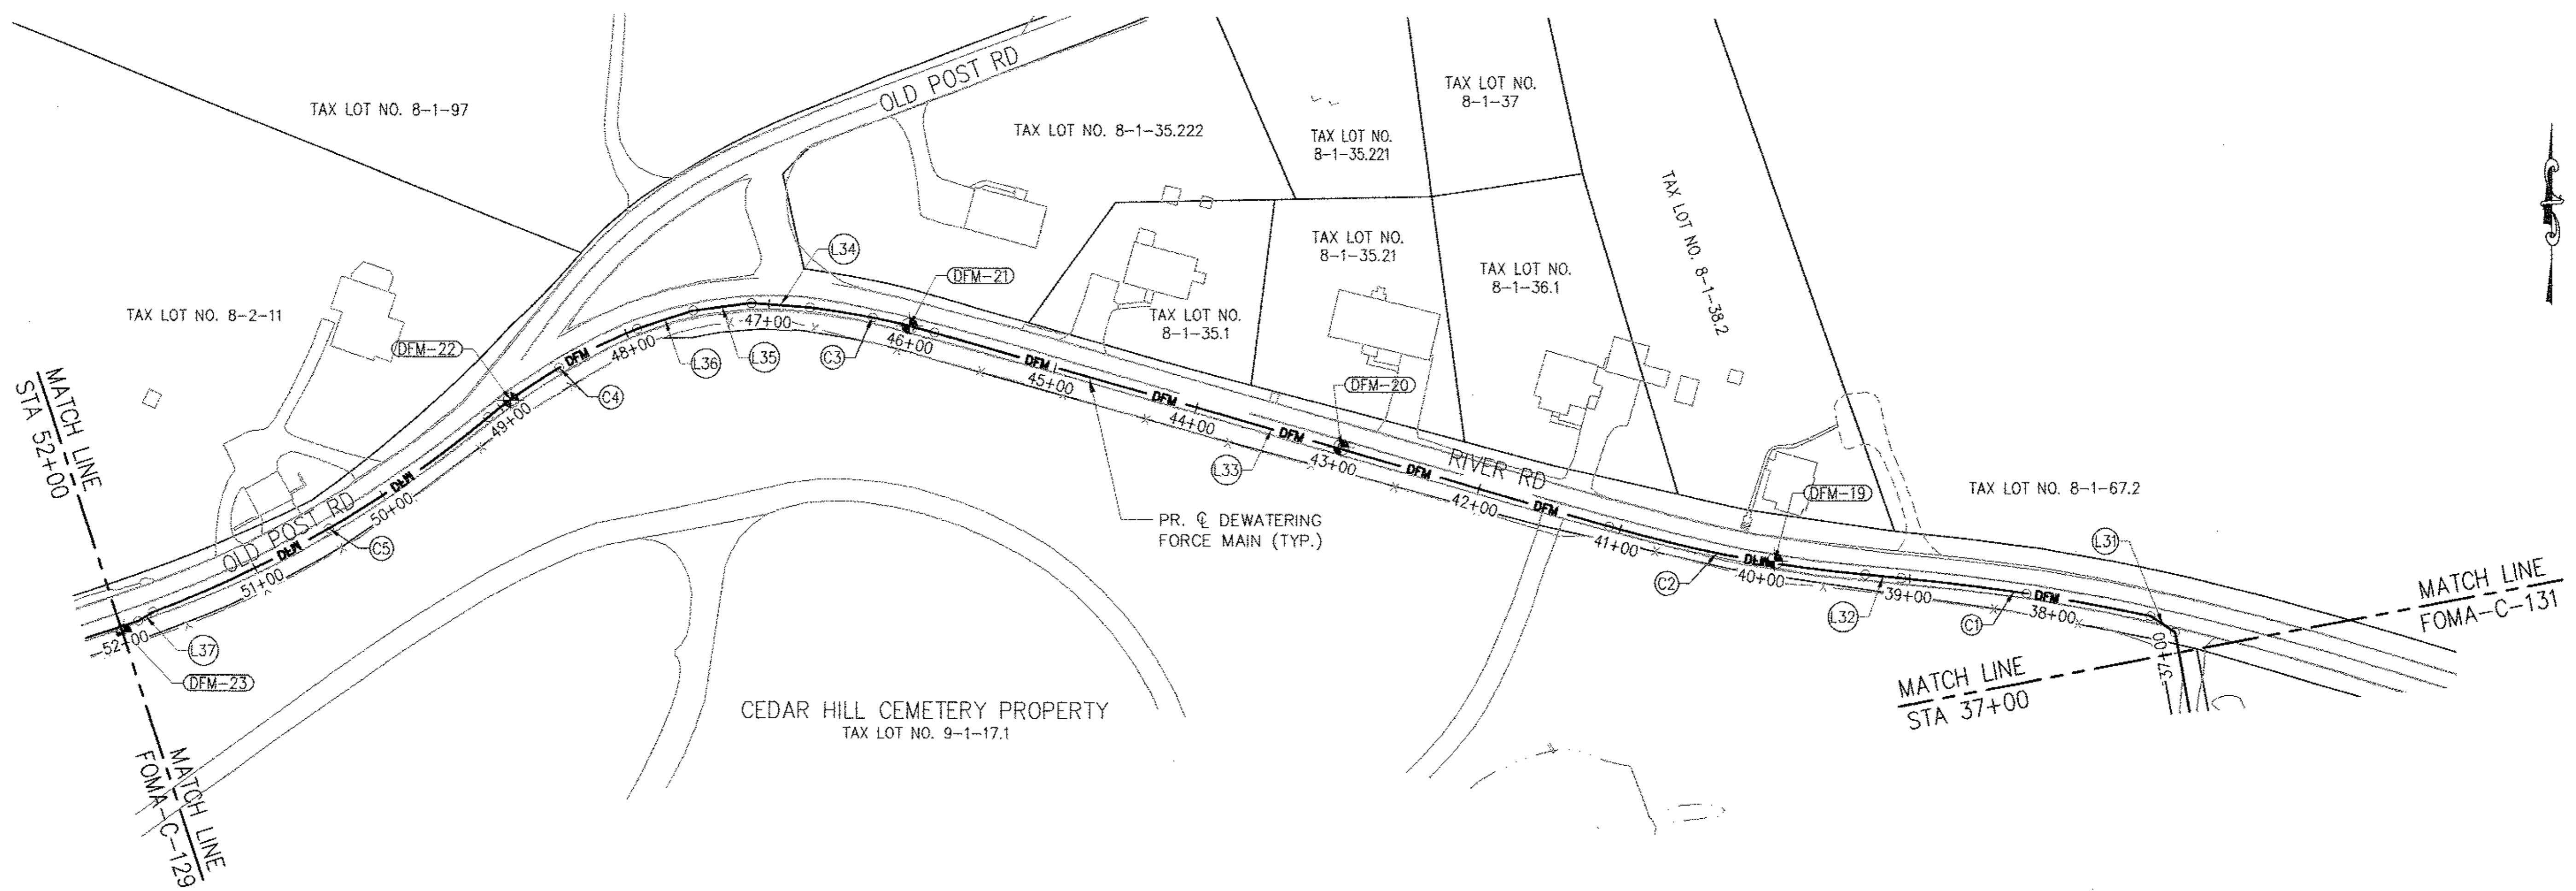
| LINE TABLE: DFM | | | | |
|-----------------|--------|-------------|--------------------------------|--------------------------------|
| LINE # | LENGTH | DIRECTION | START POINT | END POINT |
| L31 | 20.00 | N56°06'56"W | N: 998714.9744, E: 634424.3440 | N: 998726.1248, E: 634407.7408 |
| L32 | 24.51 | N84°53'10"W | N: 998751.8304, E: 634237.9653 | N: 998754.0147, E: 634213.5574 |
| L33 | 477.68 | N74°04'37"W | N: 998786.4083, E: 634039.0901 | N: 998917.4578, E: 633579.7362 |
| L34 | 40.00 | N86°06'21"W | N: 998934.3960, E: 633495.1616 | N: 998937.1125, E: 633455.2540 |
| L35 | 40.00 | S82°38'39"W | N: 998937.1125, E: 633455.2540 | N: 998931.9912, E: 633415.5832 |
| L36 | 40.00 | S71°23'39"W | N: 998931.9912, E: 633415.5832 | N: 998919.2292, E: 633377.6743 |
| L37 | 11.55 | S58°05'11"W | N: 998725.2419, E: 633048.8615 | N: 998719.1380, E: 633039.0604 |

| CURVE TABLE: DFM | | | | | | |
|------------------|---------|--------|-----------------|--------------|--------------------------------|--------------------------------|
| CURVE # | RADIUS | LENGTH | CHORD DIRECTION | CHORD LENGTH | START POINT | END POINT |
| C1 | 1408.00 | 171.82 | N81°23'25"W | 171.71 | N: 998726.1248, E: 634407.7408 | N: 998751.8304, E: 634237.9653 |
| C2 | 942.00 | 177.71 | N79°28'54"W | 177.45 | N: 998754.0147, E: 634213.5574 | N: 998786.4083, E: 634039.0901 |
| C3 | 538.00 | 86.35 | N78°40'30"W | 86.25 | N: 998917.4578, E: 633579.7362 | N: 998934.3960, E: 633495.1616 |
| C4 | 383.00 | 118.69 | S58°56'05"W | 118.21 | N: 998919.2292, E: 633377.6743 | N: 998858.2309, E: 633276.4173 |

BASIS OF BEARING:

1. HORIZONTAL DATUM IS NAD-83-96, NEW YORK STATE PLANE COORDINATE SYSTEM, ZONE 3101 (NEW YORK EAST).
2. ALL BEARINGS ARE IN THE DIRECTION OF STATIONING.

0 60 120 FT.
1"=60'

BELL PROPERTY
SITE DESIGN
DATE SUBMITTED: 02/10/2014

GRAPHIC SCALES
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DELAWARE AQUEDUCT
FORCE MAIN
HORIZONTAL CONTROL & BORING PLAN
STA. 37+00 TO STA. 52+00
FOMA-C-127.00

DATE: 11/22/2013
SCALE: 1/8"=1'-0"
SHEET NO:
1 OF 453
DRAWING NO.
FOMA-C-127.00

DESIGNED BY:
GM
CHECKED BY:
FP
DESIGN LEAD:
GM
NO. DATE DESCRIPTION APPR'D
REVISIONS
FP


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GM
NYC Water & Future Environmental Protection
Environmental Protection

NYC
Environmental Protection

PROJECT MANAGER
TED DONLEY
CHIEF, TUNNEL DESIGN
BURJOR KHARIVALA
DIRECTOR, IN-HOUSE DESIGN
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CEDAR HILL CEMETERY PROPERTY
TAX LOT NO. 9-1-17.1

| SOIL BORING TABLE: DFM | | | | |
|------------------------|-------------|-------------|-----------|------------------------|
| POINT # | NORTHING | EASTING | ELEVATION | DESCRIPTION |
| DFM-24 | 998614.6572 | 632746.0672 | 165.95 | SOIL BORING - 12' DEEP |
| DFM-25 | 998540.2608 | 632479.9683 | 171.74 | SOIL BORING - 12' DEEP |
| DFM-26 | 998455.0006 | 632162.9758 | 174.80 | SOIL BORING - 12' DEEP |
| DFM-27 | 998374.1432 | 631847.1703 | 176.59 | SOIL BORING - 12' DEEP |
| DFM-28 | 998332.4764 | 631557.1363 | 169.98 | SOIL BORING - 20' DEEP |

| LINE TABLE: DFM | | | | |
|-----------------|--------|-------------|--------------------------------|--------------------------------|
| LINE # | LENGTH | DIRECTION | START POINT | END POINT |
| L38 | 333.67 | S71°49'30"W | N: 998719.1380, E: 633039.0604 | N: 998615.0590, E: 632722.0348 |
| L39 | 639.96 | S75°00'36"W | N: 99868.9155, E: 632567.0763 | N: 998403.3900, E: 631948.8959 |
| L40 | 173.89 | S83°09'30"W | N: 998359.5563, E: 631721.6085 | N: 998338.8416, E: 631548.9560 |
| L41 | 35.10 | N6°50'30"W | N: 998338.8416, E: 631548.9560 | N: 998373.6966, E: 631544.7742 |
| L42 | 23.09 | N15°41'14"W | N: 998373.6966, E: 631544.7742 | N: 998395.9226, E: 631538.5320 |
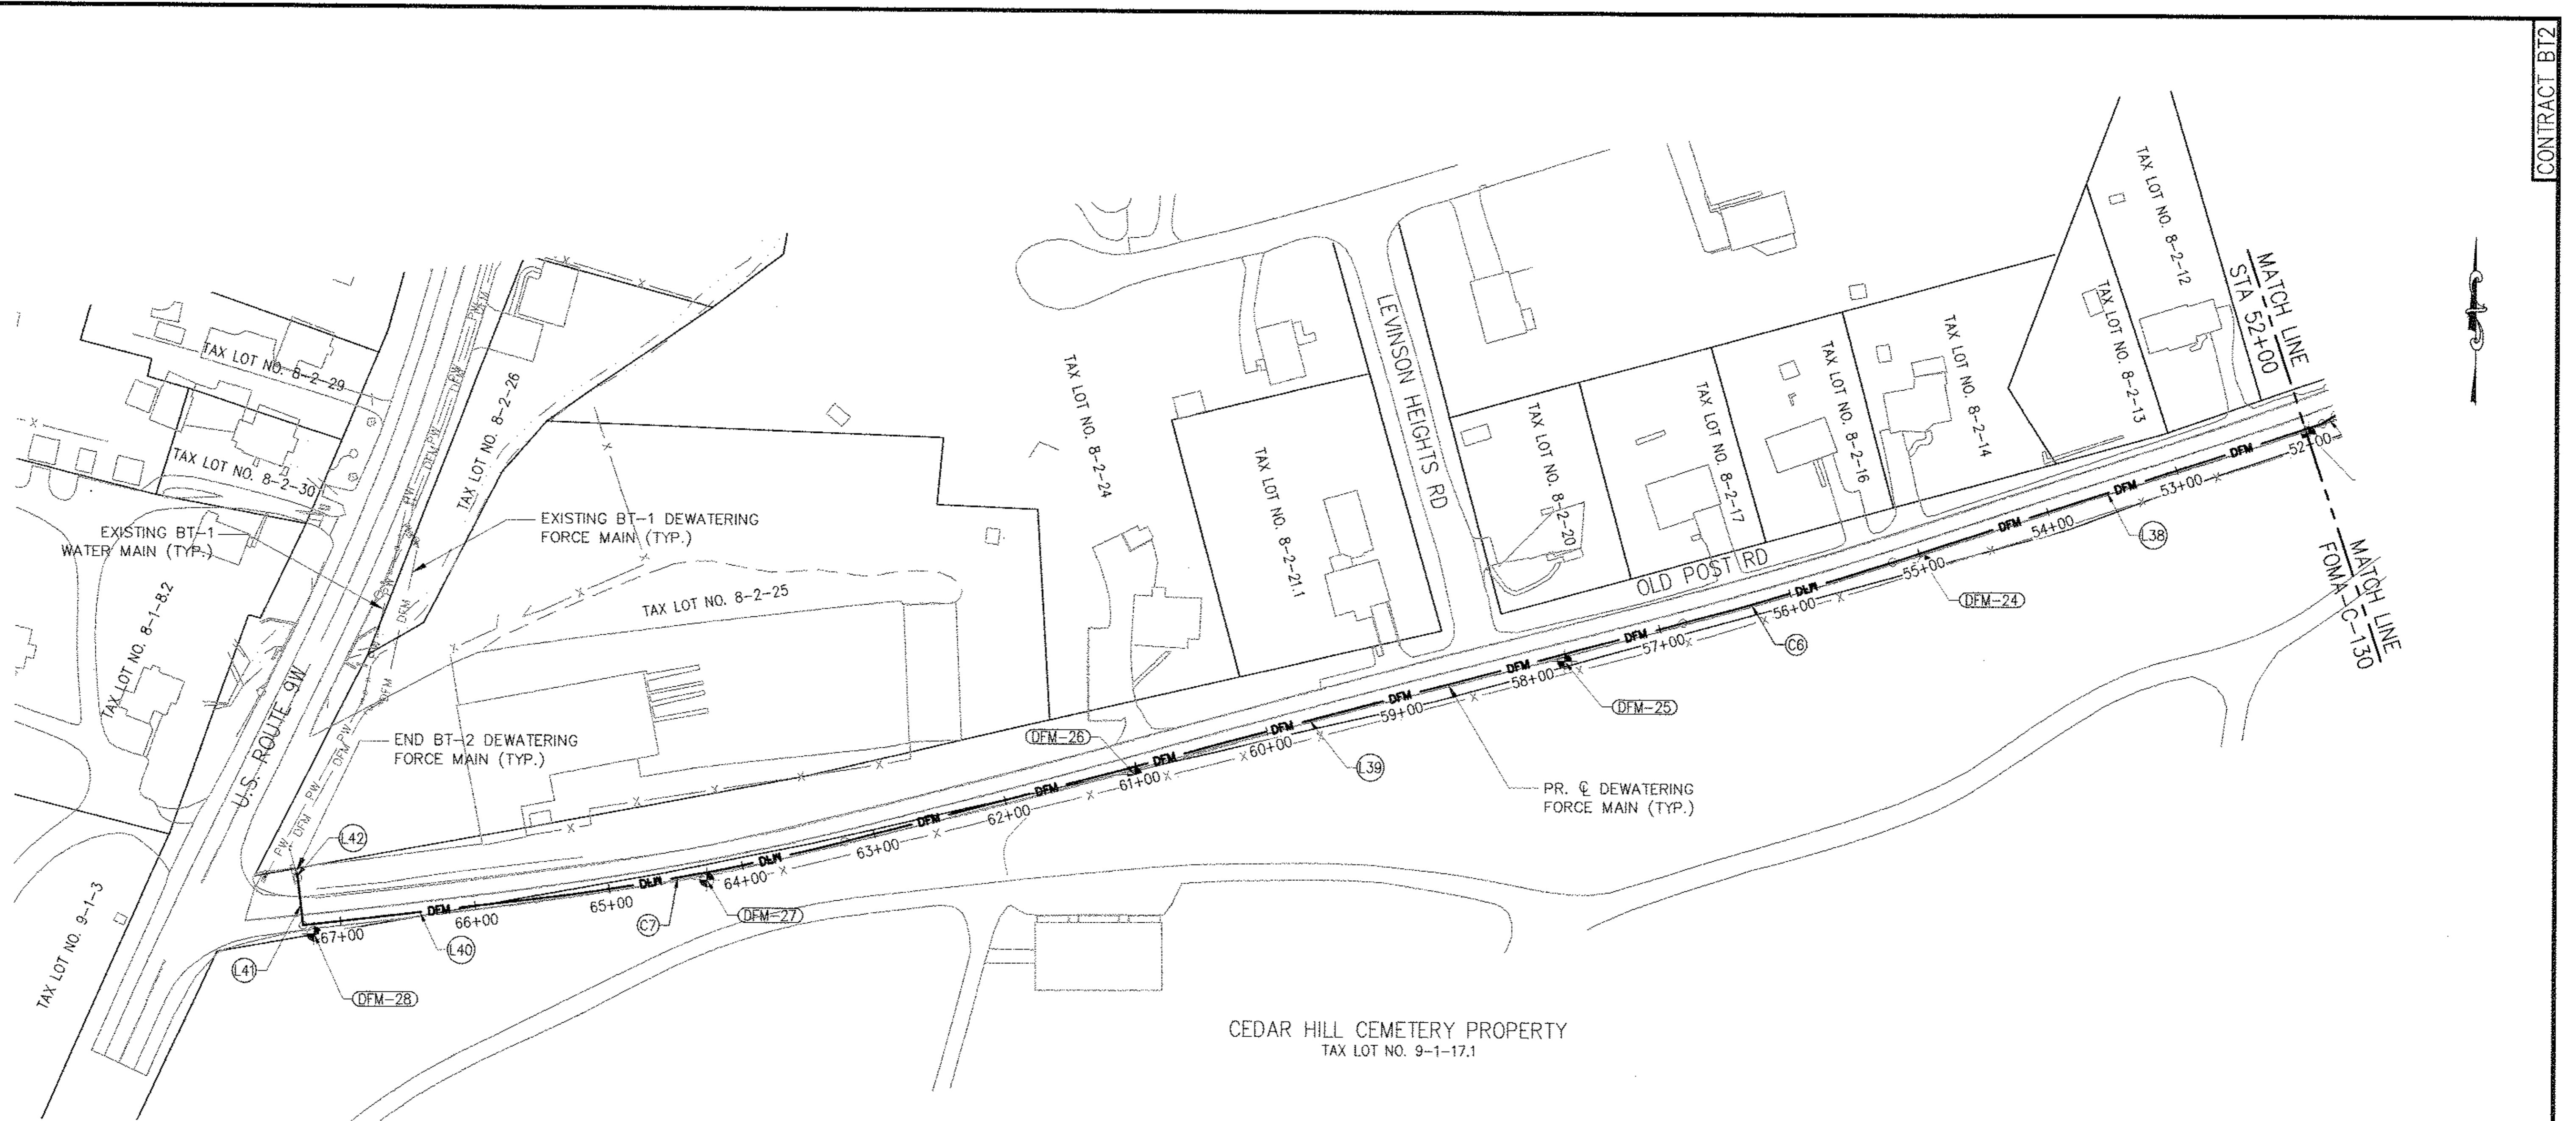
| CURVE TABLE: DFM | | | | | | |
|------------------|---------|--------|-----------------|--------------|--------------------------------|--------------------------------|
| CURVE # | RADIUS | LENGTH | CHORD DIRECTION | CHORD LENGTH | START POINT | END POINT |
| C5 | 787.00 | 264.81 | S59°41'49"W | 263.57 | N: 998858.2309, E: 633276.4173 | N: 998725.2419, E: 633048.8615 |
| C6 | 2909.00 | 161.70 | S73°25'03"W | 161.68 | N: 998615.0590, E: 632722.0348 | N: 998568.9155, E: 632567.0763 |

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0 60 120 FT.
1"=60'

BELL PROPERTY
SITE DESIGN

DATE SUBMITTED: 02/10/2014

GRAPHIC SCALES
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|--------------------|-----------------|--|---|
| DESIGNED BY: GM | DRAWN BY: GM | | PROJECT MANAGER TED DOWNEY |
| CHECKED BY: FP | | | CHIEF, TUNNEL DESIGN BURJOR KHARIVALA |
| DESIGN LEAD: GM | | | DIRECTOR, IN-HOUSE DESIGN PATRICK O'CONNOR |
| NO. DATE | DESCRIPTION | | APPR'D. |



NYC
Environmental
Protection

REVISIONS
REVISIONS
SECTION CHIEF:
FP


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RONDOUT WEST BRANCH BYPASS TUNNEL
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HORIZONTAL CONTROL & BORING PLAN
STA. 52+00 TO P.O.E.

DATE: 11/22/2013
SCALE: 1"=60'-0"
SHEET NO:
1 OF 453
DRAWING NO.
FOMA-C-128.00

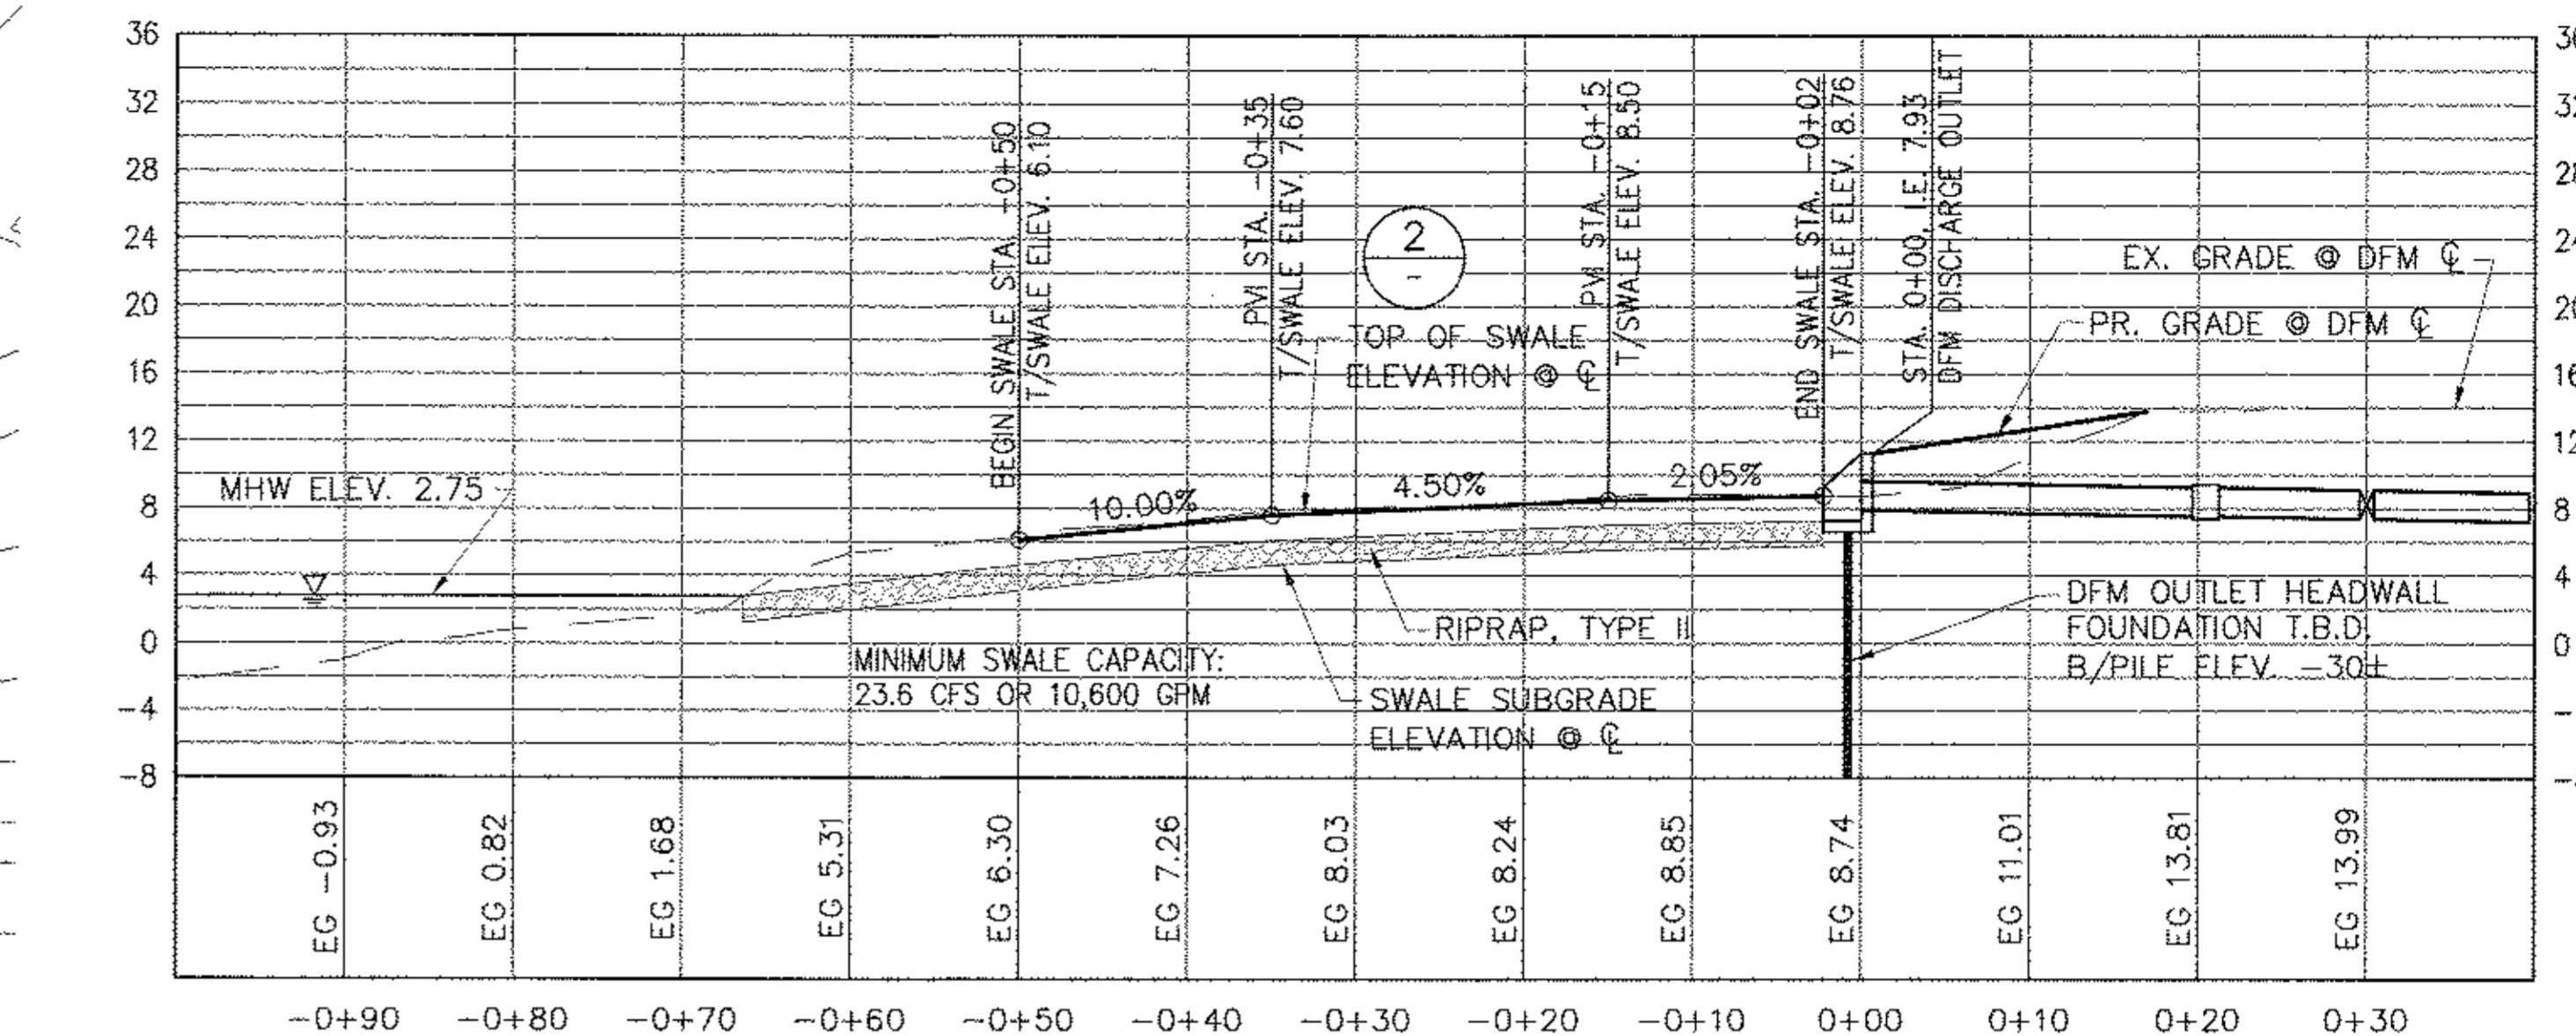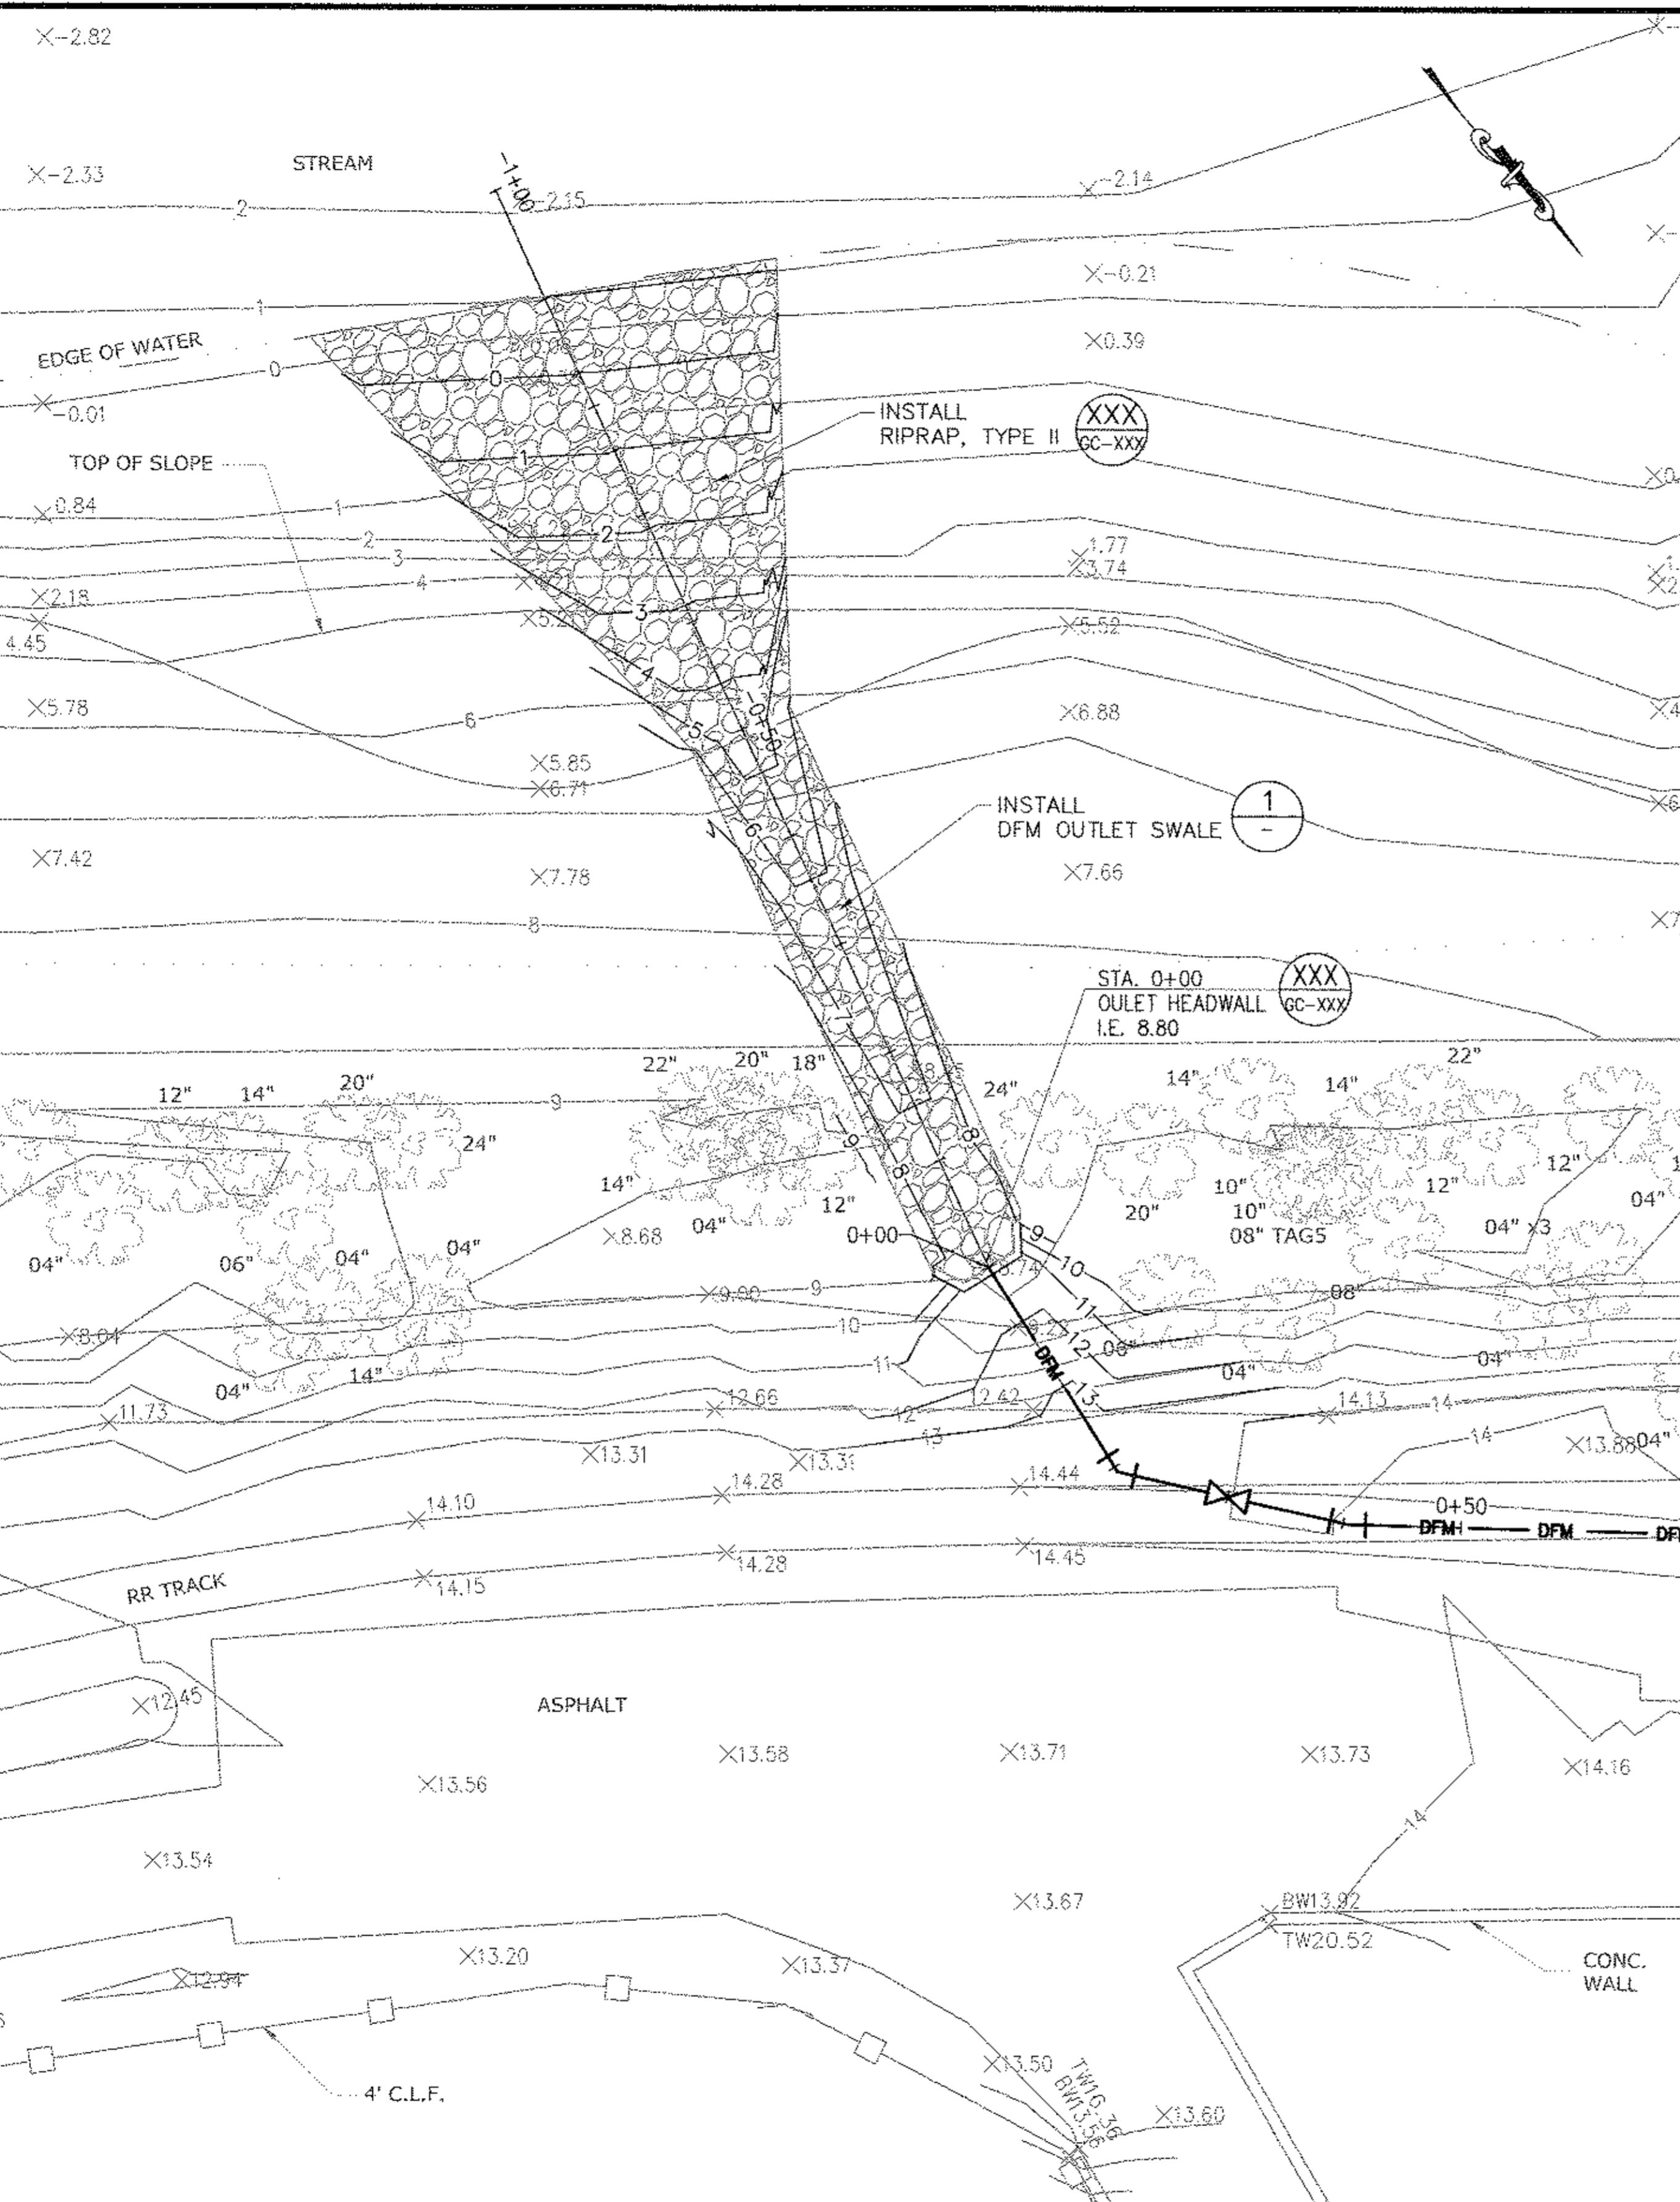

1 DFM OUTLET SWALE PROFILE
 - SCALE: 1' = 10'

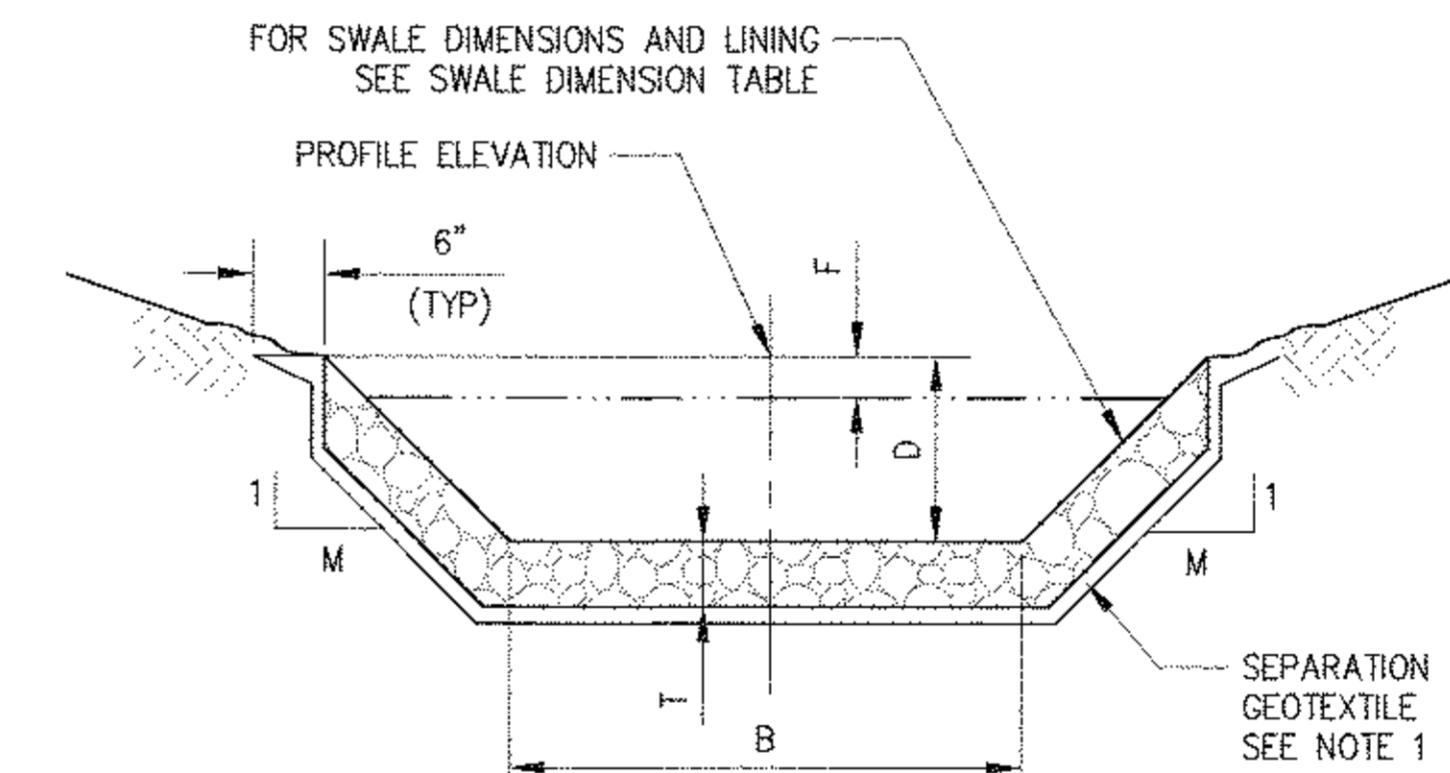

2 SWALE LINING
 - SCALE: NTS

| RIP-RAP SWALE DIMENSIONS TABLE | | | | | | | | | |
|--------------------------------|------------|----------|-------------------|-----------------|----------------|--------------------|-------------|-----------------------|----------------------------|
| SWALE NO. | STA. START | STA. END | SIDE SLOPES (M:1) | BOTTOM (B) (FT) | DEPTH (D) (FT) | FREEBOARD (F) (FT) | LENGTH (FT) | MAXIMUM SLOPE (FT/FT) | SWALE LINING |
| DFM OUTLET | -0+50 | -0+02 | 2:1 | 3 | 1.5 | 0.33 | 48 | 0.10 | TYPE II RIP-RAP SEE NOTE 1 |

0 10 20 FT.
 1"=10'

BELL PROPERTY
 SITE DESIGN
 DATE SUBMITTED: 02/10/2014

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 CONSTRUCTION AND WAWARSING REPAIRS,
 DELAWARE AQUEDUCT
 FORCE MAIN
 OUTLET GRADING
 & DRAINAGE PLAN

DATE: 11/22/2013
 SCALE: 1"=10'-0"
 SHEET NO:
 1 OF 453
 DRAWING NO.
 FOMA-C-134.00



PROJECT MANAGER
 TED DOWNEY
 CHIEF, TUNNEL DESIGN
 BURJAR KHARIYALA
 DIRECTOR, IN-HOUSE DESIGN
 PATRICK O'CONNOR

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| | | | | | | | | | | | | | |
|-----|------|-------------|---------|--------------------|-----------------|-------------------|---------------------------------------|------------------------------|--|--|---|--|---|
| NO. | DATE | DESCRIPTION | APPR'D | DESIGNED BY: GM | DRAWN BY: GM | CHECKED BY: FP | Water Future Environmental Protection | NYC Environmental Protection | PROJECT MANAGER TED DOWNEY CHIEF, TUNNEL DESIGN BURJAR KHARIYALA DIRECTOR, IN-HOUSE DESIGN PATRICK O'CONNOR | "WARNING—IT IS A VIOLATION, OF THE NEW YORK STATE EDUCATION LAW, SECTION 7209.2, FOR ANY PERSON, UNLESS (S)HE IS ACTING UNDER THE DIRECTION OF A LICENSED PROFESSIONAL ENGINEER, TO ALTER THIS DOCUMENT IN ANY WAY. IF ALTERED, THE ALTERING PERSON SHALL COMPLY WITH THE REQUIREMENTS OF NEW YORK EDUCATION LAW, SECTION 7209.2." | NEW YORK CITY ENVIRONMENTAL PROTECTION BUREAU OF ENGINEERING DESIGN & CONSTRUCTION 96-05 HORACE HARDING EXPRESSWAY 5th FLOOR CORONA, NEW YORK 11368 www.nyc.gov/dep | RONDOUT WEST BRANCH BYPASS TUNNEL CONSTRUCTION AND WAWARSING REPAIRS, DELAWARE AQUEDUCT FORCE MAIN OUTLET GRADING & DRAINAGE PLAN | DATE: 11/22/2013 SCALE: 1"=10'-0" SHEET NO: 1 OF 453 DRAWING NO. FOMA-C-134.00 |
| | | REVISIONS | APP'R'D | | | | | | | | | | |