## **GENERAL CONSTRUCTION NOTES:**

- THE CONSTRUCTOR IS EXPECTED TO FAMILIARIZE HIMSELF WITH THE EXISTING SITE BEFORE STARTING WORK. ALL DIMENSIONS SHALL BE VERIFIED IN THE FIELD. DO NOT SCALE DRAWINGS. USE DIMENSIONS GIVEN. ANY DISCREPANCIES OR CHANGES TO THESE PLANS SHALL BE BROUGHT TO THE ATTENTION OF THE ENGINEER AT ONCE. IF ANY CONSTRUCTION MATERIALS OR EQUIPMENT IN THESE NOTES ARE INTENDED TO BE CHANGED BY THE CONTRACTOR THE ENGINEER SHALL BE NOTIFIED PRIOR TO THE CHANGES FOR APPROVAL. ALL GUTTER AND FOOTING DRAIN OUTLETS SHALL BE DIRECTED/DISCHARGED FROM SEPTIC SYSTEM
- ALL WORK TO BE COMPLETED SHALL CONFORM TO CURRENT CODE AND FIRE PREVENTION CODE, AND ANY OTHER APPLICABLE LOCAL CODES. THE OWNER/CONTRACTOR IS RESPONSIBLE TO OBTAIN ANY REQUIRED CONSTRUCTION PERMITS BEFORE STARTING WORK AND SCHEDULING ANY APPLICABLE INSPECTIONS WITH THE BUILDING DEPARTMENT OR THIRD PARTY INSPECTION
- THE CONTRACTOR SHALL REMOVE ALL DEBRIS CREATED BY HIS SCOPE OF WORK.

#### **CONCRETE & FOUNDATIONS**

- THE CONTRACTOR IS RESPONSIBLE FOR CHECKING AND REPORTING ANY DISCREPANCIES.
- ALL EXCAVATION SHALL BE FREE OF WATER DURING THE FORMING. INSTALLATION AND CONSTRUCTION OF THE FOOTINGS AND FOUNDATION
- WITH THE EXCEPTION OF SLABS, ALL CONCRETE SHALL BE 3000 P.S.I.(28 DAY COMPRESSIVE STRENGTH) WITH 5% TO 7% AIR ENTRAINMENT
- CONCRETE DESIGN MIX AND REBAR SPLICES AND COVERAGE SHALL BE IN ACCORDANCE WITH CURRENT ACI CODES. ALL REINFORCING BARS SHALL BE GRADE 60.
- ALL CONCRETE WORK SHALL CONFORM TO THE LATEST REVISIONS OF THE ACI332 OR
- ALL SLABS ON GRADE SHALL BE 3500 P.S.I. WITH 5% TO 7% AIR ENTRAINMENT, 4"CONCRETE ON 4" SAND OR GRAVEL FILL WITH 6X6-10X10WWM REINFORCING. ALL INTERIOR SLABS SHALL BE PLACED ON A 6 MIL POLYETHYLENE VAPOR BARRIER, VAPOR BARRIER JOINTS SHALL BE LAPPED 6"
- PROVIDE 1/2" EXPANSION JOINT MATERIAL BETWEEN ALL CONCRETE SLABS AND ABUTTING CONCRETE WALLS OCCURRING IN EXTERIOR OR UNHEATED INTERIOR AREAS
- LL FOOTINGS SHALL BE 20"W (MIN.) X 10"H( MIN.),(OR PER PLANS)CONCRETE ON UNDISTURBED SOIL WITH TWO #4 BARS CONTINUOUS 3" FROM FOOTING BOTTO
- WATERPROOF WALLS OF EXCAVATED AREAS WITH THEROSEAL OR EQUAL, PLACE 4" DIA. PERFORATED PVC DRAINAGE PIPE AT PERIMETER OF EXCAVATED AREAS. COVER TOP OF JOINTS W/ 15 LB. FELT AND MINIMUM OF 6" COARSE ROCK OR GRAVEL. SLOPE PIPE 3/16" PER FT. MIN.
- CONCRETE PLACED IN COLD WEATHER SHALL BE IN CONFORMANCE WITH ACI CODES FOR DESIGN MIX AND/OR CURING OF COLD WEATHER
- CONCRETE CRAWL SPACES SHALL BE VENTED ONE SQ, FT, MINIMUM PER 150 SQ, FT, AREA. NTS SHALL BE WITHIN 3' OF CORNERS. IN ADDITION, A 24" X 18" MIN. ACCESS OPE
- BACKFILL SHALL NOT BE PLACED MORE THEN FOUR FEET ABOVE INTERIOR GRADE UNTIL HOUSE DECK IS ON AND BASEMENT SLAB IS POURED.
- . FOR ALL FOUNDATION AND CONCRETE WORK USE 3000 PSI OR GREATER ALL REBAR SHALL BE GRADE 60. USE ONLY PRESSURE TREATED SILL PLATES. USE 1/2" X 12" ANCHOR BOLTS AT 6'-0" O.C., 12" FROM CORNERS OR SPLICES. FOR ALL CONCRETE BLOCK MASONRY USE DURO-WA RY OTHER COURSE, TOP COURSE TO BE SOLID. MINIMUM SOIL BEARING CAPACITY SHALL BE
- FOOTING SHALL NOT TO BE PLACED ON FROZEN GROUND OR SOIL NOT MAINTAINING MINIMUM SOIL BEARING CAPACITY. IF SOIL DOES NOT MEET THIS CRITERIA, THIS SOIL SHALL BE REPLACED WITH APPROVED STRUCTURAL BACKFILL. CONTRACTOR SHALL IMMEDIATELY CONTACT ENGINEER IF NON-SUITABLE SOILS ARE ENCOUNTERED.

## FRAMING AND CARPENTRY

(UNLESS OTHERWISE NOTED ON PLAN).

- ALL LUMBER SHALL BE CONSTRUCTION GRADE SPF (Fb = 1,200 PSI) OR EQUAL
- DOUBLE UP ALL STUDS AT WINDOWS, DOORS, AND HEADERS, DOUBLE UP ALL FLOOR JOISTS, UNDER PARTITIONS PARALLEL TO THEM. ALL FLOOR JOSTS SHALL BE BRACED OR BLOCKED AT MID-SPAN. ALL PLYWOOD SUB-FLOORING SHALL BE SCREWED DOWN. PROVIDE ALL FIRE STOPPING AS REQUIRED BY CODE. ANY LUMBER USED FOR DECKS OR EXTERIOR USE SHALL BE PRESSURE TREATED.
- USE JOIST HANGERS FOR ANY LUMBER FRAMED FLUSH WITH A BEAM. USE ONLY GALVANIZED
   ITEMS FOR EXTERIOR USE. PROVIDE CROSS BRACING OR SOLID BLOCKING BETWEEN ALL JOISTS. PROVIDE DOUBLE JOISTS UNDER COLUMNS THAT FALL ABOVE IT. ALL OTHER NAILS, FASTENERS, HANGERS, ETC. SHALL MEET GENERALLY ACCEPTED INDUSTRY STANDARDS.
- FOR EXTERIOR WORK USE ALUMINUM STEP FLASHING AT THE INTERSECTION OF ALL ROOFS AND WALLS. OVERLAP ROOF SHINGLES AT ALL VALLEYS AND HIPS IN ACCORDANCE WITH MANUFACTURERS RECOMMENDATIONS. FOR ALL VALLEYS AND EAVES, LINE WITH WEATHER-GUARD (OR FOUTVALENT) NATI ARIJETICE SHIELD REFORE INSTALLING SHINGLES
- ALL ITEMS NOT SPECIFICALLY NOTED IN THESE PLANS INCLUDING FLOOR, PAINT, FINISH CARPENTRY, PLUMBING FIXTURES, ELECTRICAL LIGHT FIXTURES, ETC. SHALL BE DISCUSSED AND TED WITH THE OWNERS BEFORE BEGINNING WORK
- . ALL INTERIOR WALLS SHALL BE 2 X 4 STUDS @ 16" O.C. UNLESS OTHERWISE NOTED. ALL INTERIOR WALLS SHALL BE FINISHED WITH 1/2" GYPSUM BOARD, SPACKLED, TAPED AND FINISHED, UNLESS OTHERWISE NOTED. ALL EXTERIOR WALLS SHALL 2 X 6 STUDS AT 16" O.C. (REFER TO TYPICAL WALL DETAILS FOR SPECIFICATIONS).
- . FOR INTERIOR SIDE OF FRAME WALLS, FLOORS, AND CEILINGS, VAPOR RETARDERS SHALL BE
- . UNLESS OTHERWISE NOTED, PROVIDE: DOUBLE HEADER JOISTS AND TRIMMERS AT ALL FLOOR OPENINGS. DOUBLE JOISTS UNDER ALL PARALLEL PARTITIONS.
- . 1 ROW OF 1" X 3" CROSS BRIDGING PER JOISTS SPAN. FLOOR CONSTRUCTION SHALL BE 3/4" TONGUE AND GROOVE PLYWOOD WITH EXTERIOR GLUE.

- . USE WATER RESISTANT GYPSUM BOARD FOR WALLS AND CEILINGS AND 1/2" PLYWOOD
- ALL LVL GIRDERS EXCEEDING (3) SHALL BE THRU BOLTED WITH §" DIAMETER THRU BOLTS AND OVERSIZED WASHERS, STAGGERED AT 16" O.C.
- · ALL EXTERIOR WINDOW AND DOOR HEADERS SHALL BE (3) 2 X 10 UNLESS NOTED OTHERWISE
- ALL INTERIOR WINDOW AND DOOR HEADERS SHALL BE (2) 2 X 10 WITH !" PLYWOOD UNLESS
- . 2 X 6 COLLAR TIES AT 16" O.C. SHALL BE PROVIDED IN ALL AREAS WHERE STRUCTURAL RIDGE IS

#### **ELECTRICAL SPECIFICATIONS**

- ALL ELECTRIC SHALL COMPLY TO CHAPTERS 34-43 OF THE 2020 NYS RESIDENTIAL CODE
- · ALL ELECTRICAL WORK SHALL CONFORM TO THE LATEST APPROVED CODE. ALL ELECTRICAL WORK SHALL BE INSPECTED AT THE ROUGH AND FINAL STAGES OF THE CONSTRUCTION
- . SMOKE DETECTORS SHALL BE HARD WIRED, INTER-CONNECTED AND HAVE A BATTERY BACKUP. SMOKE DETECTORS SHALL BE INSTALLED IN EACH SLEEPING ROOM, WITHIN 15 FEET OUTSIDE OF EACH SEPARATE SLEEPING AREA, AND ON EACH ADDITIONAL STORY OF A DWELLING, INCLUDING
- CARBON MONOXIDE DETECTORS SHALL BE HARD WIRED AND HAVE A BATTERY BACKUP, CARBON MONOXIDE DETECTORS SHALL BE INSTALLED WITHIN 15 FEET OF ALL BEDROOMS OUTSIDE OF EACH SEPARATE SLEEPING AREA AND ON EACH ADDITIONAL STORY OF A DWELLING, INCLUDING BASEMENTS AND CELLARS.
- AFCI PROTECTION SHALL BE PROVIDED FOR ALL OUTLETS IN BEDROOMS, HALLWAYS, LIVING
- . GFCI PROTECTION SHALL BE PROVIDED FOR ALL OUTLETS IN BATHROOMS, KITCHEN, GARAGE, OUTSIDE, LAUNDRY ROOM, AND UTILITY ROOM
- CIRCUIT INTERRUPTER PROTECTION INSTALLED IN EACH ROOM PER CURRENT CODE
- RECESSED LIGHTING FIXTURES IN THE BUILDING ENVELOPE SHALL BE SEALED TO PREVENT AIR
- · A PERMANENT CERTIFICATE SHALL BE POSTED ON, OR IN THE ELECTRICAL DISTRIBUTION PANEL BY A STATE LICENSED ELECTRICAL INSPECTOR AND SHALL CONFORM TO THE CURRENT CODE

#### MECHANICAL & VENTILATION SPECIFICATIONS

- . UTILITY ROOM SHALL BE VENTED TO THE EXTERIOR TO PROVIDE MINIMUM FRESH AIR REQUIRED FOR COMBUSTION BY HEATING UNIT MANUFACTURER.
- A WHOLE HOUSE MECHANICAL VENTILATION SYSTEM SHALL BE INSTALLED TO PROVIDE OUTDOOR. AIR AT A CONTINUOUS RATE OF NOT LESS THAN 75 CFM.
- . THE WHOLE HOUSE MECHANICAL VENTILATION SYSTEM IS PERMITTED TO OPERATE INTERMITTENTLY WHERE THE SYSTEM HAS CONTROLS THAT ENABLE OPERATION FOR NOT LESS THAN 25-PERCENT OF EACH 4-HOUR SEGMENT AND THE VENTILATION RATE NOTED ABOVE IS MULTIPLIED BY THE FACTOR DETERMINED IN ACCORDANCE WITH TABLE 1507.3.3(1).
- THE WHOLE HOUSE MECHANICAL VENTILATION SYSTEM SHALL CONSIST OF ONE OR MORE SUPPLY OR EXHAUST FANS, OR A COMBINATION OF SUCH, AND ASSOCIATED DUCTS AND CONTROLS. THE MANUAL OVERRIDE SHALL BE LOCATED IN THE UTILITY ROOM OF THE DWELLING.
- THE FAI DUCT FROM THE WHOLE HOUSE MECHANICAL VENTILATION SYSTEM SHALL BE INSULATED WITH R-6 DUCTWRAP IF WITHIN BUILDING ENVELOPE, INSULATE WITH R-8 IF OUTSIDE OF THE
- . A MINIMUM DISTANCE OF 10'-0" SHALL BE MAINTAINED FROM FAI AND ALL OTHER EXHAUST OUTLETS AND FLUES, EXHAUST TERMINATIONS MAY BE RUN THRU ATTIC TO ROOF JACKS IN LIFU OF WALL CAPS, FIELD COORDINATE
- OUTDOOR AIR DUCTS CONNECTED TO THE RETURN SIDE OF AN AIR HANDLER SHALL BE CONSIDERED AS PROVIDING SUPPLY VENTILATION IF APPLICABLE.
- BATHROOM VENTS SHALL BE 20 CFM CONTINUOUS OR 50 CFM INTERMITTENT AND KITCHEN VENTS SHALL BE 25 CFM CONTINUOUS OR 100 CFM INTERMITTENT, BATH FANS SHALL BE 0F ALUMINUM CONSTRUCTION.
- GRAVITY OR AUTOMATIC DAMPERS FOR ALL OUTDOOR AIR INTAKES AND EXHAUSTS SHALL CLOSE WHEN VENTILATION SYSTEM IS NOT OPERATING
- CLOTHES DRYERS SHALL BE EXHAUSTED IN ACCORDANCE WITH MANUFACTURER'S INSTRUCTIONS, AND EXHAUSTS SYSTEMS SHALL BE INDEPENDENT OF ALL OTHER SYSTEMS. THE EXHAUST SYSTEMS SHALL CONVEY THE MOISTURE AND ANY PRODUCTS OF COMBUSTION TO THE OUTSIDE OF THE BUILDING.

### PLUMBING SPECIFICATIONS

- . CONSISTENCY SHALL SHOW BETWEEN FIXTURE OUTLET SIZE AND DRAIN SIZE, 3" MINIMUM, AT ALL TIMES. PLUMBING SHALL TIE INTO MUNICIPAL SEWER OR SEPTI-
- . TRAPS ARE TYPICAL FOR ALL TOILETS PER CURRENT CODE. ALL WASTE LINES SHALL HAVE A MINIMUM 1 PER FOOT SLOPE.
- VENT STACK AND WASTER PIPE SHALL BE PVC. SUPPLY LINES SHALL BE PEX.
- . AT LEAST ONE VENT STACK IS REQUIRED IN EACH RESIDENCE AND SHALL EXTEND NO MORE AN EAST ONE VEHICLIANCE THE VENT SHALL RUN UNDIMINISHED IN SIZE, 3", AND AS DIRECTLY AS POSSIBLE FROM THE BUILDING DRAIN THROUGH TO THE OPEN AIR ABOVE THE ROOF.
- WATER TESTING IS REQUIRED ON ALL WASTE, VENT, AND DRAIN PIPES
- WATER HAMMER ARRESTORS ARE REQUIRED IN ACCORDANCE WITH CURRENT CODE
- ROUGH IN FOR PLUMBING FIXTURES LOCATIONS SHALL REMAIN CONSISTENT WITH PLANS, NO ADDITIONAL PLUMBING SHALL BE ROUGHED IN WITHOUT THE AUTHORIZATION OF THE DESIGN

#### **ENERGY CODE**

INSULATED WITH R-6 OR GREATER.

- HIGH-EFFICIENCY LAMPS SHALL SHALL ACCOUNT FOR 50% OF PERMANENTLY INSTALLED
- . R-8 INSULATION IS REQUIRED FOR ALL SUPPLY DUCTS IN ATTICS, ALL OTHER DUCTS SHALL BE
- THE BUILDING OR DWELLING UNIT SHALL BE TESTED AND VERIFIED AS HAVING AN AIR LEAKAGE RATE NOT EXCEEDING THREE AIR CHANGES PER HOUR
- . WINDOWS, SKYLIGHTS, AND SLIDING GLASS DOORS SHALL HAVE AN AIR INFILITRATION RATE OF NOT GREATER THAN 0.3 CFM PER SQUARE FOOT AND SWINGING DOORS SHALL HAVE AN AIR INFILTRATION RATE OF NOT GREATER THAN 0.5 CFM PER SQUARE FOOT.
- EACH HEATING AND COOLING SYSTEM SHALL HAVE AT LEAST ONE PROGRAMMABLE THERMOSTAT.
- HOT WATER BOILERS THAT SUPPLY HEAD TO THE BUILDING THROUGH ONE- OR TWO-PIPE HEATING SYSTEMS SHALL HAVE AN OUTDOOR SETBACK CONTROL THAT DECREASES THE BOILER WATER TEMPERATURE BASED ON THE OUTDOOR TEMPERATURE.
- AIR HANDLERS SHALL HAVE A MANUFACTURER'S DESIGNATION FOR AN AIR LEAKAGE OF NOT. TER THAN 2 PERCENT OF THE DESIGN AIRFLOW RATE WHEN TESTED IN ACCORDANCE WITH ASHRAE 193.
- . MECHANICAL SYSTEM PIPING CAPABLE OF CARRYING FLUIDS GREATER THAN 105 DEGREES FAHRENHEIT (41 DEGREES CELSIUS) OR LESS THAN 55 DEGREES FAHREN
  CELSIUS) SHALL BE INSULATED TO AN R-VALUE OF NOT LESS THAN R-3.
- PIPING INSULATION EXPOSED TO WEATHER SHALL BE PROTECTED FROM DAMAGE. INCLUDING THAT CAUSED BY SUNLIGHT, MOISTURE, EQUIPMENT MAINTENANCE AND WIND. THE PROTECTION SHALL PROVIDE SHIELDING FROM SOLAR RADIATION THAT CAN CAUSE DEGRADATION OF THE MATERIAL. ADHESIVE TAPE SHALL BE PROHIBITED.
- HEATED WATER CIRCULATION SYSTEMS SHALL BE PROVIDED WITH A CIRCULATION PLIMP. THE SYSTEM RETURN PIPE SHALL BE A DEDICATED RETURN PIPE OR A COLD WATER SUPPLY PIPE.
  GRAVITY AND TERMOSYPHON CIRCULATION SYSTEMS SHALL BE PROHIBITED, CONTROLS FOR CIRCULATING HOT WATER SYSTEM PUMPS SHALL START THE PUMP BASED ON THE CIRCULATION OF INTERN STSIEN POWER SHALL SHE HE COLUPANCY, THE CONTROLS SHALL AUTOMATICALLY TURN OFF THE PUMP WHEN THE WATER IN THE CIRCULATION LOOP IS AT THE DESIRED TEMPERATURE AND WHEN THERE IS NO DEMAND FOR HOT WATER.
- ELECTRIC HEAT RACE SYSTEMS SHALL COMPLY WITH IEEE 515.1 OF BUILF 515. CONTROLS FOR SUCH SYSTEMS SHALL AUTOMATICALLY ADJUST THE ENERGY INPUT TO THE HEAT TRACING TO MAINTAIN THE DESIRED WATER TEMPERATURE IN THE PIPING IN ACCORDANCE WITH THE TIMES HEATED WATER IS USED IN OCCUPANCY.
- DWELLING SHALL COMPLY WITH TIGHTNESS AND INSULATION REQUIREMENTS ILLUSTRATED IN THE 2020 ENERGY CONSERVATION CONSTRUCTION CODE OF NEW YORK STATE. ATITIC ACCESS SHALL BE INSULATED AND WEATHERSTREPED TO LEVEL EQUIVALENT TO INSULATION LEVEL TO SURROUNDING SURFACES, BAFFLES SHALL BE PROVIDED TO PREVENT LOOSE FILL INSULATION

- . THE ATTIC OPENING (PASSAGEWAY) MUST HAVE A CLEAR UNOBSTRUCTED VIEW LARGE ENOUGH D REMOVE AND REPLACE ALL APPLIANCES LOCATED IN THE ATTIC
- · SOLID PLYWOOD FLOORING SURFACE SHALL BE PLACED ON THE ATTIC FLOOR JOISTS IN ACCORDANCE WITH M1305.1.3 OF THE 2020 NEW YORK STATE RESIDENTIAL CODE.
- A MINIMUM OF 2' BEYOND THE EDGE OF ALL APPLIANCES FOR MAINTENANCE PURPOSES
- FOR APPLIANCES IN THE ATTICS, AN OPEN AND UNOBSTRUCTED PASSAGE WAY LARGE ENOUGH TO ALLOW FOR THE REMOVAL OF THE APPLIANCE SHALL BE PROVIDED IN ATTIC. APPLIANCE LOCATION SHOULD BE NO FURTHER THAN 20°-0" FROM THE ATTIC ACCESS POINT AND SHALL HAVE A SOLID FLOOR FROM ATTIC ACCESS POINT TO APPLIANCE LOCATION AND THE AREA AROUND THE APPLIANCE TO ACCOMMODATE FOR SERVICE, FINAL LOCATION OF APPLIANCES
- APPLIANCES SHALL BE LOCATED TO ALLOW FOR ACCESS FOR INSPECTION, SERVICES, REPAIR AND REPLACEMENT WITHOUT REMOVING PERMANENT CONSTRUCTION, SERVICES, OR ANY OTHER PEPLANCES, OR ANY OTHER PIPING OR DUCTS NOT CONNECTED TO THE APPLIANCE BEING INSPECTED, SERVICED, REPAIRED OR REPLACED. A LEVEL WORKING SPACE NOT LESS THAN 30 INCHES DEEP AND 30 INCHES WIDE (762MM BY 762MM) SHALL BE PROVIDED IN FRONT OF THE CONTROL SIDE TO SERVICE AN APPLIANCE. A LUMINAIRE CONTROLLED BY A SWITCH LOCATED AT THE REQUIRED PASSAGEWAY OPENING AND A RECEPTACLE OUTLET SHALL BE INSTALLED AT OR NEAR THE APPLIANCE LOCATION IN ACCORDANCE WITH CHAPTER 39. EXPOSED LAMPS SHALL BE PROTECTED FROM DAMAGE BY OCATION OR LAMP GUARDS.
- ATTIC ACCESS SHOWN SHALL BE INSULATED AND WEATHERSTRIPPED TO PROVIDE A LEVEL OF INSULATION EQUIVALENT TO THE INSULATION ON SURROUNDING SURFACES. WOOD FRAMED OR EQUIVALENT BAFFLE, OR RETAINER SHALL BE PROVIDED, AS REQUIRED.
- THE ATTIC FLOOR INSULATION SHALL NOT BE COMPRESSED. SLEEPERS SHALL BE PROVIDED.

## **DRAWING SHEETS**

- A-1 GENERAL CONSTRUCTION NOTES & RESCHECK A-2 ELEVATIONS
- A-3 FOUNDATION PLAN & GARAGE PLAN
- A-4 UNFINISHED STORAGE PLAN & ROOF PLAN
- A-5 SECTION, CONSTRUCTION DETAILS, TYPICAL WALL DETAIL & NOTCHING/BORING DETAILS
- A-6 MECHANICAL SPECIFICATIONS

## CLIMATE AND GEOGRAPHIC DESIGN CRITERIA

ITEM

FLOOR

ATTIC

DECK

LOADS P.S.F.

DEAD

10

10

10

LIVE

40

20

45

GROUND SNOW LOAD	WIND SPEED	SEISMIC DESIGN CATEGORY	SUBJECT TO DAMAGE FROM				WINTER	ICE SHIELD	FLOOD
			WEATHERING	FROST DEPTH	TERMITE	DECAY	DESIGN TEMP.	UNDERLAYMENT	HAZARD
50 PSF	115 MPH	С	SEVERE	42 IN.	MODERATE TO HEAVY	SLIGHT TO MODERATE	6	REQUIRED	PER SITI

#### Generated by REScheck-Web Software Compliance Certificate Project Collectable and Classic Car Storage for Dilemme: 24-009-NDS Energy Code lewburgh, New York Single-family Project Type: 4% 5 (5895 HDD) Climate Zone Permit Date: Permit Number 12 Deer Run Road Newburgh, New York 12550 pliance: Passes using UA trade-off ce: 17,8% Better Than Code Maximum UA: 382 Your UA: 314 Slab-on-grade tradeoffs are no longer considered in the UA or performance compliance path in REScheck. Each slab-on-grade assembly in the specified climate zone must meet the minimum energy code insulation R-value and depth requirements. Envelope Assemblies Ceiling: Flat Ceiling or Scissor Truss 38.0 0.0 0.030 0.026 Wall: Wood Frame, 16" o.c. 2,160 21.0 5.0 0.043 Door: Solid Door (under 50% glazing) 0.210 0.300 Door 1: Solid Door (under 50% glazing) 288 0.210 0.300 86 Window: Wood Frame 82 0.300 0.300 25 25 Window 1: Wood Frame 0,300 0,300 Wall 1: Wood Frame, 16" o.c. 1,240 21.0 5.0 74 Wall 2: Solid Concrete or Masonry 10.0 0.0 0.105 0.082

THESE PLANS HAVE BEEN PREPARED OR MODIFIED AND REVIEWED UNDER MY DIRECT SUPERVISIONS AND TO THE BEST OF MY KNOWLEDGE, BELIEF, AND PROFESSIONAL JUDGEMENT, SUCH PLANS FOR SPECIFICATIONS ARE IN COMPLIANCE WITH THE 2020 RESIDENTIAL CONSTRUCTION CODE OF NEW YORK STATE AND THE 2020 ENERGY CONSERVATION CONSTRUCTION CODE OF NEW YORK STATE.

> **LIVABLE AREA SQUARE FOOTAGE**

GARAGE -2016 SQ. FT. STORAGE -1329 SQ. FT.

TOTAL -

ITEM	LOADS P.S.F.			
	GROUND SNOW LOAD	DEAD		
ROOF	55	10		

3345 SQ. FT.

GENERAL CONSTRUCTION NOTES & RESCHECK


SLE AND STORAGE DILEMME 22.11 ROAD H, NEW YORK CAR S FOR 1 14-3-2: COLLEC COLLEC CLASSIC GARAGE F S-B-L: 12 DEER TOWN OF NEW!

Ш

0 VATHAN CELLA, P
51 Hunt Road
Wallkill, New York, 12589
(845) 741-0363
V.Y.S. P.E. License #: 085065 ONATI

DATE: JOB NUMBER: SHEET NUMBER:



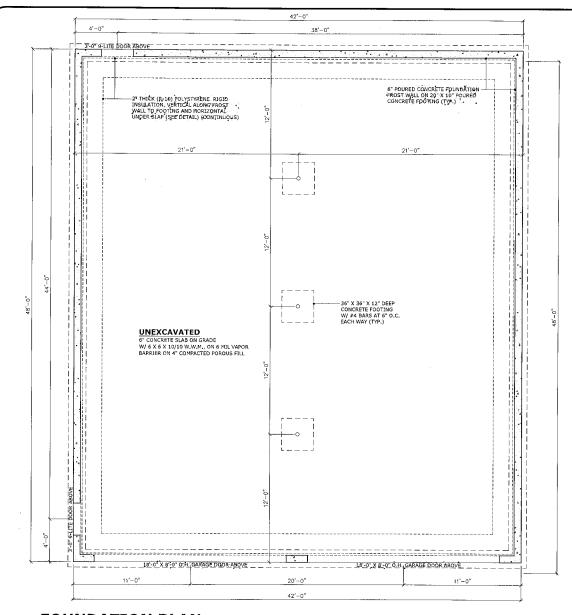


# **FOUNDATION PLAN**

Scale: 1/4" = 1'-0"


NOTES:


1.) THE FOUNDATION WALLS CAN BE POURED 48 HOURS AFTER THE FROST FOOTINGS, THIS PLAN SERVES AS PROFESSIONAL CERTIFICATION OF SUCH.

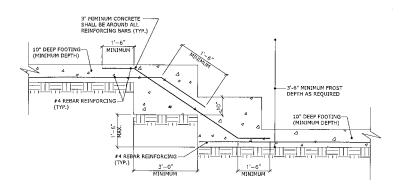

# STEP FOOTING DETAIL

Scale: 1" = 1'-0"

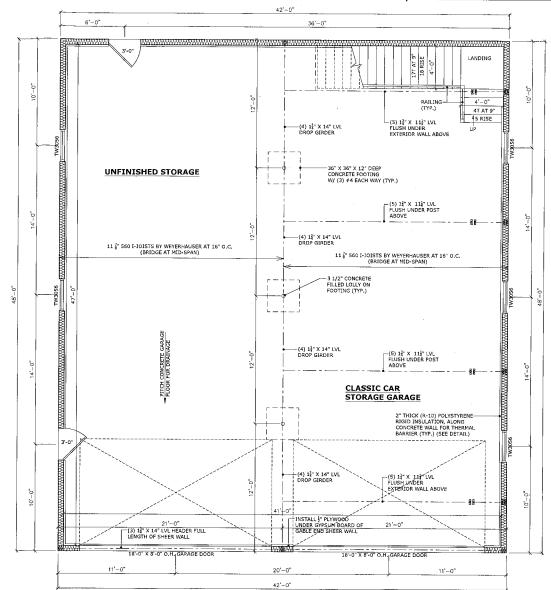

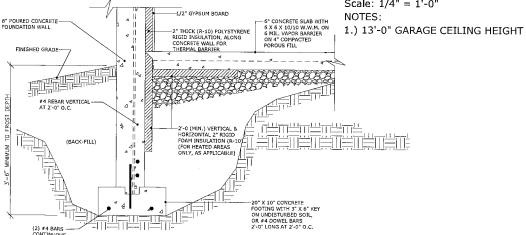

# FROST FOOTING DETAIL

Scale: 1" = 1'-0" NOTE: REFER TO TYPICAL WALL DETAIL FOR ALL FULL FOUNDATION WALL DETAILS. **GARAGE PLAN** 

Scale: 1/4" = 1'-0"

LEGEND





ಶ SHEET TITLE:
FOUNDATION PLAN
GARAGE PLAN


COLLECTABLE AND
CLASSIC CAR STORAGE
GARAGE FOR DILEMME
5-B-L: 14-3-22.11
12 DEER RUN ROAD
TOWN OF NEWBURGH, NEW YORK


я П JONATHAN CELLA, P.E 51 Hunt Road Wallkill, New York, 12589 (845) 741-0363 N.Y.S. P.E. License #: 085069

DATE: JOB NUMBER: SHEET NUMBER:

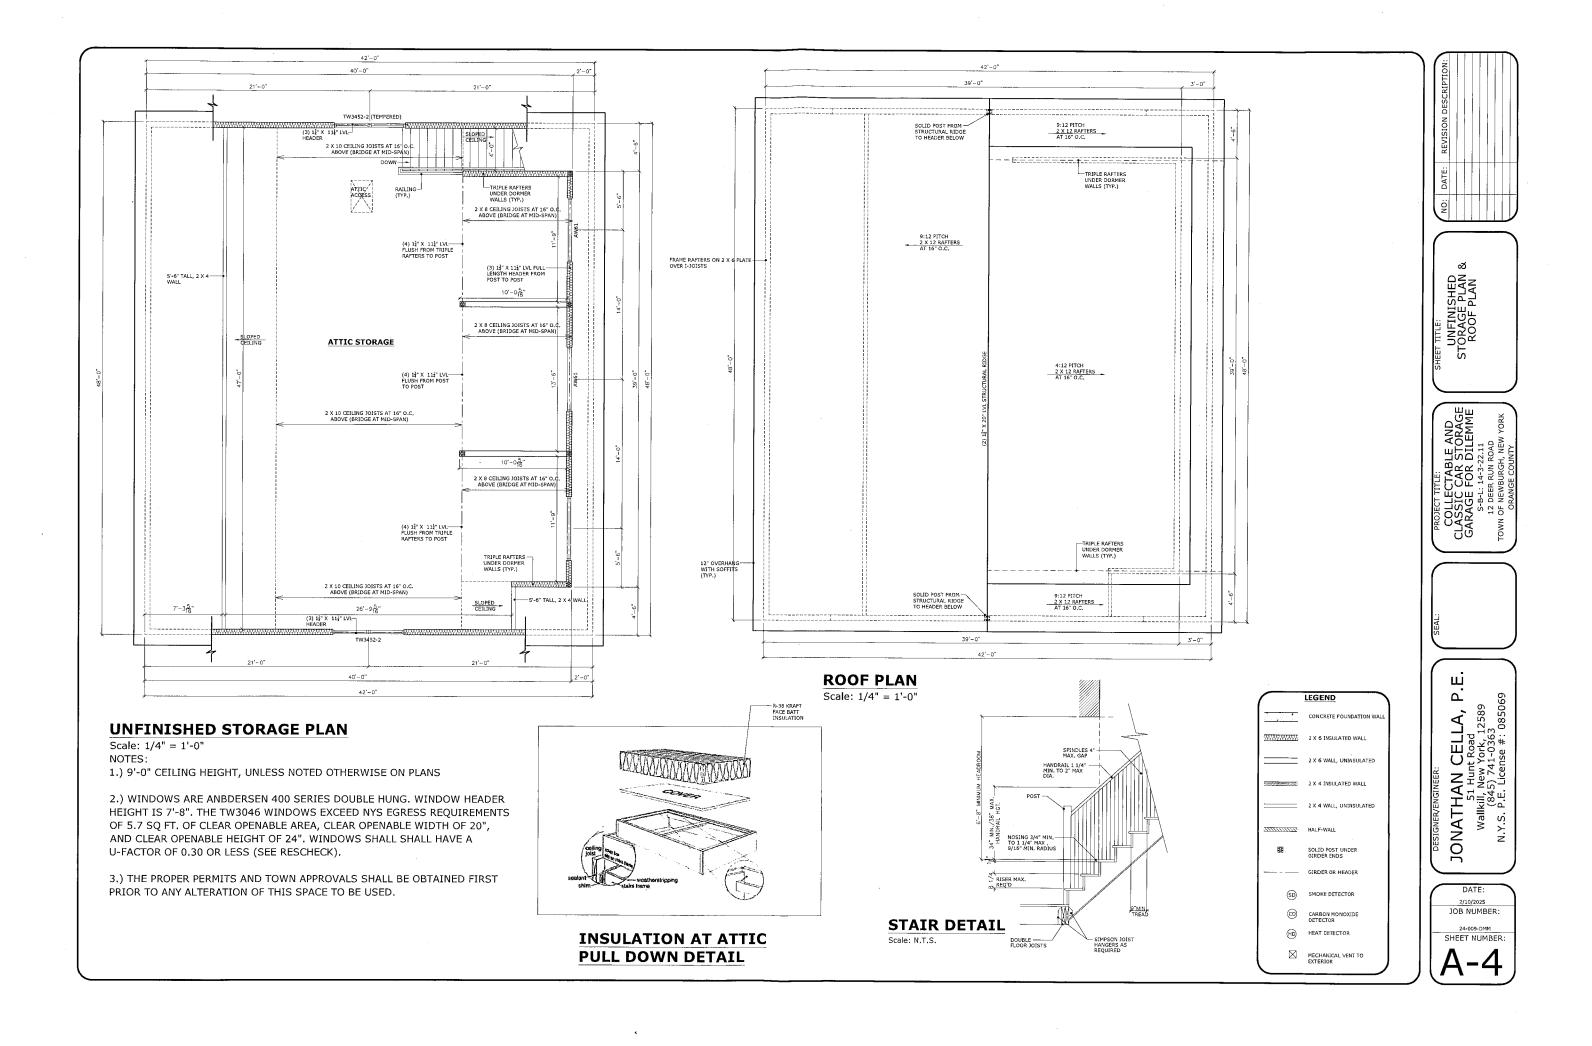


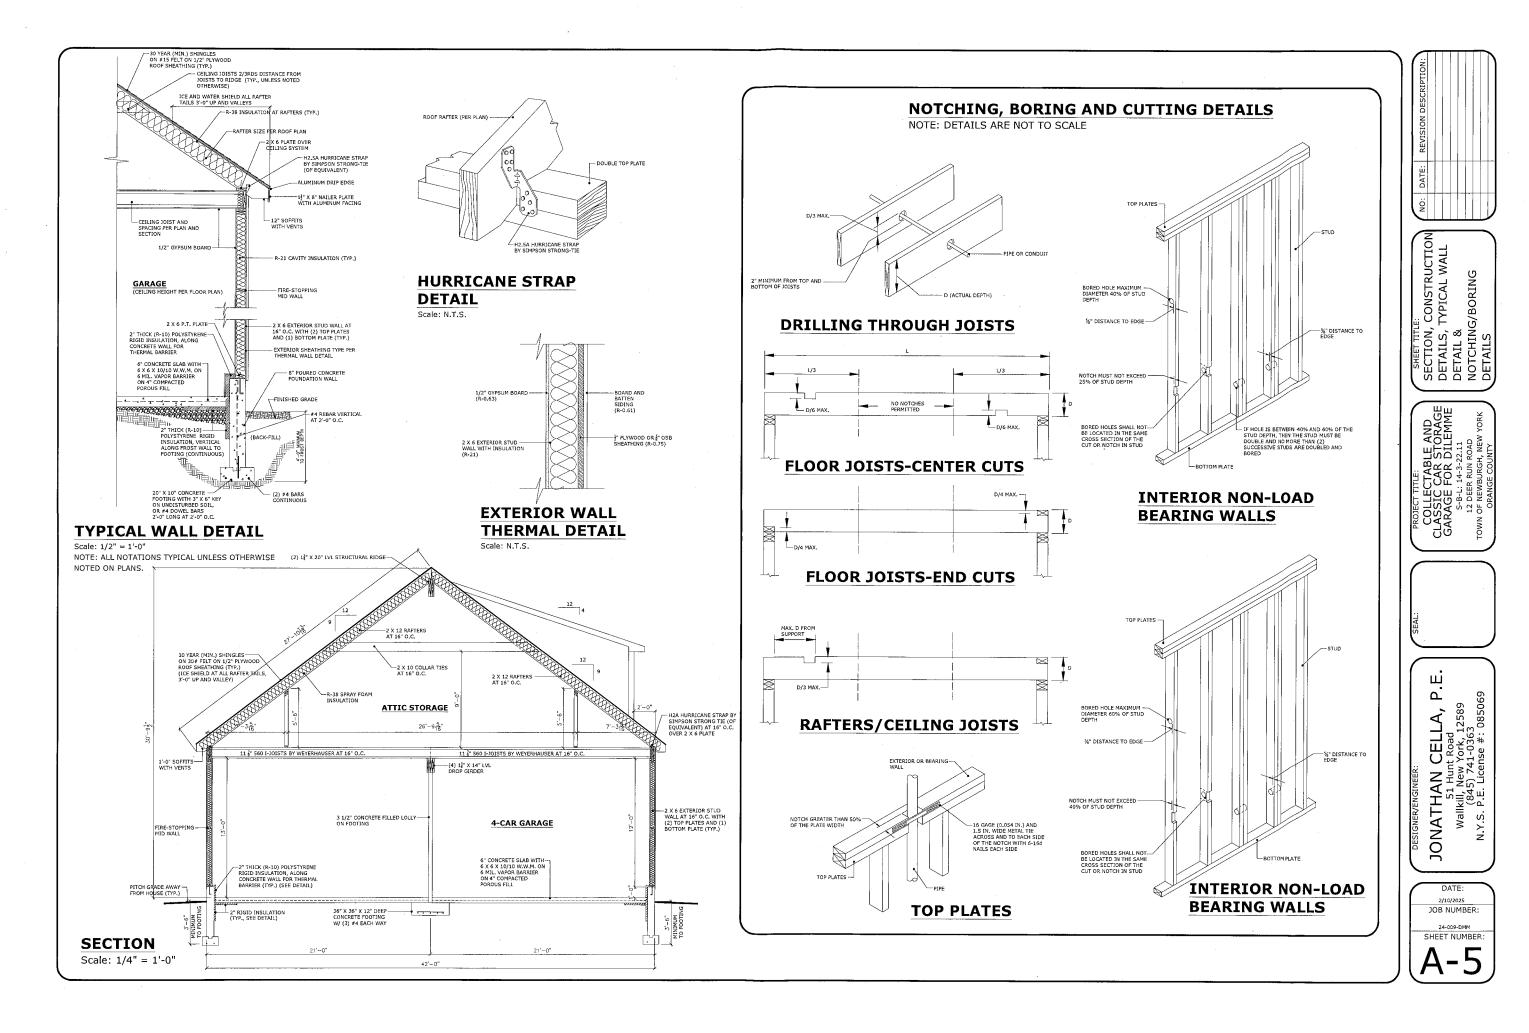

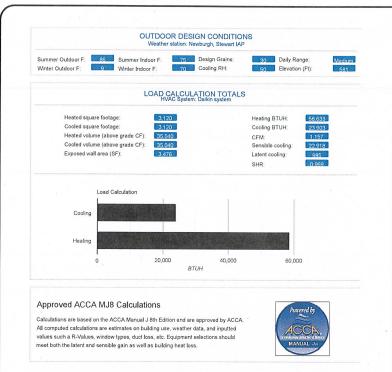


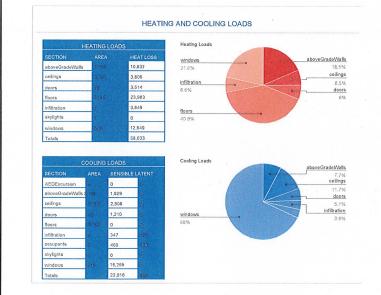




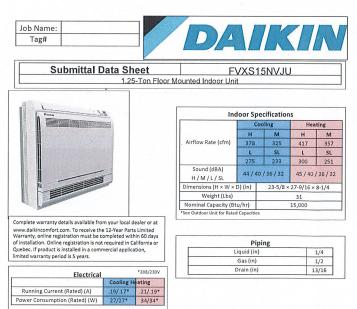

Optional Accessories			
Included Part Number	Description		
BRC944B2	Wired Remote Controller		
BRCW901A08	Wired Remote Controller Cable – 25 ft		
BRCW901A03	Wired Remote Controller Cable – 10ft  Daikin One + Smart Thermostat for Ductless Products  DKN Residential Cloud Wi-Fi Adaptor for Single and Multi-Zone Systems		
DTST-ONE-ADA-A			
AZAI6WSCDKB			
AZAI6WSPDKC	DKN Plus Interface		
KAF968B42	Titanium apatite photocatalytic air-purifying filter WITH frame		
DACA-CP1-1	Inline Condensate Pump (Fits inside all Daikin wall & floor mount units)		
DACA-CP4-1	External Condensate Pump		
KRP928BB2S	Interface Adaptor for DIII-NET		

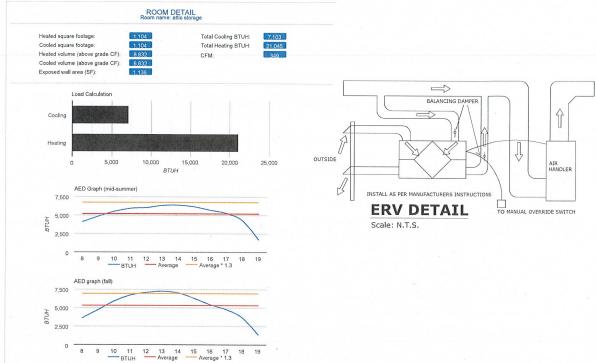

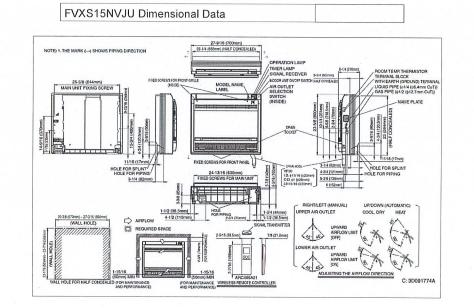




SHEET TITLE:
MECHANICAL
SPECIFICATIONS

CLASSIC CAR STORAGE GARAGE FOR DILEMME S-B-L: 14-3-22.11 12 DEER RUN ROAD TOWN OF NEWBURGH, NEW YORK

P. H. JONATHAN CELLA, P.E. Hunt Road S1 Hunt Road Wallkill, New York, 12589 (845) 741-0363 N.Y.S. P.E. License #: 085069 N.Y.S.

DATE: JOB NUMBER: SHEET NUMBER:

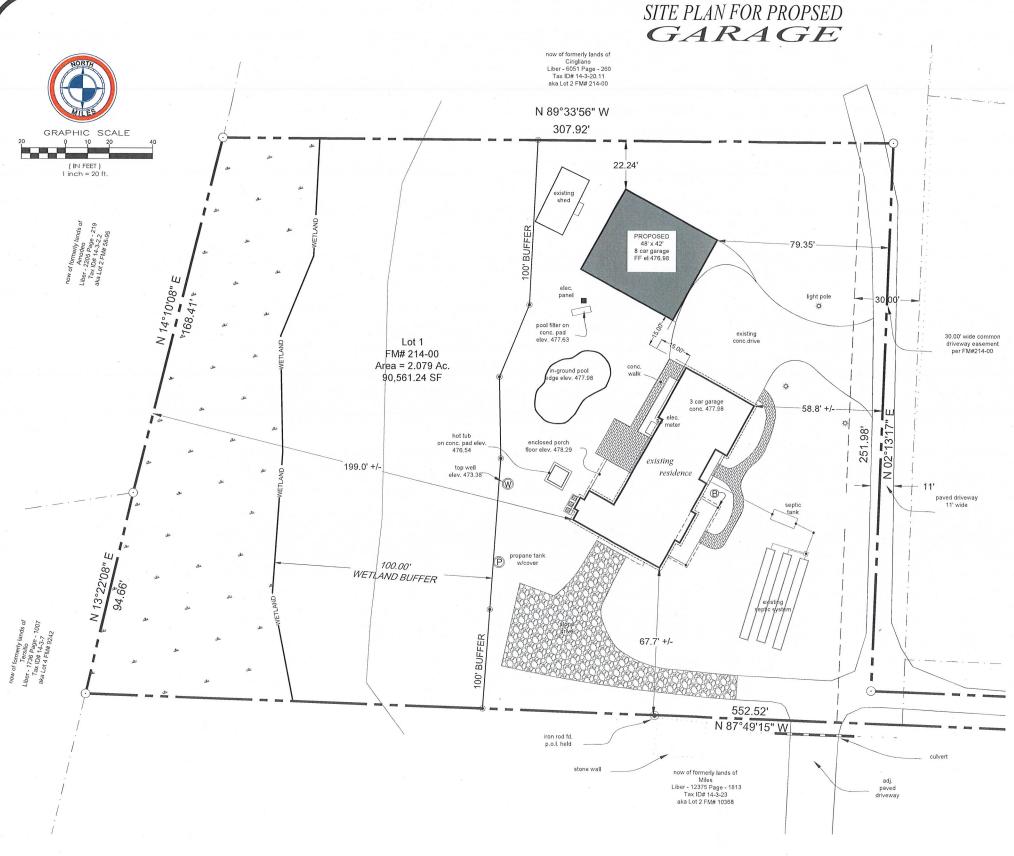

VICINITY MAP

ZONING INFORMATION INGLE FAMILY RESIDENTIAL (R-1)						
	REQUIRED	LOT 1 (EXISTING HOUSE)	LOT 1 PROPOSED GARAGE			
LOT AREA: DWELLING UNITS: 3.5	40,000 SF	90,561 SF	90,561 SF			
LOT WIDTH:	150'	307'	307'			
LOT DEPTH:	150'	267'	267'			
FRONT YARD:	50"	58'	79.35'			
REAR YARD:	40'	199'	199'			
1 SIDE YARD:	30'	67'	22.64'			
BOTH SIDE YARDS:	80'	104'	181'			
HABITABLE FLOOR AREA	: 4,500 SF	4,142 SF	3,345 SF			
LOT BUILDING COVERA	GE: 10%	4.5%	6.8%			
BUILDING HEIGHT:	35'	35'	30' - 9 1/2"			
LOT SURFACE COVERAGE	3E: 20%	8.3%	8.3%			

## ACCESSORY BUILDING INFORMATION

PROPOSED GARAGE: PROPOSED STORAGE: EXISTING SHED: TOTAL: +2016 SF +1329 SF (2ND FLOOR ATTIC INCLUDED) 3,835 SF 2.835 SF VARIANCE REQUESTED - TOTAL ALLOWED: 1000 SF MAX.

(15' - 9 ½" VARIANCE REQUESTED TOTAL ALLOWED: 15' HEIGHT MAX

SETBACK PROPOSED: 26.64' TOTAL REQUIRED: 5'

MAIN BUILDING SETBACK: 22.80' - TOTAL REQUIRED: 10'

185-15 Accessory Building. [Amended 8-16-2010 by L.L. No. 6-2010

AN ACCESSORY USE TO PRINCIPAL RESIDENTIAL USE. AS LISTED IN AN ACCESSORY USE TO PRINCIPAL RESIDENTIAL USE, AS LISTED IN ARTICLE IN. SCHEDULES OF DISTRICT REGULATIONS, USE TABLE, COLUMN A, THAT IS HOUSED WITHIN AN ACCESSORY BUILDING SHALL BE LIMITED TO A MAXIMUM OF 1000 SQUARE FEET OR TO A LOWER NUMBER AS MAY BE DETERMINED BY THE FOLLOWING FORMULA:

 $\frac{A + (B \times C)}{100} = D$ 

90,561 + (4142 X 30) / 100 = 2,148 SF (1,000 MAXIMUM)

PROPOSED GARAGE: 2,016 SF PROPOSED STORAGE: 1329 SF EXISTING SHED: 492 SF

A= GROSS AREA OF LOT IN SQUARE FEET. (90,561 SF)
B= LIVABLE FLOOR AREA OF RESIDENCE IN SQUARE FEET. (4,142 SF)
C= MINIMUM REQUIREMENT IN THE ZONING DISTRICT FOR ONE SIDE D= TOTAL SQUARE FOOTAGE PERMITTED FOR ALL ACCESSORY BUILDINGS.

EXISTING LIVING AREA FIRST FLOOR: 2103 SF SECOND FLOOR: 2039 SF TOTAL: 4142 SF

UNFINISHED BONUS: 572 SF

OWNER'S ENDORSEMENT:

1. THE UNDERSIGNED, HAVE REVIEWED THE CONTENTS OF THIS MAP AND HERBY CONCUR WITH ALL THE TERMS AND CONDITIONS AS STATED HEREON, AND TO THE FILING OF THIS MAP.

NICK DILEMME

# SITE PLAN

Client: Nick Dillemme

O.C.T.M. No. 14-3-22.11

SURVEY OF: LOT 1, FM 214-00 recorded in the Orange County Clerk's Office

12 Deer Run Road Town of Newburgh

County of Orange, New York PROJECT No. 0240071136DD FIELD WORK DATE: May 14, 2024

LAST REVISED: FEB. 12, 2025



SURVEY NOTES:

1. COPYRIGHT 2025 BARAK MILES, ALL RIGHTS RESERVED.

2. UNAUTHORIZED ALTERATION OR ADDITION TO A SURVEY MAP BEARING A LICENSED LAND SURVEYOR'S SEAL IS A VIOLATION OF SECTION 7209, SUB-DIVISION 2, OF THE NEW YORK STATE EDUCATION LAW.

3. ONLY BOUNDARY SURVEY MAP MAPS WITH THE SURVEYOR'S EMBOSSED SEAL ARE GENUINE TRUE AND CORRECT COPIES OF THE SURVEYOR'S ORIGINAL WORK AND OPINION.

4. CERTIFICATIONS ON THIS BOUNDARY SURVEY MAP SIGNIFY THAT THE MAP WAS PREPARED IN ACCORDANCE WITH THE CURRENT EXISTING CODE OF PRACTICE FOR LAND SURVEY'S ADOPTED BY THE NEW YORK STATE ASSOCIATION OF PROFESSIONAL LAND SURVEYORS, INC. THE CERTIFICATION IS LIMITED TO PERSONS FOR WHOM THE BOUNDARY SURVEY MAP.

5. THE CERTIFICATIONS HEREIN ARE NOT TRANSFERRABLE.

6. THE LOCATION OF UNDERGROUND IN PROVEMENTS OR ENCOACHMENTS ARE NOT ALWAYS KNOWN AND OFTEN MUST BE ESTIMATED, IF ANY UNDERGROUND IMPROVEMENTS OR ENCOACHMENTS OR ENCROACHMENTS OR ENCROACHMENTS ARE NOT COVERED BY THIS CERTIFICATE.

5. BASIS OF BEARINGS DETERMINED BY GROSS BASETACT OF TITLE. SUBJECT TO ANY UPTO DATE AS BASETACT OF TITLE. SUBJECT TO ANY OF SOBERS BASET BASET.

5. BASIS OF BEARINGS DETERMINED BY GROSS BASET ACTION OF UNDERGROUND UTLITIES AND EXCENSED THE LAND.